

13190 SW 68th Parkway, Suite 150  
Tigard, Oregon 97223  
503.968.6655 www.cesnw.com  
CESNW PROJ: 2869  
DATE: 7-22-2013

KENTHORPE TRACTS  
(UNRECORDED)

31 DOCUMENT NO.  
91-48707  
S 89°41'35" E 120.04'

30 DOCUMENT NO.  
2000-015829

PARTITION PLAT  
NO. 1990-86  
PARCEL 3

PARTITION PLAT  
NO. 1991-85  
PARCEL 3

27

**LEGEND**

- CATCH BASIN
- WATER VALVE
- WATER METER
- SANITARY SEWER MANHOLE
- STORM DRAIN MANHOLE
- CLEAN OUT
- IRRIGATION CONTROL VALVE
- GAS VALVE
- GAS METER
- MAIL BOX
- LUMINAIRE
- TV RISER
- TELEPHONE RISER
- SIGNAL JUNCTION BOX
- ELECTRIC METER
- ELECTRIC JUNCTION BOX
- UTILITY POLE
- GUY ANCHOR
- FIRE HYDRANT
- SIGN
- LINE CONTINUES TO UNKNOWN LOCATION
- E - UNDERGROUND ELECTRIC LINE
- ST - UNDERGROUND STORM DRAIN LINE
- SS - UNDERGROUND SANITARY SEWER LINE
- T - UNDERGROUND TELEPHONE LINE
- TV - UNDERGROUND CABLE TV LINE
- W - UNDERGROUND WATER LINE
- G - UNDERGROUND NATURAL GAS LINE
- OH - OVERHEAD UTILITY LINE
- ○ - FENCE LINE
- SMH - SANITARY SEWER MANHOLE
- DMH - STORM DRAIN MANHOLE
- CB - CATCH BASIN
- FI - FIELD INLET

- CONCRETE
- ASPHALT

- DECIDUOUS TREE (DTR)
- EVERGREEN TREE (ETR)

EXAMPLE  
12" DTR 5  
DIAMETER TYPE  
NO. OF TREES FROM ONE BASE

MAPLE GROVE  
(PLAT NO. 639)DOCUMENT NO.  
90-20246

DOCUMENT NO. XX

N 00°19'33" E 250.14'

TOP OF BANK

TOE OF BANK

CARPORT

TOP OF BANK

TOP OF BANK  
TOE OF BANK  
TOE OF BANK  
PARTITION PLAT  
NO. 1990-86  
PARCEL 3

TOP OF BANK  
DOCUMENT NO.  
95-051207  
TOP OF BANK  
PARTITION PLAT  
NO. 1991-85  
PARCEL 3

TOP OF BANK  
N 00°14'08" E 109.93'

TOP OF BANK  
PARCEL 3

TOP OF BANK  
N 00°14'08" E 109.93'

TOP OF BANK  
PARCEL 3

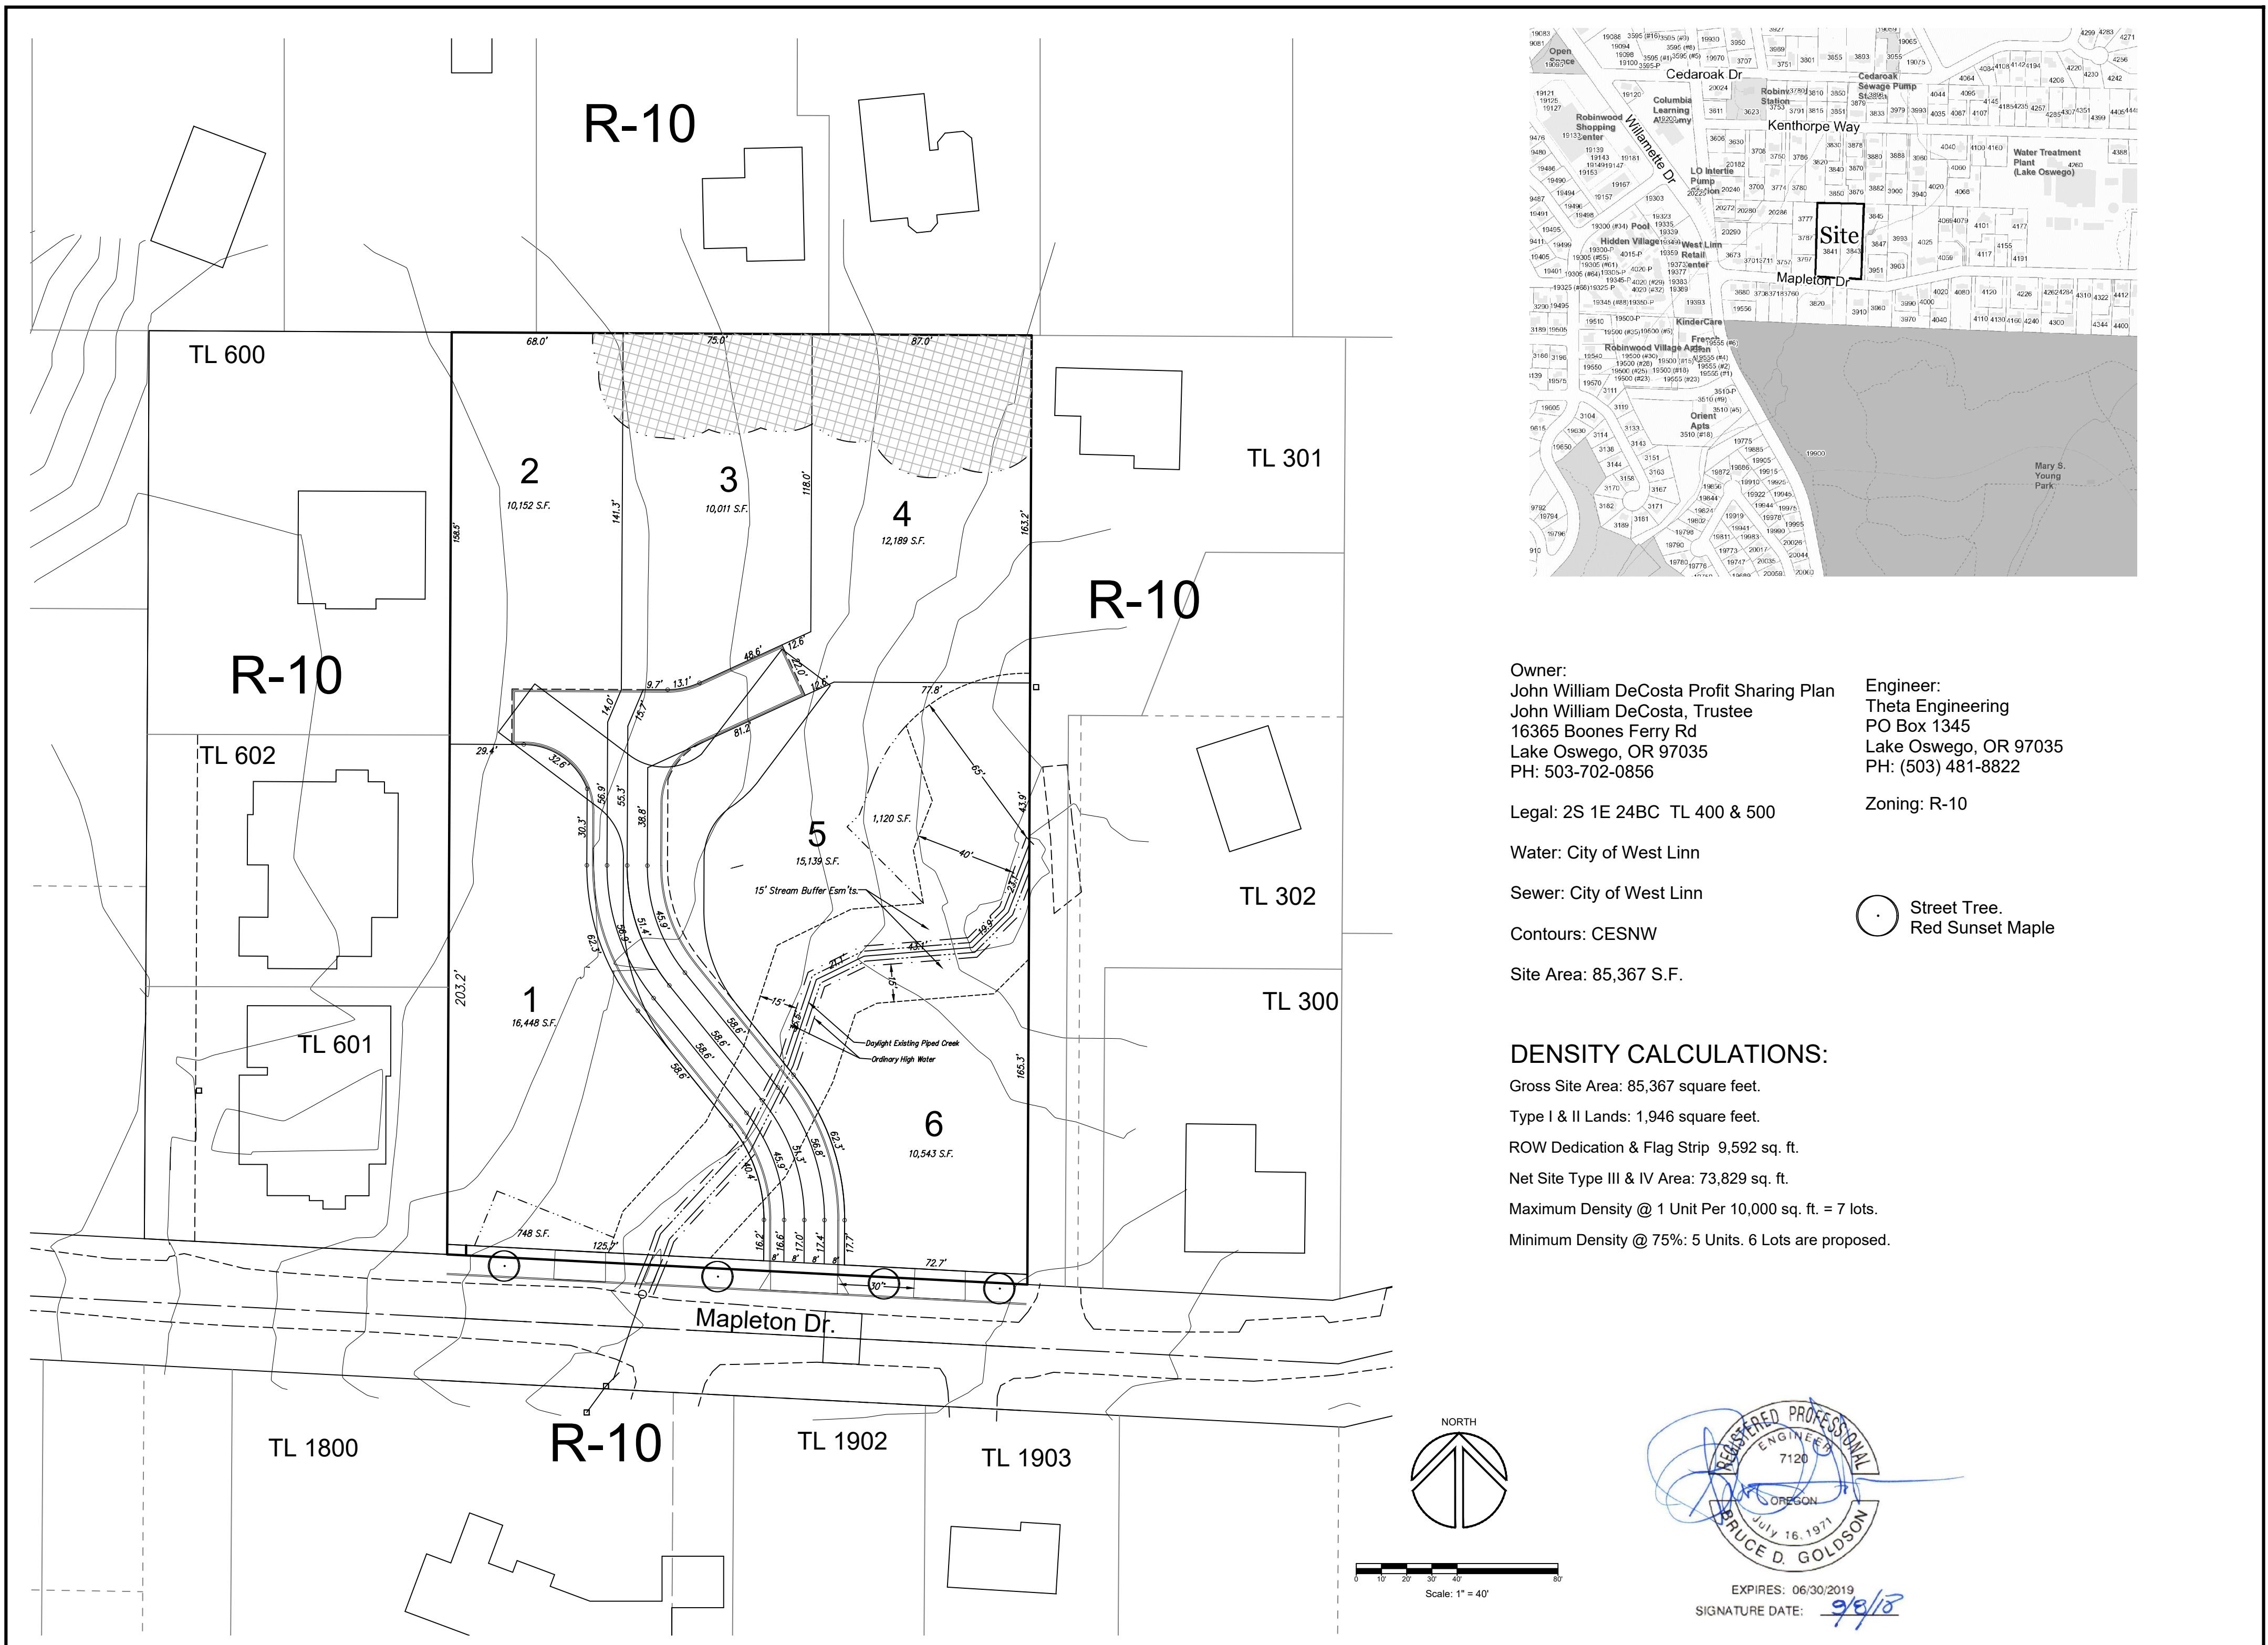



DESIGNED:	REG	10-5-18	1	Revised layout to provide better building envelope on Lot 4.
DRAWN:	REG			
SCALE:	1" = 40'			
DATE:	September 2018			
FILE:	16-ICN-103	DATE	NO.	REVISION

Richard E. Givens, Planning Consultant  
18680 Sunblaze Dr.  
Oregon City, OR 97045  
PH: (503) 479-0097


APPLICANT: Icon Construction & Development, LLC  
1980 Willamette Falls Drive, Suite 200  
West Linn, OR 97068  
PH: (503) 657-0406

Trillium Creek  
Tentative Plan


SHEET:  
1/3

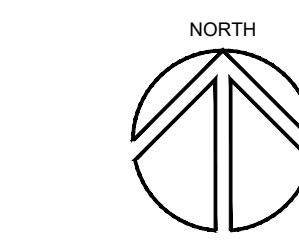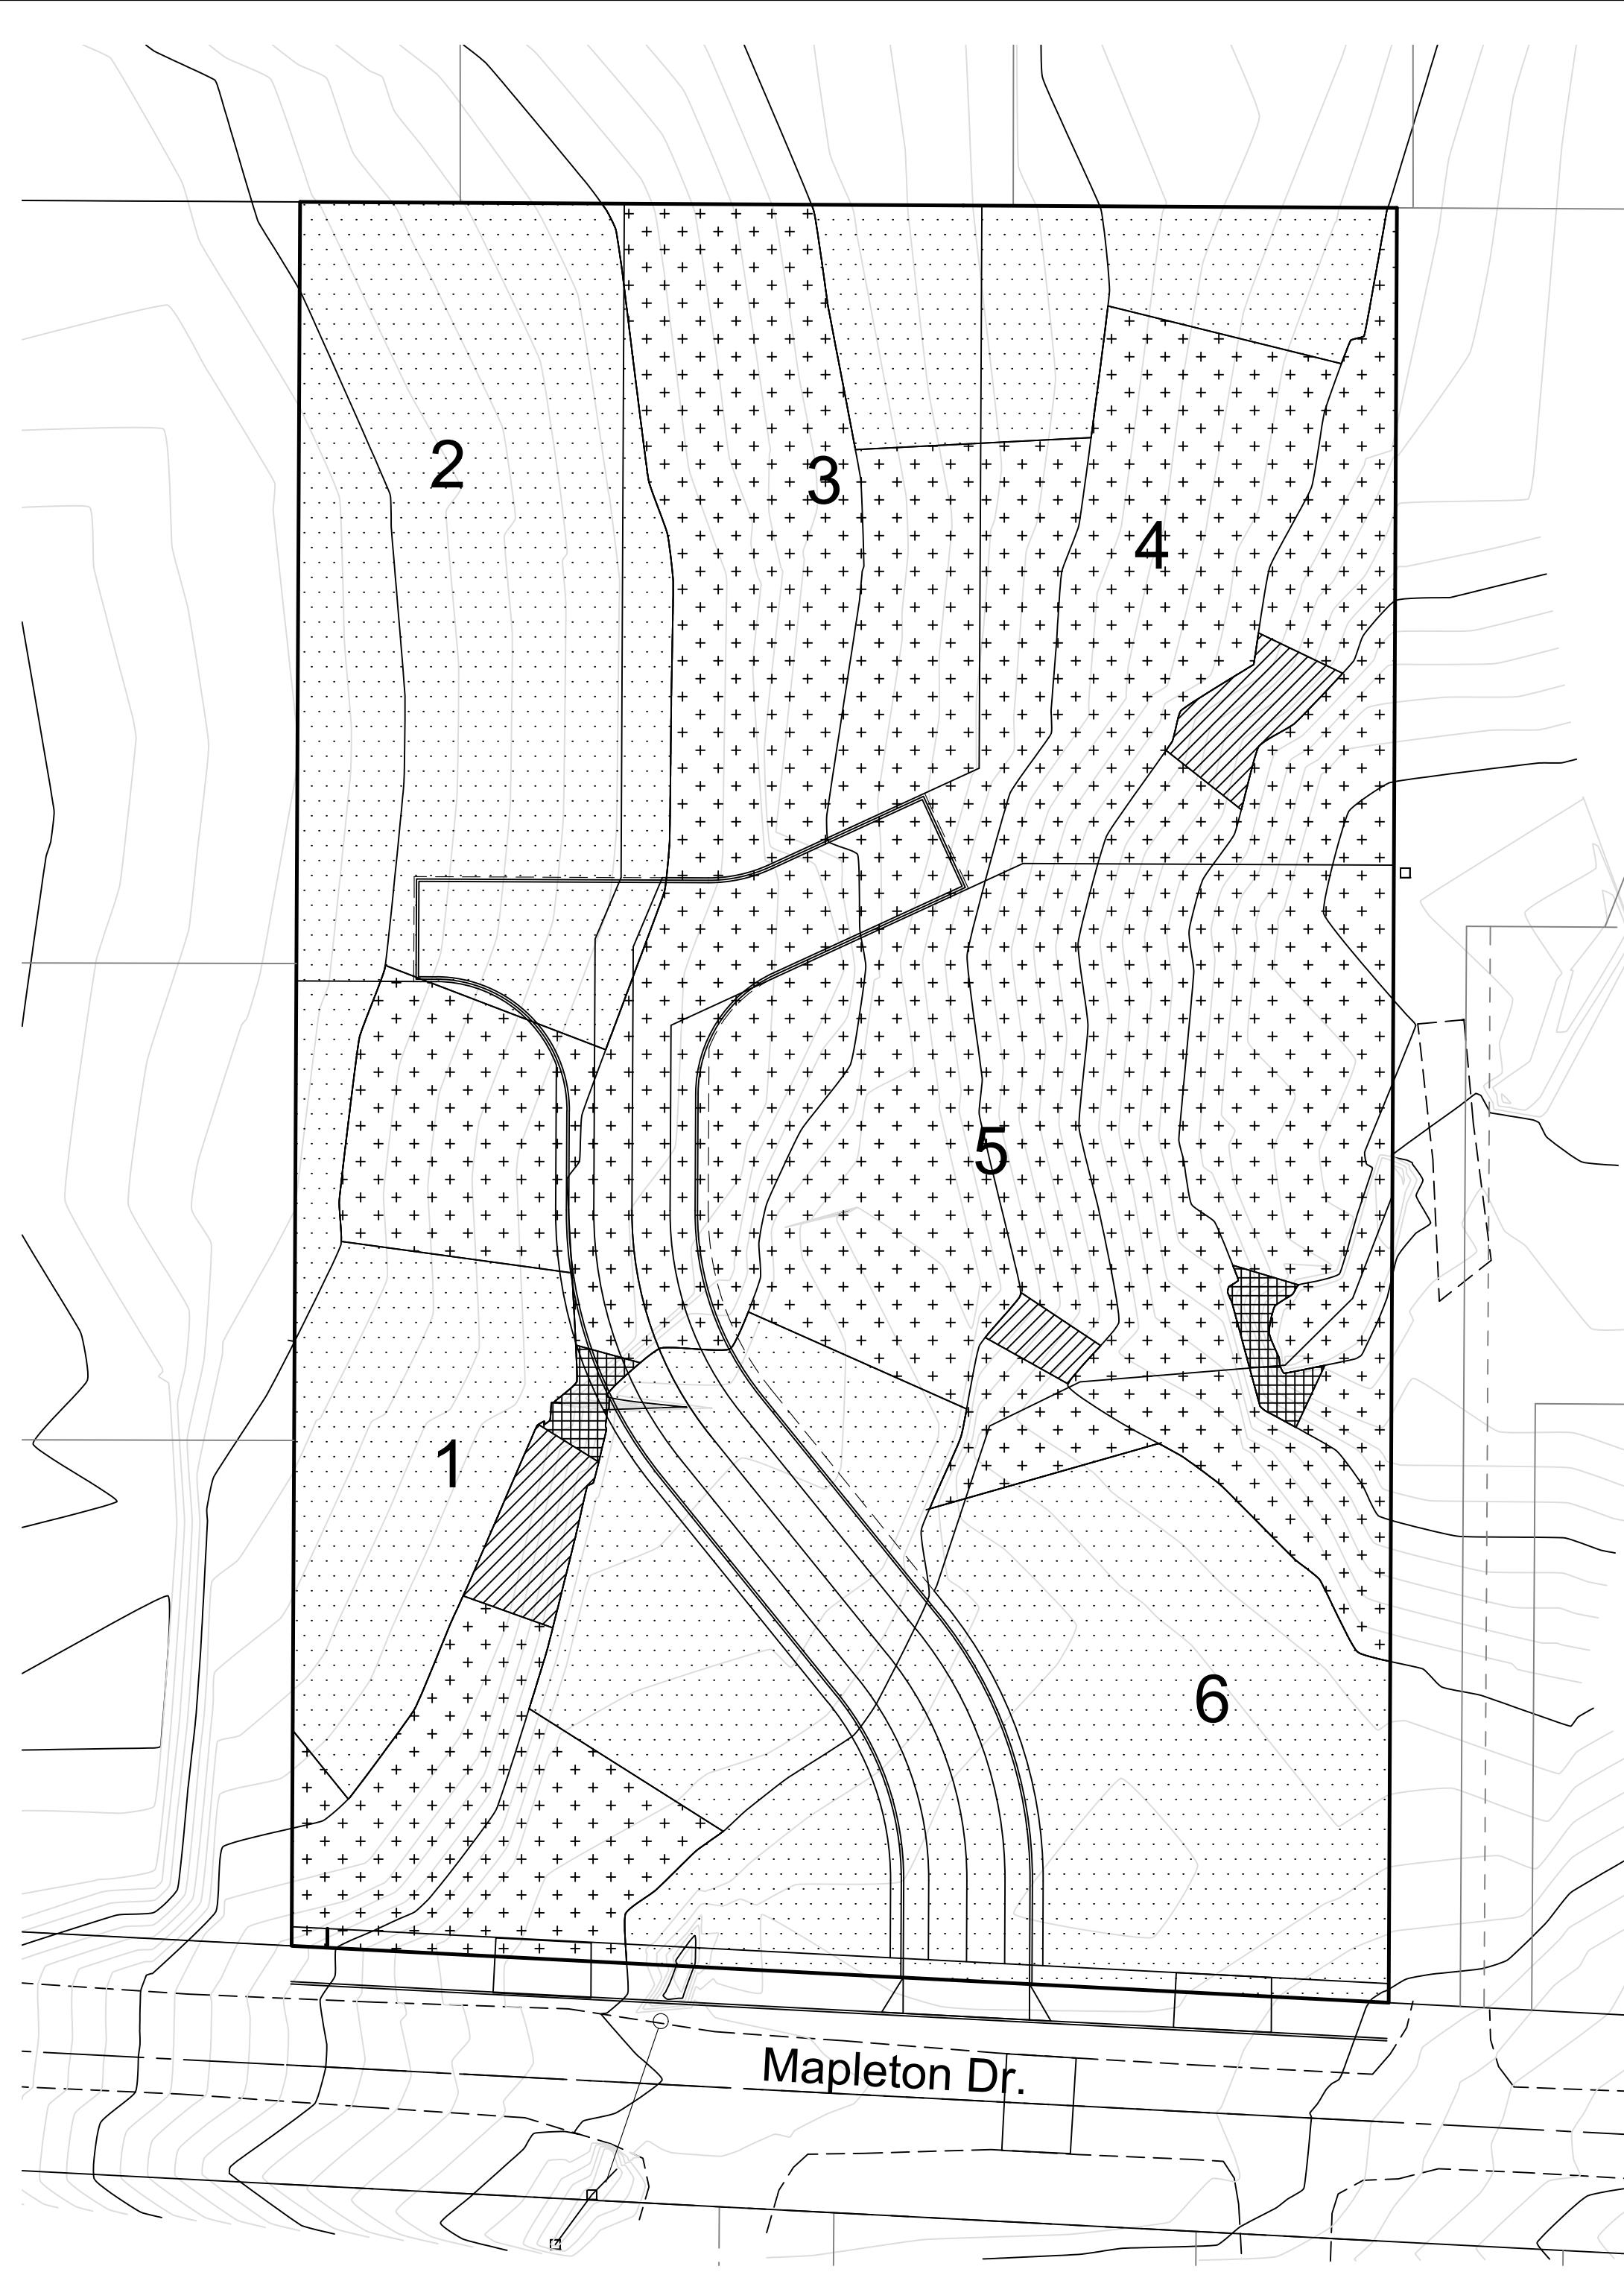


scale: 1" = 30'  
0 15 30 60

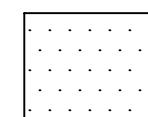


Slopes 0-10% (Type IV Land)  
40,701 sq. ft. (47.7% of site)  
- sq. ft. of this is within street.

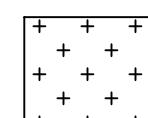

Slopes 10-25% (Type III Land)  
42,715 sq. ft. (50% of site)  
- sq. ft. of this is within street.

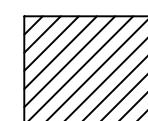

Slopes 25-35% (Type II Land)  
1,436 sq. ft. (1.7% of site)  
0 sq. ft. of this is within street.

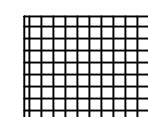

Slopes 35% Plus (Type I Land)  
510 sq. ft. (0.6% of site)  
0 sq. ft. of this is within street.


DESIGNED:	REG	10-5-18	1	Revised layout to provide better building envelope on Lot 4.
DRAWN:	REG			
SCALE:	1" = 30'			
DATE:	September 2018			
FILE:	16-ICN-103	DATE	NO.	REVISION

Richard E. Givens, Planning Consultant  
18680 Sunblaze Dr.  
Oregon City, OR 97045  
PH: (503) 479-0097

APPLICANT:  
Icon Construction & Development, LLC  
1980 Willamette Falls Drive, Suite 200  
West Linn, OR 97068  
PH: (503) 657-0406




**Trillium Creek**  
Slope Analysis

SHEET:  
2/3

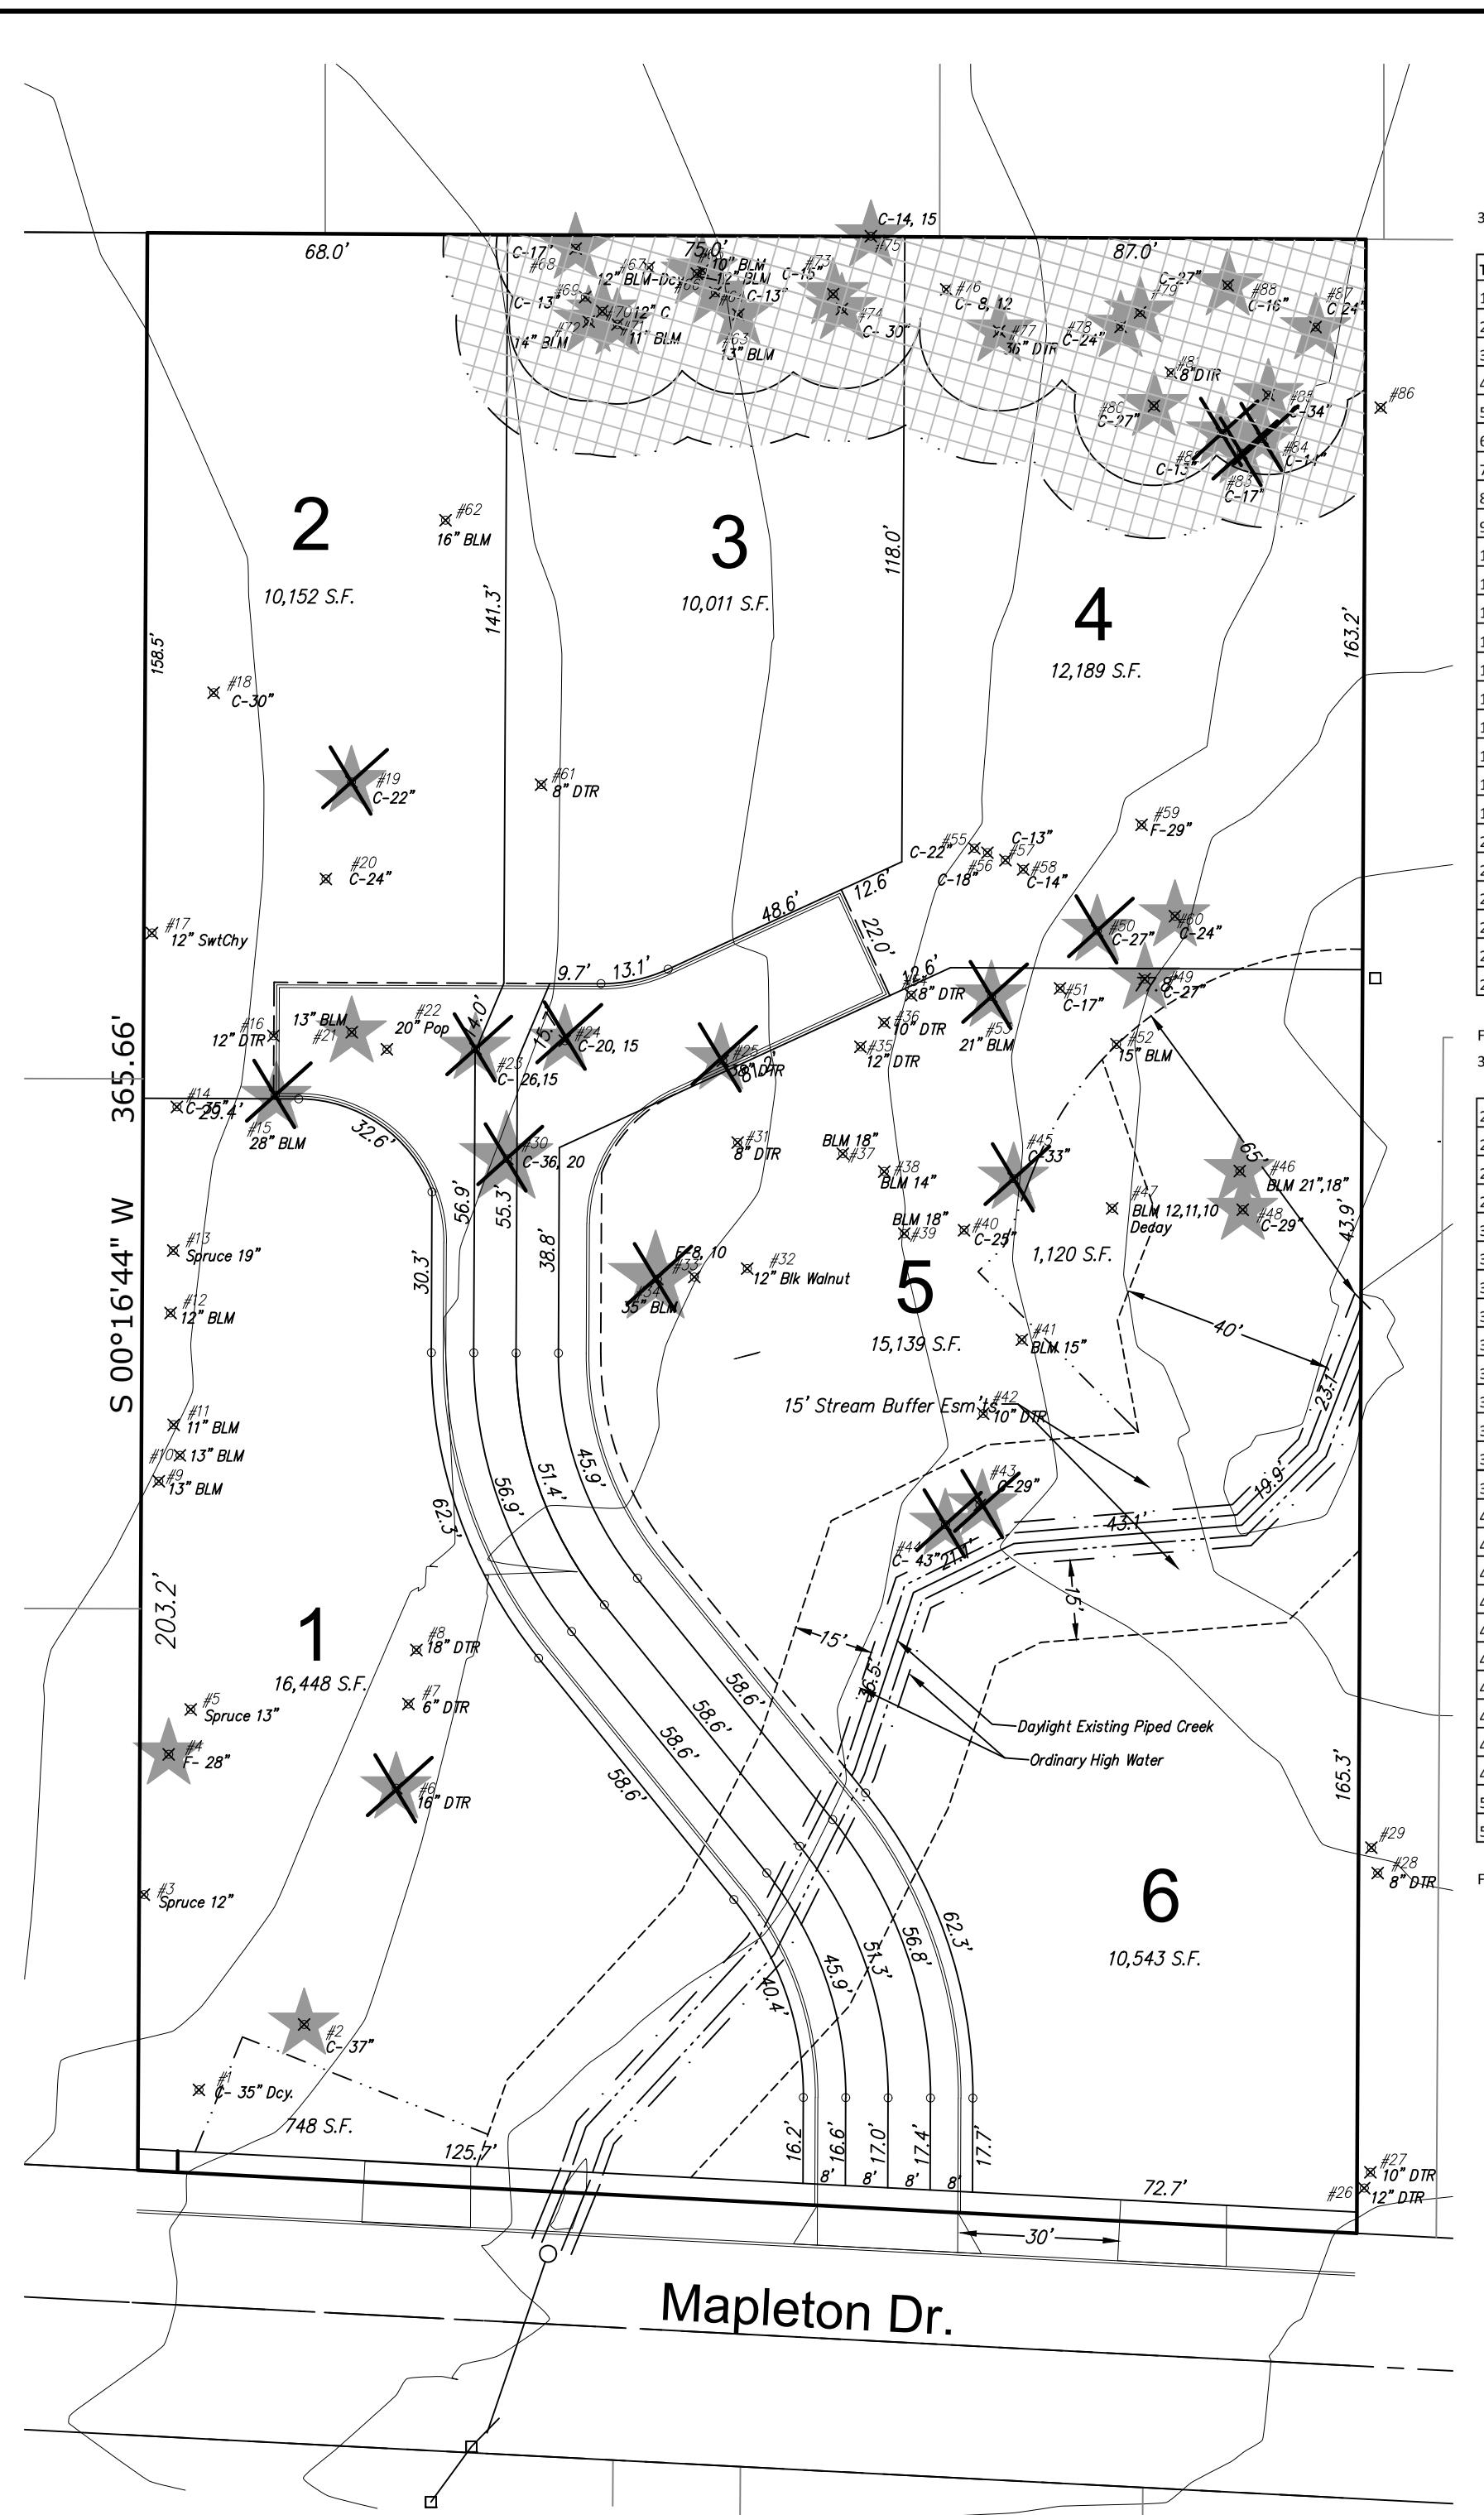


3843 Mapleton, West Linn					West Linn					Trees are 12-inch diameter. Pac. Dog, madrone, Garry oak are 6-inch diameter.					3843 Mapleton, West Linn					West Linn					
Tag	Species	Diameter	Rating	Condition	Tag	Species	Diameter	Rating	Condition	Tag	Species	Diameter	Rating	Condition	Tag	Species	Diameter	Rating	Condition	Tag	Species	Diameter	Rating	Condition	
1	western redcedar	35	1	low trunk and base is hollow; nestin activity in trunk; clorotic; Biltmore stick	52	bigleaf maple	15	1	grew from fallen tree after soil failure; Biltmore stick	53	bigleaf maple	21	2	viable; dead branches; broken cedar hung up in crown; Biltmore stick	54	bigleaf maple	10,10	2	viable; codominant from base; Biltmore stick	55	western redcedar	22	2	viable; hedgerow; Biltmore stick	
2	western redcedar	37	2	viable; dead branches; Biltmore stick	56	western redcedar	18	2	viable; hedgerow; Biltmore stick	57	western redcedar	13	2	viable; hedgerow; Biltmore stick	58	western redcedar	14	2	viable; hedgerow; Biltmore stick	59	grand fir	29	2	viable	
3	Sitka spruce	12	2	viable; dead branches	60	western redcedar	24	2	viable	61	black cottonwood	20	2	viable; Biltmore stick	62	bigleaf maple	16	2	viable; Biltmore stick; added	63	bigleaf maple	13	2	viable; Biltmore stick; ivy	
4	Douglas fir	28	2	viable; dead branches	64	western redcedar	13	2	viable	65	bigleaf maple	13	2	viable	66	bigleaf maple	12	2	viable	67	bigleaf maple	13	0	advanced trunk decay	
5	Sitka spruce	13	2	viable; dead branches	68	western redcedar	17	2	viable	69	western redcedar	13	0	dead	70	western redcedar	12	2	viable; added	71	bigleaf maple	11	2	viable; added	
6	bigleaf maple	22	2	viable; dead branches; Biltmore stick	72	bigleaf maple	14	2	viable; added	73	western redcedar	15	2	viable; added	74	western redcedar	30	2	viable; Biltmore stick	75	western redcedar	29	2	viable; on property line on neighbor's side of fence; Biltmore stick	
7	English hawthorn	12	2	nuisance species; Biltmore stick	76	western redcedar	11	2	undersize	77	bigleaf maple	36	1	ivy infestation											
8	bigleaf maple	24	1	chlorotic; low vigor; wound on trunk; trunk decay; Biltmore stick																					
9	bigleaf maple	13	1	terminal decline																					
10	bigleaf maple	13	1	chlorotic; low vigor																					
11	bigleaf maple	12	1	chlorotic; low vigor																					
12	bigleaf maple	12	1	chlorotic; low vigor																					
13	Sitka spruce	19	2	viable; dead branches																					
14	western redcedar	35	2	viable; ivy																					
15	bigleaf maple	28	2	viable; ivy																					
16	sweet cherry	15	2	nuisance species																					
17	sweet cherry	14	1	nuisance species; terminal decline																					
18	western redcedar	30	2	viable; 100% live crown ration																					
19	western redcedar	22	2	viable; 100% live crown ration; Biltmore stick																					
20	western redcedar	24	2	codominant stems at 4'																					
21	bigleaf maple	13	1	shedding bark on main stem; ivy; Biltmore stick																					
22	tulip poplar	20	2	codominant stems at 3; Biltmore stick																					
23	western redcedar	32	2	mechanical damage to buttress roots																					
24	western redcedar	32	2	mechanical damage to buttress roots																					
25	dead	43	2	dead																					

Field work done on 7/26/2018 and 7/27/2018 by Ryan Neumann-PN-5539A, TRAQ certified					West Linn					Field work done on 7/26/2018 and 7/27/2018 by Ryan Neumann-PN-5539A, TRAQ certified					West Linn					Field work done on 7/26/2018 and 7/27/2018 by Ryan Neumann-PN-5539A, TRAQ certified				
Tag	Species	Diameter	Rating	Condition	Tag	Species	Diameter	Rating	Condition	Tag	Species	Diameter	Rating	Condition	Tag	Species	Diameter	Rating	Condition	Tag	Species	Diameter	Rating	Condition
26	bigleaf maple	19	2	offsite; pruned for high-voltage	78	western redcedar	24	2	viable	79	western redcedar	27	2	viable	80	western redcedar	27	2	viable	81	bigleaf maple	13	0	advanced stem decay
27	bigleaf maple	15	2	offsite	82	western redcedar	13	2	viable	83	western redcedar	17	2	viable	84	western redcedar	14	2	viable	85	western redcedar	34	2	viable; ivy
28	red alder	8	1	undersize; offsite; decline	86	grand fir	38	2	viable; approximately 3' offsite in neighbor's yard; added	87	western redcedar	24	2	viable; ivy	88	western redcedar	16	2	viable; ivy; added					
29	red alder	8	1	undersize; offsite; decline																				
30	western redcedar	41	2	mechanical damage to one root flare																				
31	bigleaf maple	13	2	viable; minor wound on trunk																				
32	black walnut	12	2	viable																				
33	grand fir	16	2	viable																				
34	bigleaf maple	35	2	viable; ivy																				
35	bigleaf maple	17	1	top of tree is dying																				
36	bigleaf maple	13	1	cavity; trunk decay; excessive lean																				
37	bigleaf maple	18	2	viable																				
38	bigleaf maple	14	2	viable					</td															

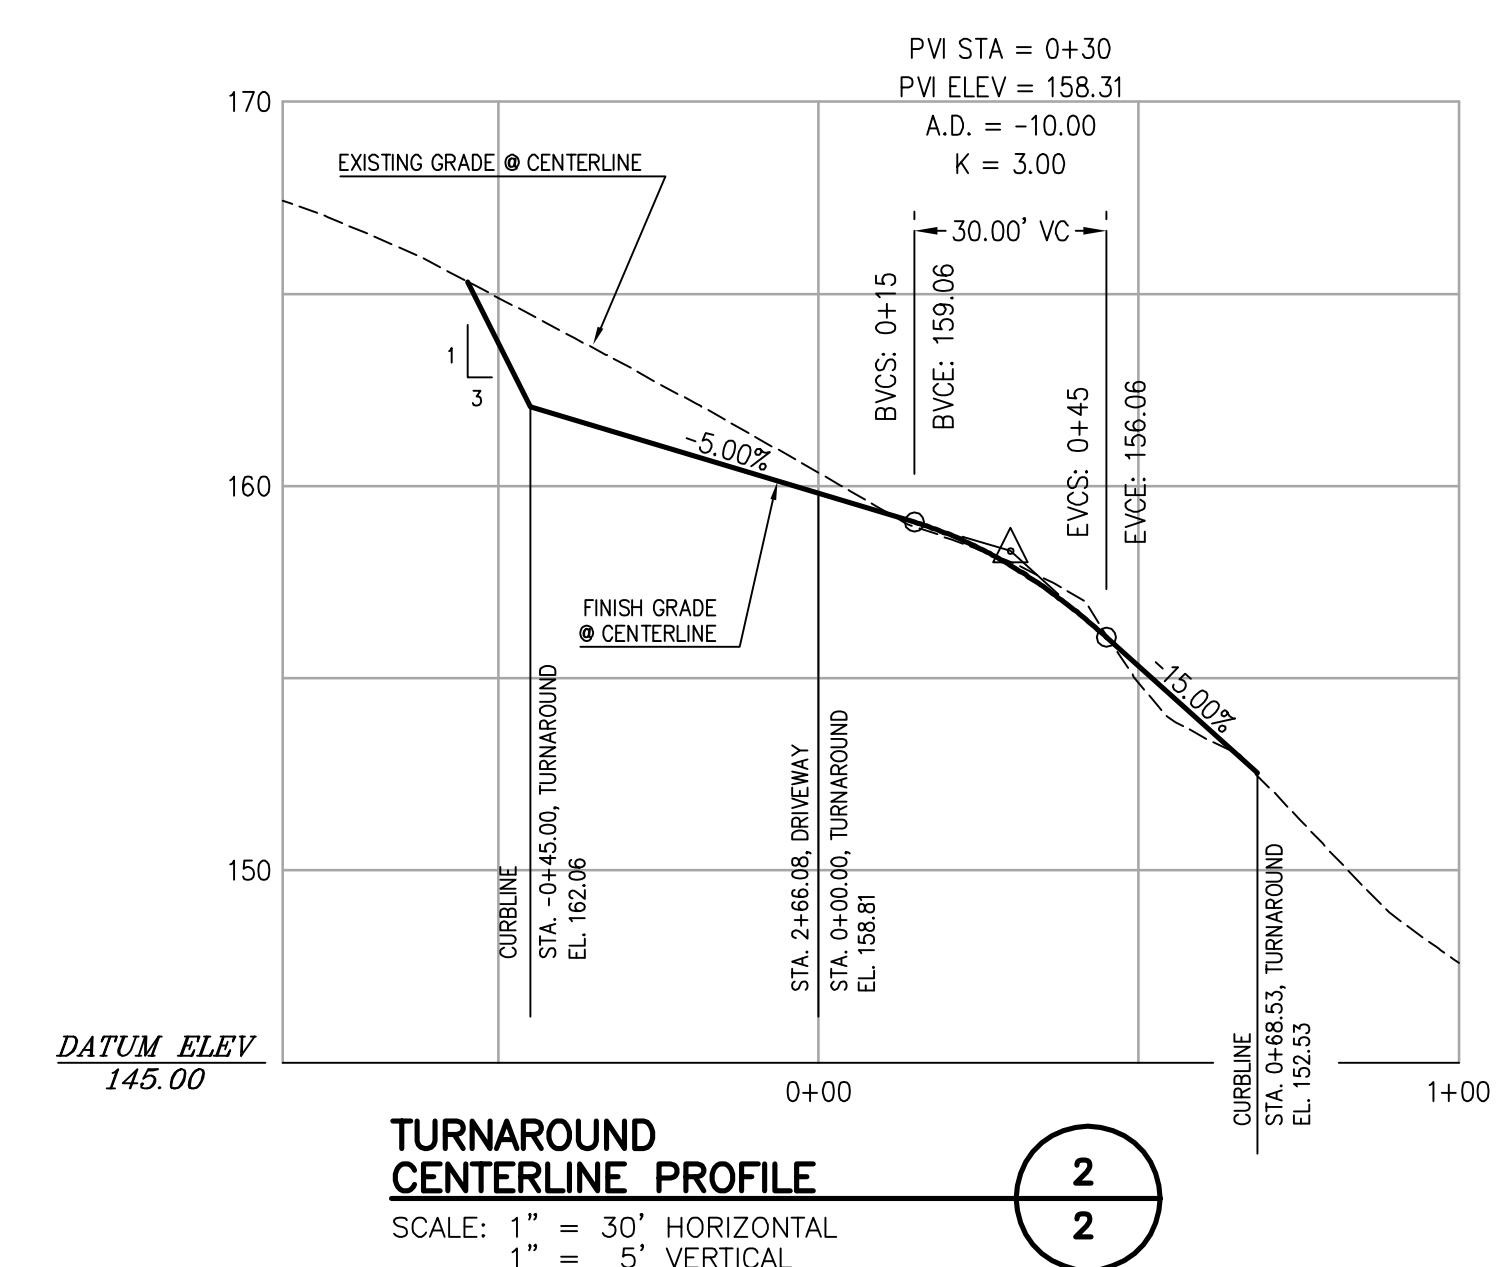
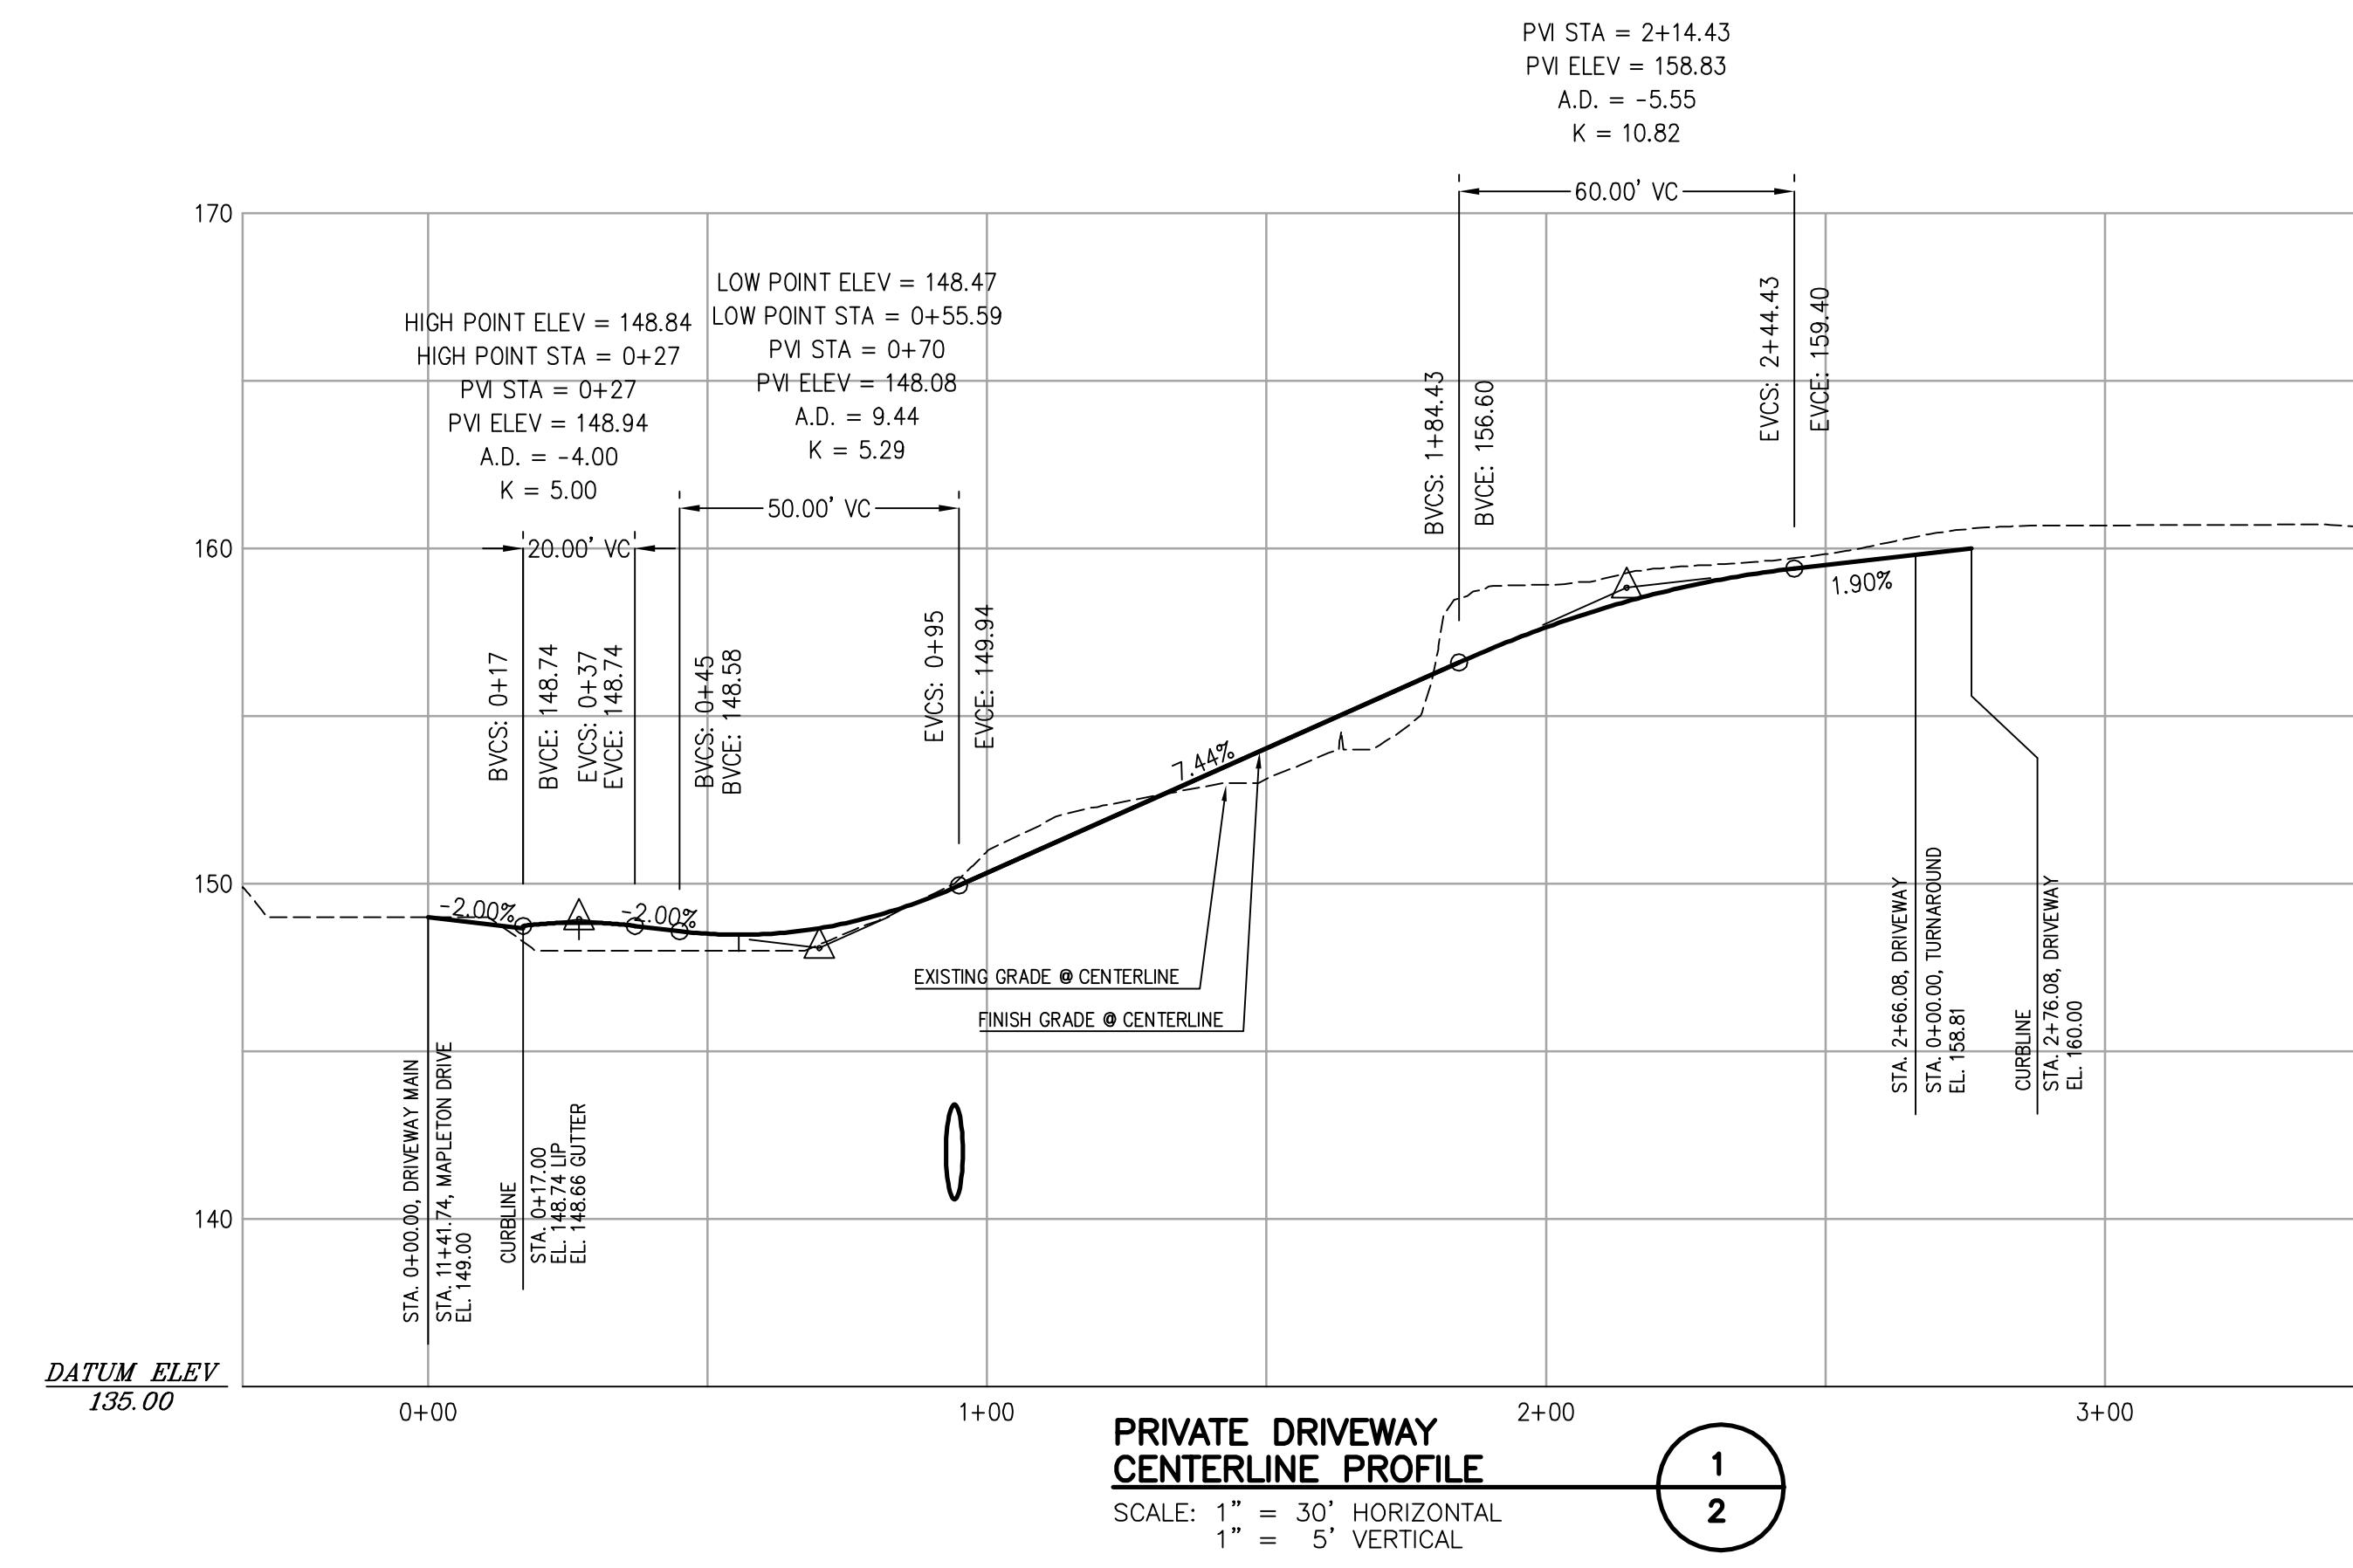
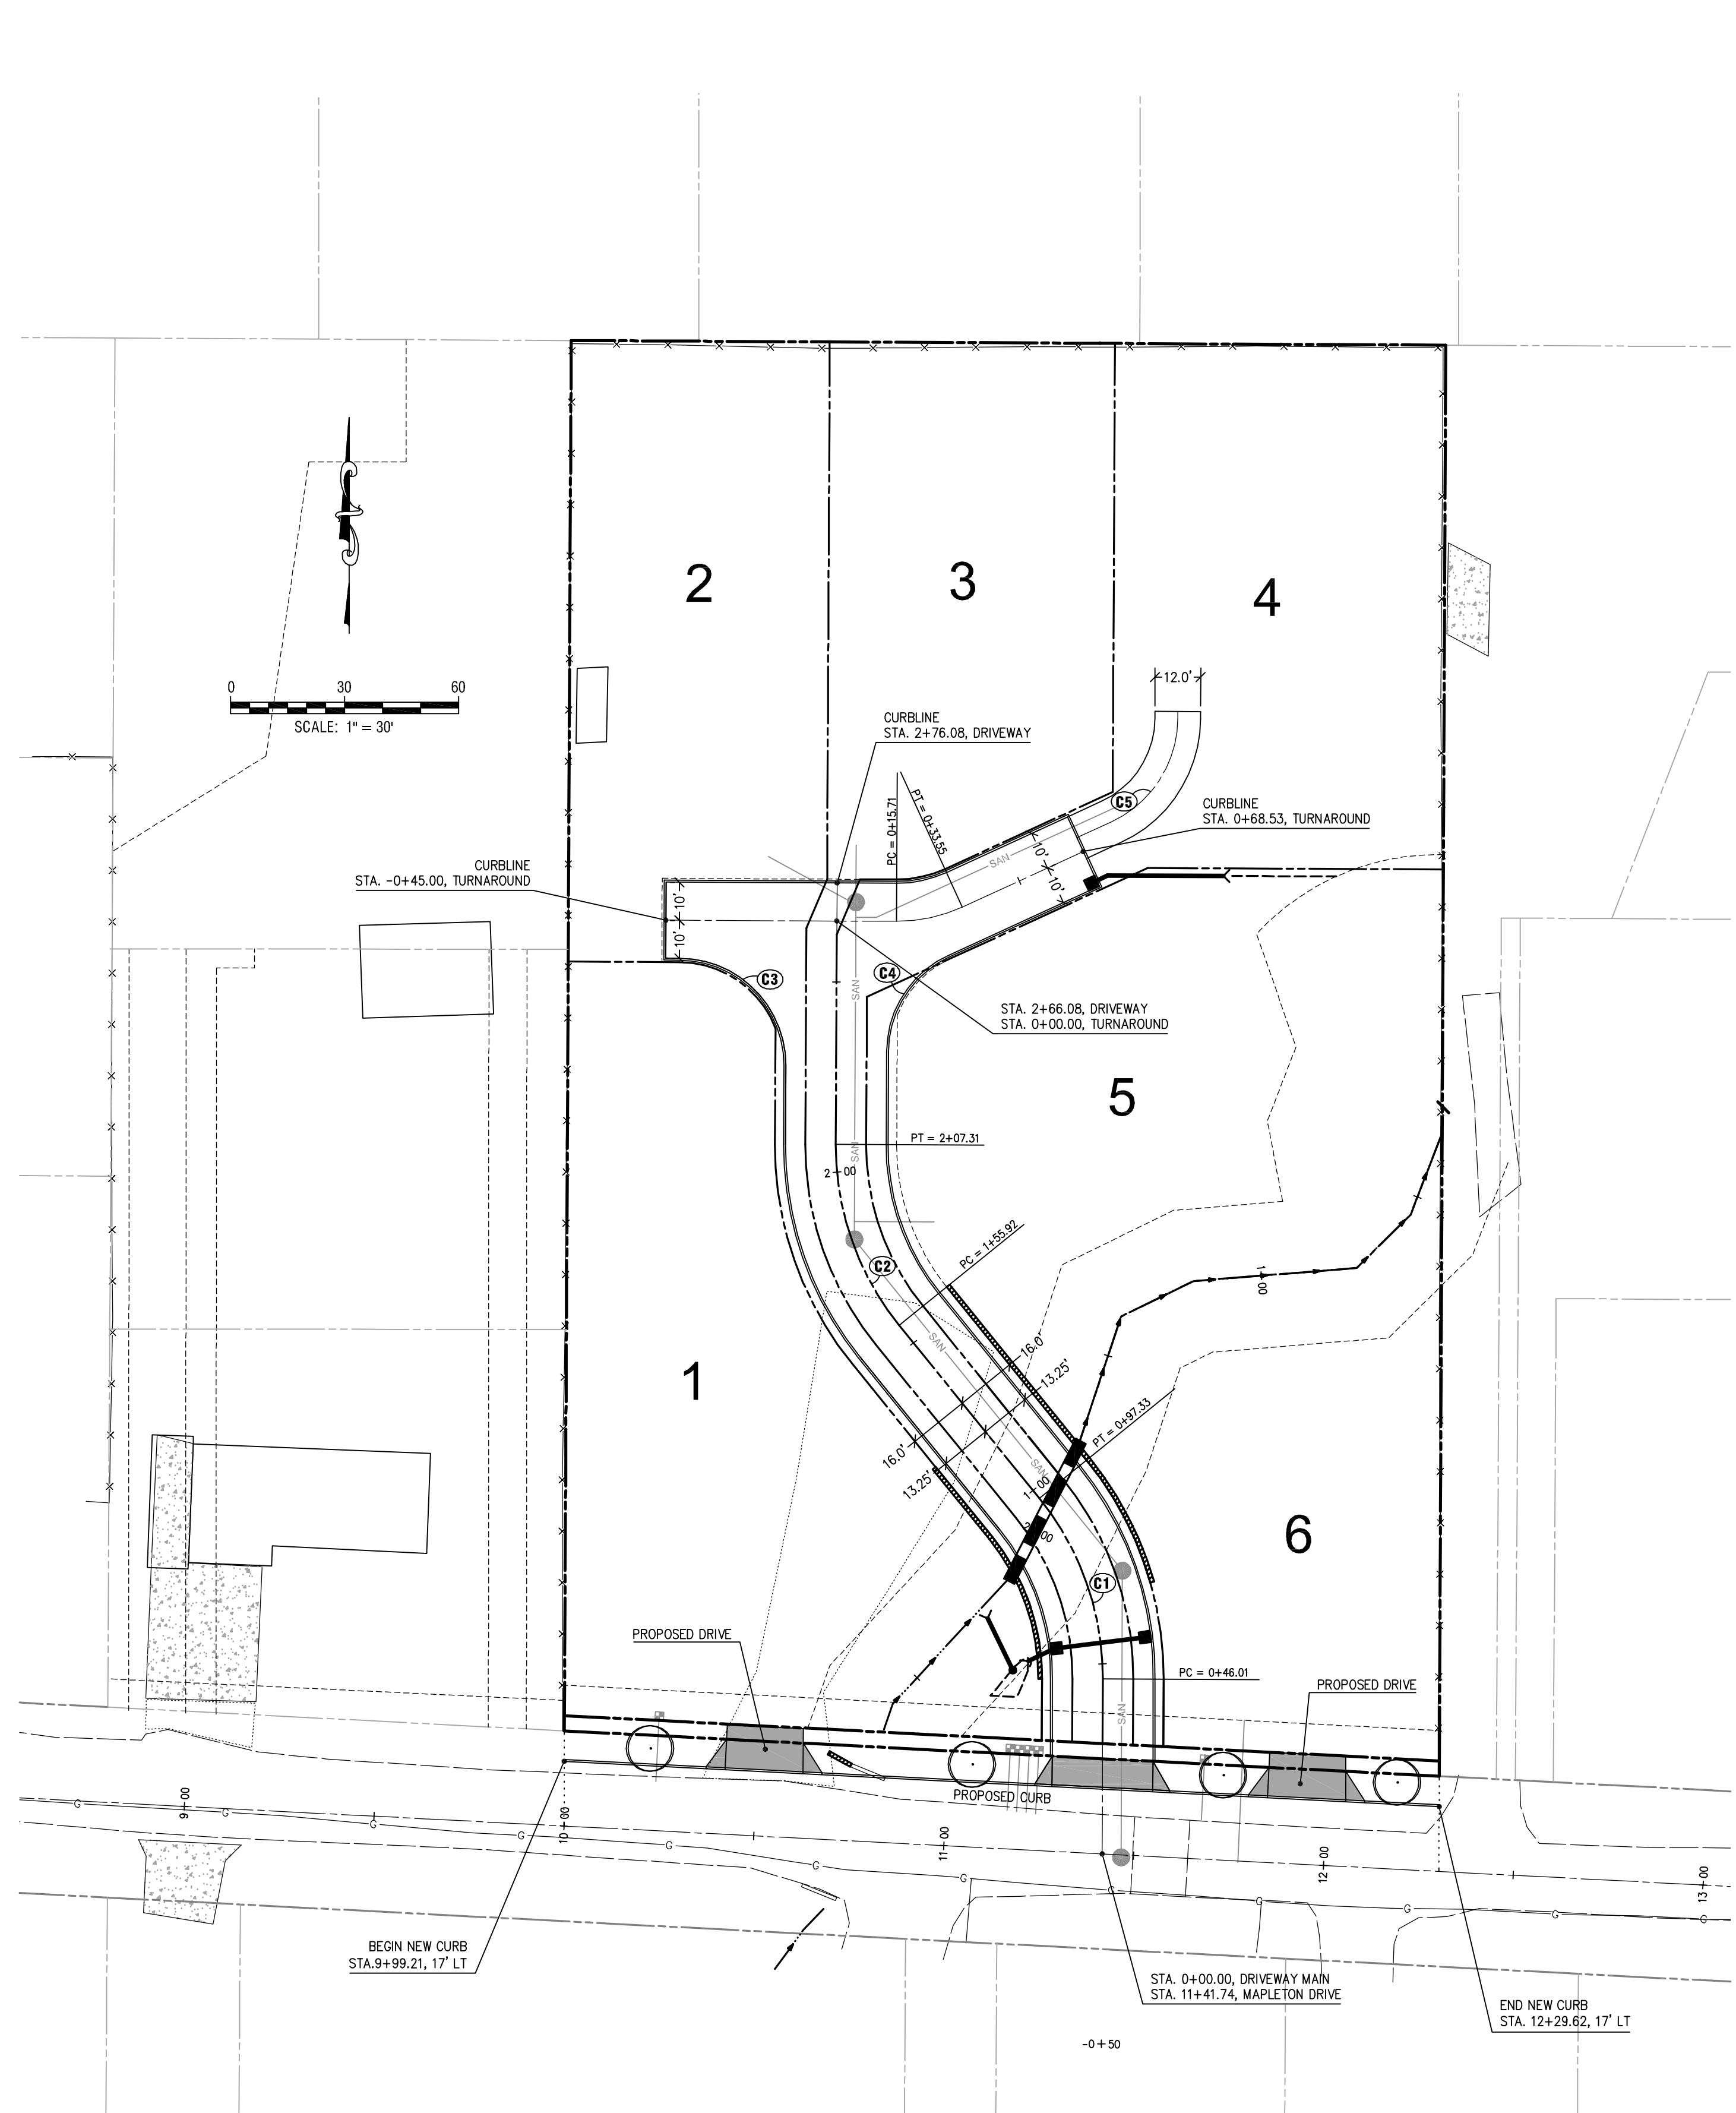


CURVE TABLE						
CURVE	RADIUS	LENGTH	TANGENT	CHORD	BEARING	DELTA
C1	75.00	51.33	26.71	50.33	N19°22'09" W	39°12'34"
C2	75.00	51.38	26.75	50.38	S19°20'52" E	39°15'10"
C3	28.00	43.99	28.01	39.60	N44°43'47" W	90°01'02"
C4	28.00	31.79	17.85	30.11	S32°47'59" W	65°02'31"
C5	30.00	34.06	19.13	32.26	N32°47'59" E	65°02'31"

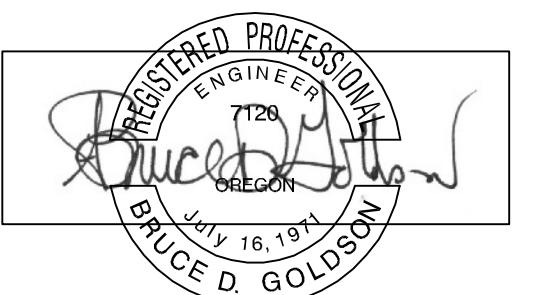

EXPIRES: 06/30/2019


SIGNATURE DATE: 10/05/2018

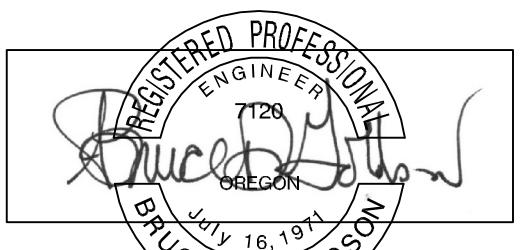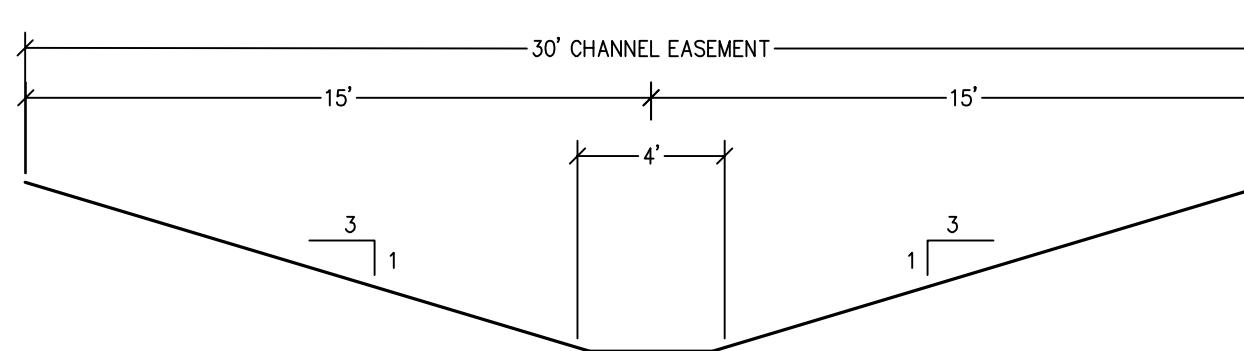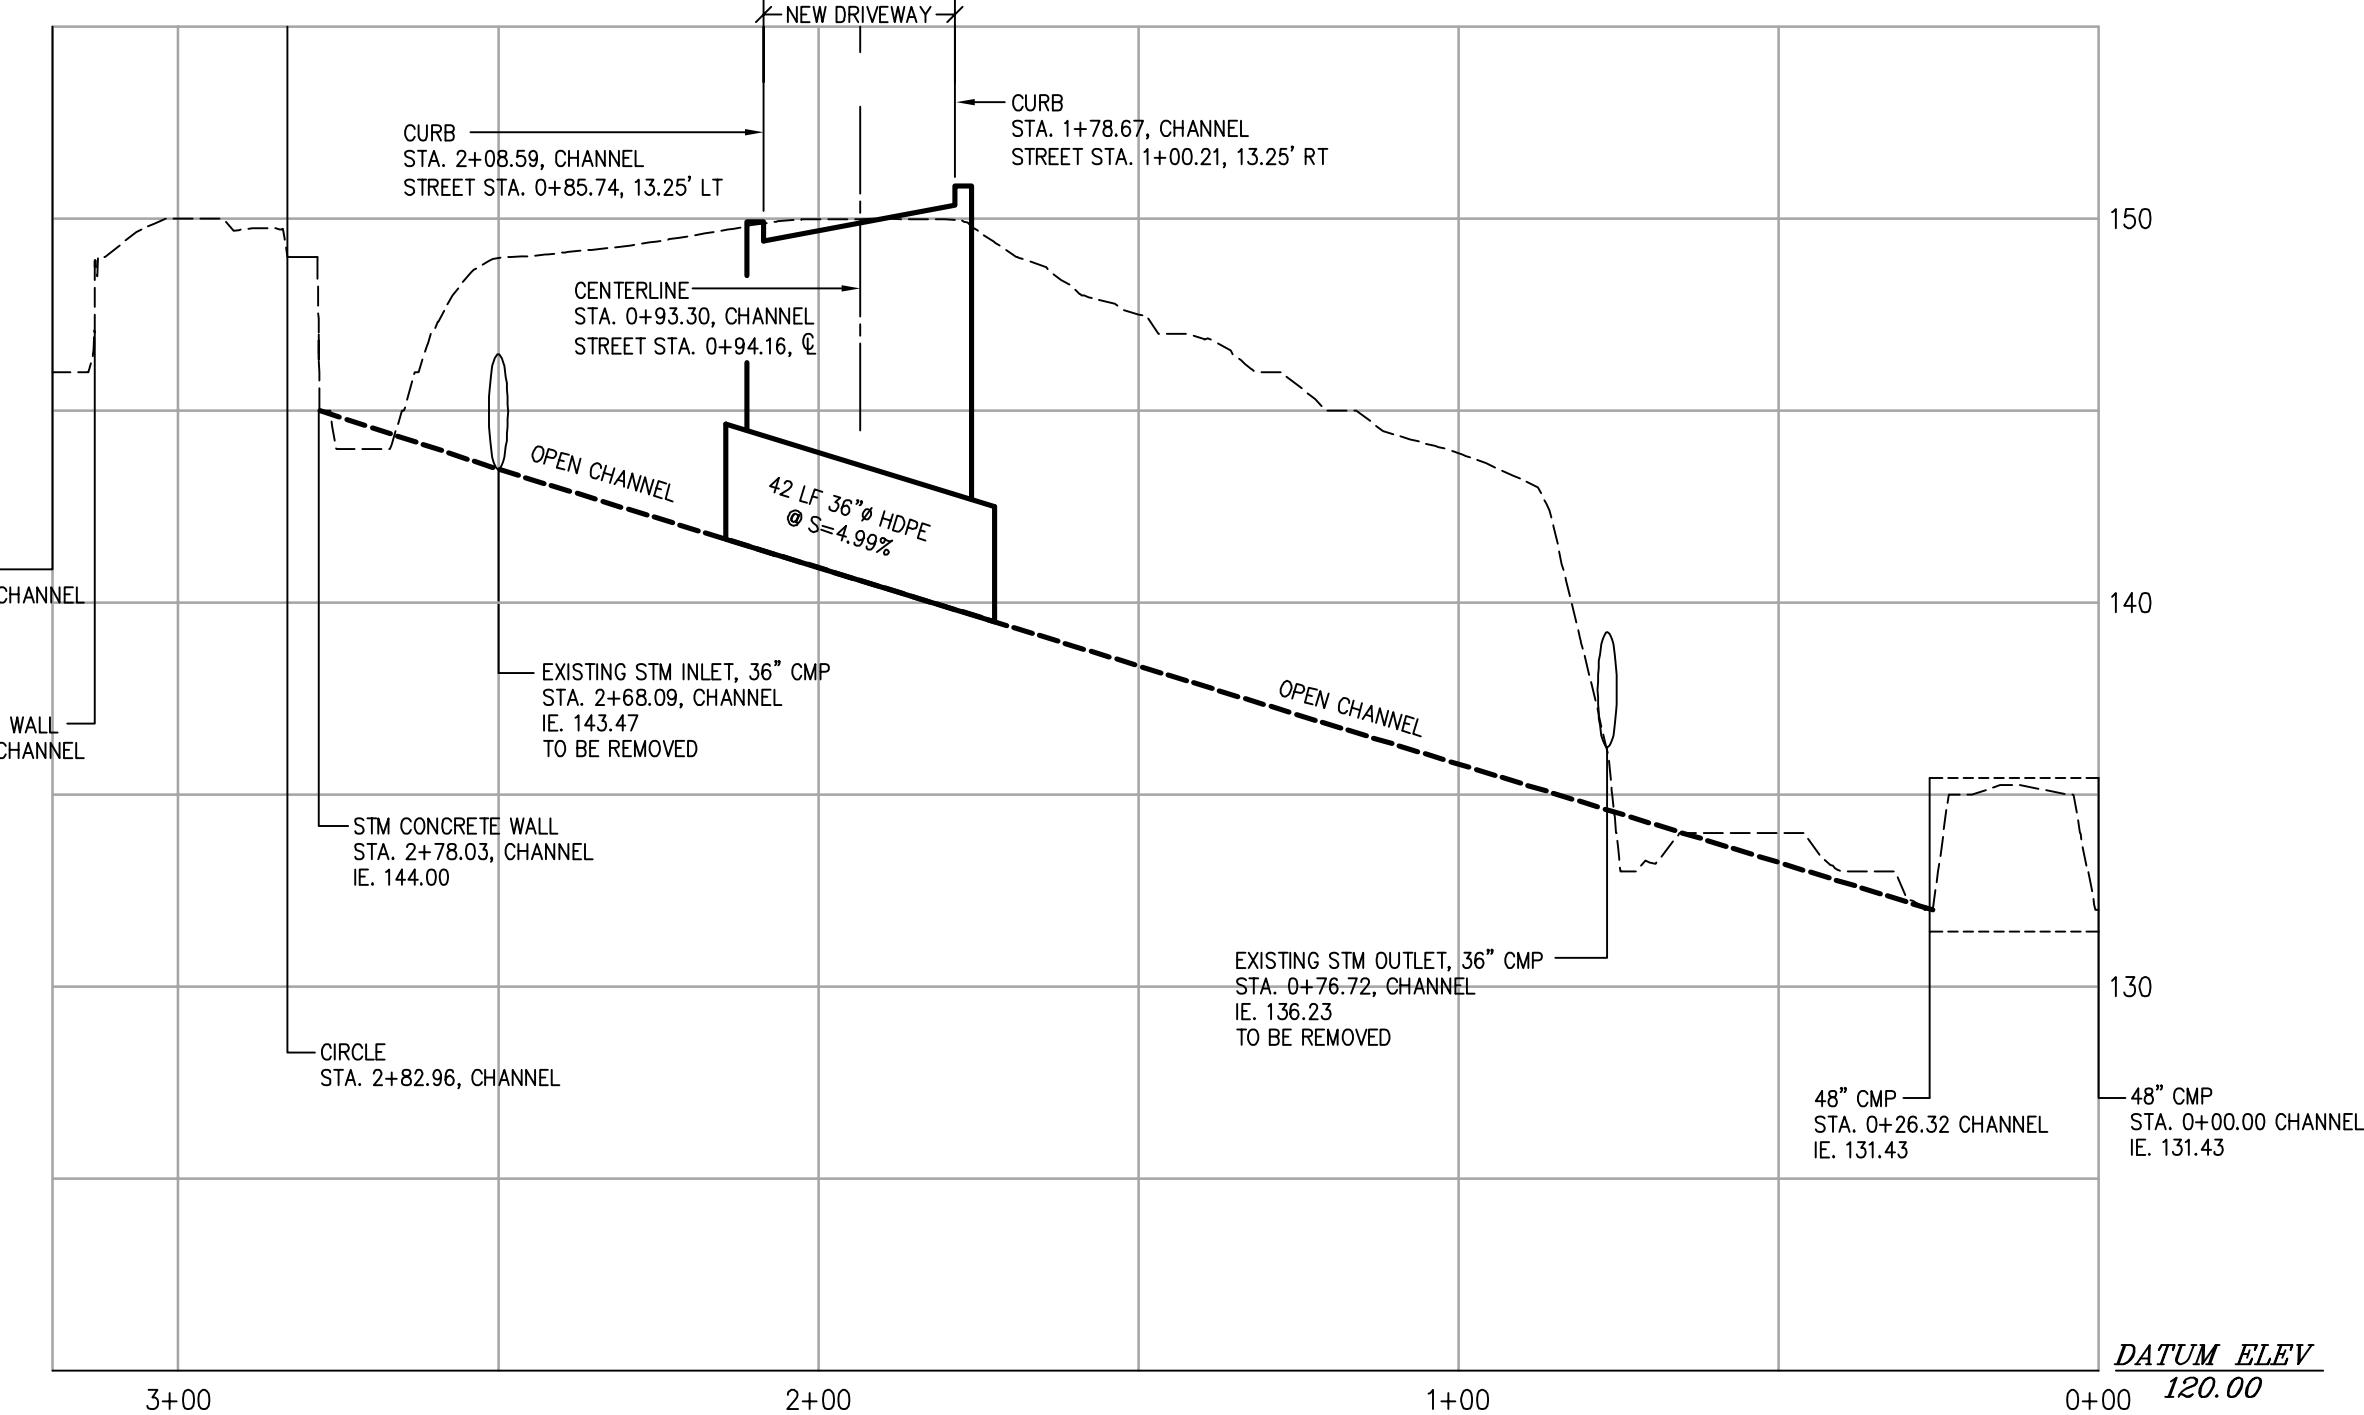

EXPIRES: 06/30/2019  
SIGNATURE DATE: 10/05/2018

2014-129T

DESIGNED:	BDG
DRAWN:	BJS
SCALE:	1" = 30'
DATE:	August, 2018
FILE:	Trillium Creek Prelim4

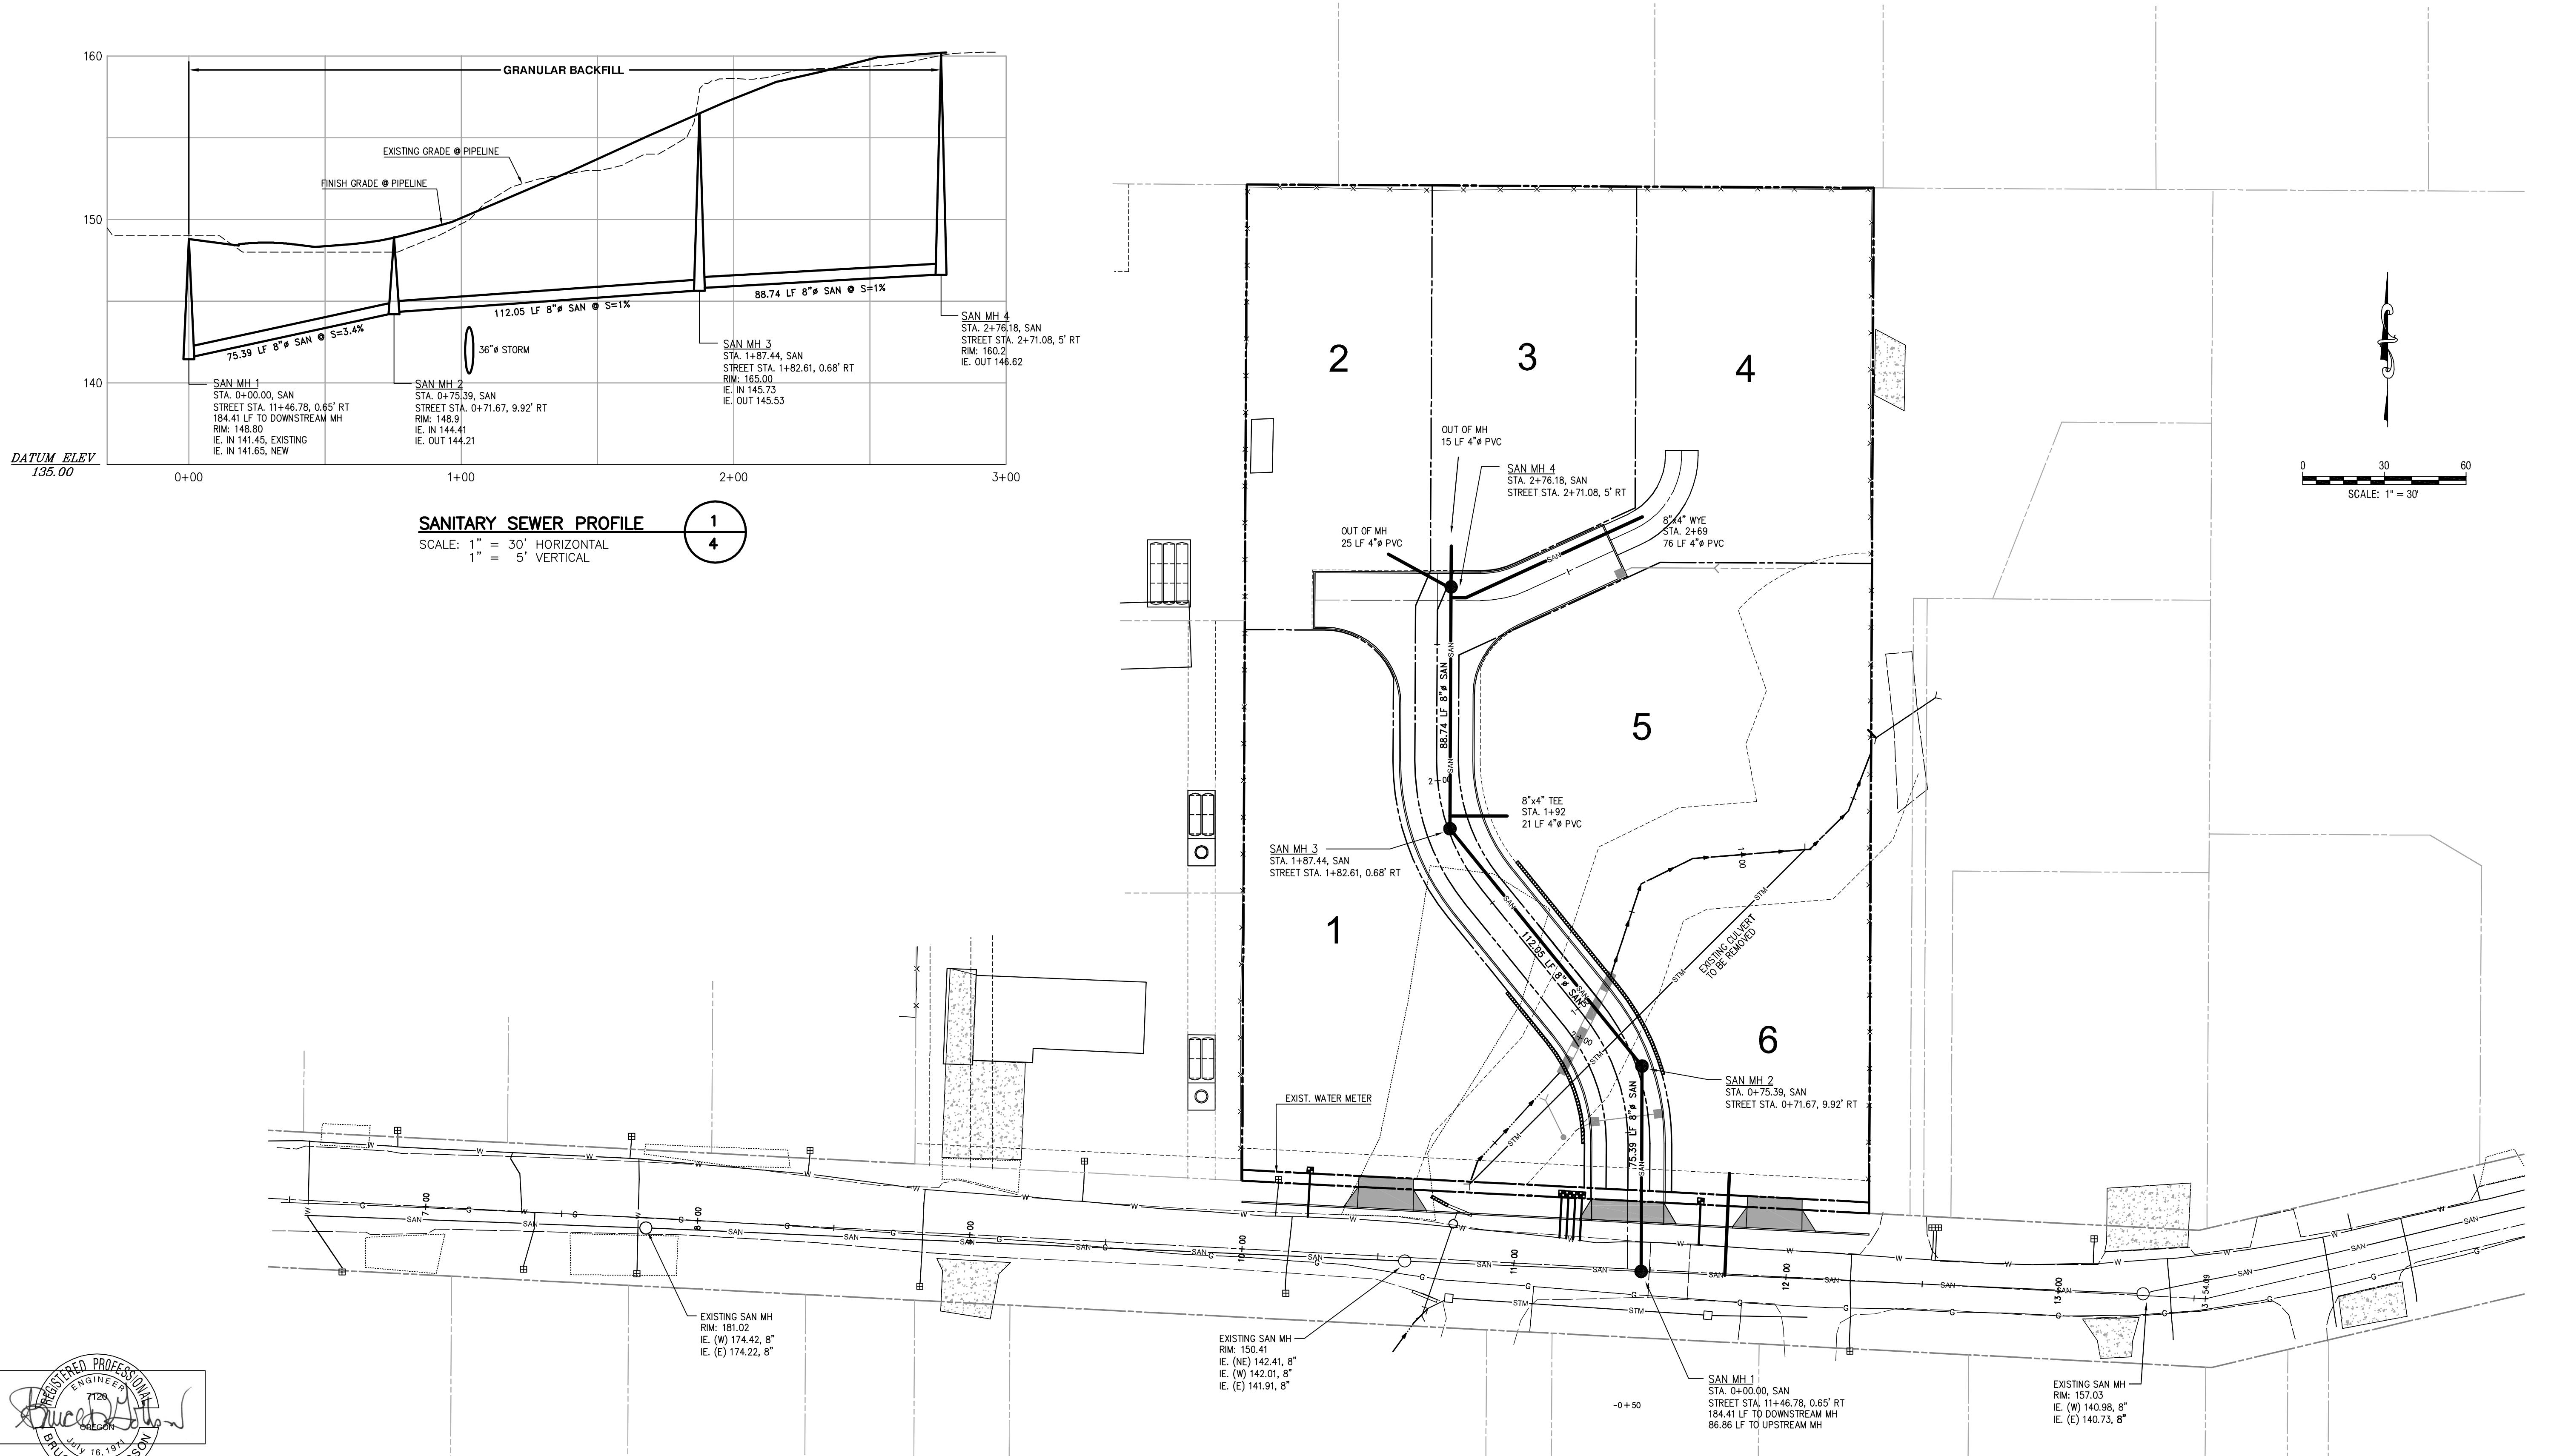

EXPIRES: 06/30/2019  
SIGNATURE DATE: 10/05/2018

2014-129T

## PRELIMINARY SANITARY SEWER AND WATER PLAN

DESIGNED:	BDG
DRAWN:	BJS
SCALE:	1" = 30'
DATE:	August, 2018
FILE:	Trillium Creek Prelim4
DATE	NO.
REVISION	



REGISTERED PROFESSIONAL  
ENGINEER  
T126  
BRUCE D. GOLDSMITH  
MAY 16, 1991

EXPIRES: 06/30/2019

SIGNATURE DATE: 10/05/2018

2014-129T

DESIGNED:	BDG
DRAWN:	BJS
SCALE:	1" = 30'
DATE:	August, 2018
FILE:	Trillium Creek Prelim4
DATE	NO.
REVISION	


**Theta, llc**  
ENGINEERING - SURVEYING - PLANNING  
PO Box 1345  
Lake Oswego, Oregon 97035  
503/481-8822  
email: thetaeng@comcast.net

Icon Construction and Development  
1380 Willamette Falls Drive, No. 200  
West Linn, Oregon 97068

Trillium Creek

SHEET:  
4/4

PRELIMINARY GRADING PLAN

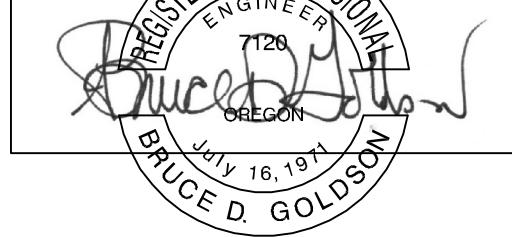

EXPIRES: 06/30/2019  
SIGNATURE DATE: 10/05/2018

2014-129T

DESIGNED:	BDG		
DRAWN:	BJS		
SCALE:	1" = 30'		
DATE:	August, 2018		
FILE:	Trillium Creek Prelim4	DATE	NO.