

# LAND USE PRE-APPLICATION CONFERENCE Thursday, April 21, 2016

# City Hall 22500 Salamo Road

### Willamette Conference Room

9:00 am Proposal to install four (4) small cell panel antennas to the Walmart


rooftop

**Applicant:** Sarah Blanchard, Applicant Agent for Verizon Wireless

**Subject Property Address: 19133 Willamette Drive** 

Neighborhood Assn: Robinwood

Planner: Peter Spir Project #: PA-16-06

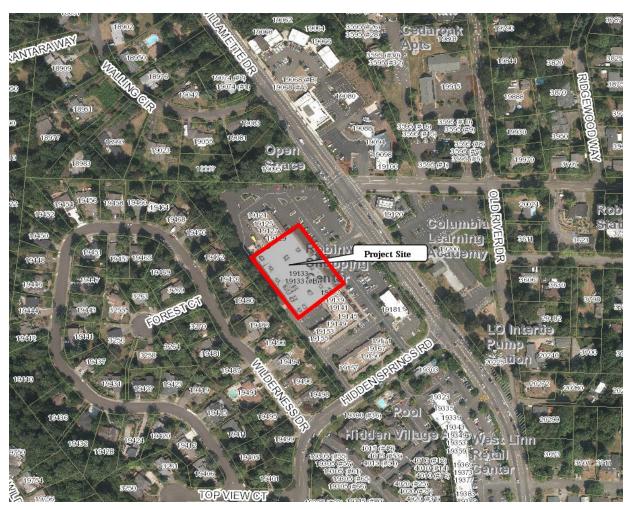

# **PRE-APPLICATION CONFERENCE**

CONFERENCE DATE:			FOR STAFF C		ROJECT #:	2.
STAFF CONTACT: /	4-21-16		9:00 am			PA-16-06
STAFF CONTACT:	4-21-16 Peter Spir			Fi	ÉE;	PA-16-06 350°°
application for the confer	ee, and accompai ee, and accompai ence date. Twen	e, this form Tying mater ty-four hou	including proprials must be surnotice is req	erty owner's ubmitted at l uired to resc	s signa east 14 hedule	4 days in advance
, (a a , e ) , j (	abject Property (or	map/tax (ot)	(Walmart)	meπe Drive,	west	Linn, OR 97068
Brief Descrip	tion of Proposal: V	erizon Wir	eless propos	es to install	4 sma	ll ceil nanel
antennas to	the Walmart ro	oftop.				n our parier
Applicant's	0-1-04		All the same of th			
	Sarah Blancha				eless	
Mailing	1125 SE Clats					
Phone No:	(503) 310-0544	Email	sarah.blanc	hard@acom	consu	ltinginc.com
> North arrows Scale > Property of Streets ab > Conceptual building > Easements	ow	others)	<ul> <li>Access to Location tree sure</li> <li>Location recommend</li> <li>Location recommend</li> </ul>	o and from the of existing tre yey of creeks and end a wetland of existing uti	e site, if ees, hig /or wet deline: lities (v	hly recommend a tlands, highly ation vater, sewer, etc.)
Hoperty owne	re below, I grant e pre-application er's signature er's mailing address	(if different	APR 0 7 2 from above) PLANNING & BL	VED  O16  UILDING LINN	Date	-1-16



April 6, 2016

Peter Spir, Associate Planner City of West Linn Planning & Development 22500 Salamo Rd #1000 West Linn, OR 97068

Re: Verizon Wireless - Class I Design Review, Rooftop Colocation, 19133 Willamette Drive, West Linn, OR 97068 (Walmart)

Dear Peter Spir,

On behalf of Verizon Wireless (VAW) LLC, d/b/a Verizon Wireless, I am submitting the following to schedule a pre-application conference for a new Wireless Rooftop site to the Walmart rooftop.

Please find enclosed the following:

- Pre-Application Conference Application
- Site Plan (11 x 17)
- Check for \$350.00 (pre-app fee)

Feel free to contact me with any questions you may have. <u>Please provide a receipt for the amount listed above.</u> Thank you for your attention to this matter.

Sincerely,

Sarah Blanchard

sarah.blanchard@acomconsultinginc.com

Acom Consulting Inc.

503-310-0544





JURISDICTION: ZONING CLASS:

PROPOSED USE

TAX PARCEL ID:

OCCUPANCY GROUP:

PROPOSED LEASE AREA: LATITUDE (NAD83):

LONGITUDE (NAD83):

STRUCTURE HEIGHT:

2014 OREGON FIRE CODE (OFC 105)

GROUND ELEVATION (NAVD88):

# **WALMART SMALL CELL -POR KENTHORPE**

19133 WILLAMETTE DR. **WEST LINN, OR 97068** 

DO NOT SCALE DRAWINGS, CONTRACTOR MUST VERIFY ALL DIMENSIONS AND ADVISE CONSULTANTS OF ANY ERRORS O MISSIONS, NO VARIATIONS OR MODIFICATIONS TO WORK SHOWN SHALL BE IMPLEMENTED WITHOUT PRIOR WRITTEN APPROVAL ALL PREVIOUS ISSUES OF THIS DRAWING ARE SUPERSEDED BY THE LATEST REVISION, ALL DRAWINGS AND SPECIFICATIONS REMAIN THE PROPERTY OF ACOM CORPORATION.

	No.	Date	Revision
	А	03/01/16	90% CD REVIEW SET
	В	04/05/16	ISSUED FOR ZONING
	0	-	
	1	-	
Ш	2	-	
	3	-	-

verizon/

# LIST OF DRAWINGS

SCOPE OF WORK

VERIZON WIRELESS PROPOSES TO INSTALL NEW EXTERIOR ROOF MOUNTED SMALL CELL PANEL ANTENNAS AND GPS UNIT WITH COAX ROUTING FROM THE VZW EQUIPMENT TO THE ANTENNAS VIA SLEEPERS ON ROOF. ALL PROPOSED RF EQUIPMENT WILL BE INSTALLED IN THE PROPOSED EQUIPMENT CABINET AT THE VERIZON WIRELESS

SHEET	DESCRIPTION
T-1	COVER SHEET
T-2	GENERAL NOTES AND SYMBOLS
A-1	PROPOSED SITE PLAN
A-2	PROPOSED ROOF PLANTED TO THE CONTROL OF THE CONTR
A-3	PROPOSED ELEVATIONS
	APR <b>0 7</b> 2016

PLANNING & BUILDING CITY OF WEST LINN

# **CODE COMPLIANCE**

PROJECT INFORMATION

ALL WORK AND MATERIALS SHALL BE PERFORMED AND INSTALLED IN ACCORDANCE WITH THE CURRENT CONDITIONS OF THE FOLLOWING CODES AS ADOPTED BY THE LOCAL GOVERNING AUTHORITIES. NOTHING IN THESE PLANS IS TO BE CONSTRUED TO PERMIT WORK NOT CONFORMING TO THESE CODES:

29'-10" ± (TOP OF BUILDING PARAPET) 32'-0" ± (TOP OF ANTENNAS)

GC (GENERAL COMMERCIAL)

M (MERCANTILE)

TELECOM

21E23AD06101

45° 23' 11.27" 45.386464°

122° 38' 30.42" -122.641783°

229' AMSL

OREGON STATE AND LOCAL BUILDING CODES WITH THE FOLLOWING REFERENCE CODE 2014 OREGON STRUCTURAL SPECIALTY CODE 2015 OREGON ELECTRICAL SPECIALTY CODE 2014 OREGON MECHANICAL SPECIALTY CODE

# **DRIVING DIRECTIONS**

VICINITY MAP

FROM PORTLAND INTERNATIONAL AIRPORT TAKE I-205 S/E PORTLAND FWY S/VETERNS MEMORIAL FWY S TOWARD 1-84/PORTLAND/SALEM. TAKE THE OR-3, EXIT 8, TOWARD WEST LINNIAKE OSWEGO. TURN RIGHT ONTO WILLAMETTE DR/OR-43. TURN LEFT ONTO HIDDEN SPRINGS RD. TAKE FIRST RIGHT. TURN RIGHT. THEN TURN RIGHT ONTO WILLAMETTE DR/OR-43. THE WALMART STORE IS ON THE CORNER.

# CONTACTS

WALMART STORE CONTACT: M. STEPHEN DEAN SENIOR REALTY MANAGER II

PHONE: (479) 277-0784

WALMART OWNER CONTACT: DAVID HESS WALMART WIRELESS FIELD OPERATIONS PHONE: (479) 204-7148

ACOM CONSULTING, INC 1125 SE CLATSOP ST

ACOM CONSULTING INC. 1125 SE CLATSOP ST PORTLAND, OR 97202 PHONE: (425) 209-6723

APPLICANT: VERIZON WIRELESS CARLEEN BRUNER Carleen.Bruner@verizonwireless.com

sarah.blanchard@acomconsultinginc.com

rick.matteson@acomconsultinginc.com

# **APPROVALS**

TITLE SIGNATURE DATE REPRESENTATIVE RE ENGINEER

**COVER SHEET** 

WALMART SMALL CELL POR KENTHORPE 19133 WILLAMETTE DR WEST LINN, OR 97068

В	T-1
Revision No:	Sheet No:
AM	CS
Project Manager:	Professional of Record:
RM	RM
Drafter:	Designer:
	04/05/16
Project Number:	Date:

## **GENERAL NOTES**

- WORK SHALL COMPLY WITH ALL APPLICABLE CODES, ORDINANCES, AND REGULATIONS. ALL NECESSARY LICENSES, CERTIFICATES, ETC., REQUIRED BY AUTHORITY HAVING JURISDICTION SHALL BE PROCURED AND PAID FOR BY THE CONTRACTOR.
- ACOM HAS NOT CONDUCTED, NOR DOES IT INTEND TO CONDUCT ANY INVESTIGATION AS TO THE PRESENCE OF HAZARDOUS MATERIAL, INCLUDING, BUT NOT LIMITED TO, ASBESTOS WITHIN THE CONFINES OF THIS PROJECT. ACOM DOES NOT ACCEPT RESPONSIBILITY FOR THE INDEMNIFICATION, THE REMOVAL, OR ANY EFFECTS FROM THE PRESENCE OF THESE MATERIALS. IF EVIDENCE OF HAZARDOUS MATERIALS IS FOUND, WORK IS TO BE SUSPENDED AND THE OWNER NOTIFIED. THE CONTRACTOR IS NOT TO PROCEED WITH FURTHER WORK UNTIL INSTRUCTED BY THE OWNER IN WRITING.
- ALL MATERIAL FURNISHED UNDER THIS CONTRACT SHALL BE NEW, UNLESS OTHERWISE NOTED. ALL WORK SHALL BE GUARANTEED AGAINST DEFECTS IN MATERIALS AND WORKMANSHIP. THE CONTRACTOR SHALL REPAIR OR REPLACE AT HIS EXPENSE ALL WORK THAT MAY DEVELOP DEFECTS IN MATERIALS OR WORKMANSHIP WITHIN SAID PERIOD OF TIME OR FOR ONE YEAR AFTER THE FINAL ACCEPTANCE OF THE ENTIRE PROJECT. WHICHEVER IS GREATER.
- THE GENERAL CONTRACTOR AND EACH SUBCONTRACTOR SHALL BE RESPONSIBLE FOR VERIFYING ALL EXISTING CONDITIONS AND UTILITIES AT THE JOB SITE BEFORE WORK IS STARTED. NO CLAIMS FOR EXTRA COMPENSATION FOR WORK WHICH COULD HAVE BEEN FORESEEN BY AN INSPECTION, WHETHER SHOWN ON THE CONTRACT DOCUMENTS OR NOT. WILL BE ACCEPTED OR PAID
- THE GENERAL CONTRACTOR AND EACH SUBCONTRACTOR SHALL BE RESPONSIBLE FOR VERIFYING DIMENSIONS AND CONDITIONS AT THE JOB SITE WHICH COULD AFFECT THE WORK UNDER THIS CONTRACT. ALL MANUFACTURERS RECOMMENDED SPECIFICATIONS. EXCEPT THOSE SPECIFICATIONS HEREIN, WHERE MOST STRINGENT SHALL BE COMPLIED
- THE CONTRACTOR SHALL VERIFY AND COORDINATE SIZE AND LOCATION OF ALL OPENINGS FOR STRUCTURAL, MECHANICAL, ELECTRICAL, PLUMBING, CIVIL, OR ARCHITECTURAL WORK.
- THE CONTRACTOR SHALL VERIFY THAT NO CONFLICTS EXIST BETWEEN THE LOCATIONS OF ANY AND ALL MECHANICAL, ELECTRICAL, PLUMBING, OR STRUCTURAL ELEMENTS, AND THAT ALL REQUIRED CLEARANCES FOR INSTALLATION AND MAINTENANCE ARE MET. NOTIFY THE CONSULTANT OF ANY CONFLICTS. THE CONSULTANT HAS THE RIGHT TO MAKE MINOR MODIFICATIONS IN THE DESIGN OF THE CONTRACT WITHOUT THE CONTRACTOR GETTING ADDITIONAL COMPENSATION.
- DO NOT SCALE THE DRAWINGS. DIMENSIONS ARE EITHER TO THE FACE OF FINISHED ELEMENTS OR TO THE CENTER LINE OF ELEMENTS, UNLESS NOTED OTHERWISE, CRITICAL DIMENSIONS SHALL BE VERIFIED AND NOTIFY THE CONSULTANT OF ANY DISCREPANCIES.
- THE CONTRACTOR SHALL BE RESPONSIBLE FOR DAILY CLEAN UP OF ALL TRADES AND REMOVE ALL DEBRIS FROM THE CONSTRUCTION SITE, AT THE COMPLETION OF THE PROJECT, THE CONTRACTOR SHALL THOROUGHLY CLEAN THE BUILDING, SITE, AND ANY OTHER SURROUNDING AREAS TO A BETTER THAN EXISTING CONDITION
- THE CONTRACTOR IS RESPONSIBLE FOR ADEQUATELY BRACING AND PROTECTING ALL WORK DURING CONSTRUCTION AGAINST DAMAGE, BREAKAGE, COLLAPSE, ETC. ACCORDING TO APPLICABLE CODES, STANDARDS, AND GOOD CONSTRUCTION PRACTICES.
- 11. THE CONTRACTOR SHALL MEET ALL OSHA REQUIREMENTS FOR ALL INSTALLATIONS.
- 12. THE CONTRACTOR SHALL BE RESPONSIBLE FOR ALL DAMAGES TO THE EXISTING CONSTRUCTION AND REPAIR ALL DAMAGES TO BETTER THAN NEW CONSTRUCTION, THE CONTRACTOR SHALL NOTIFY THE ARCHITECT OF ANY DAMAGE TO THE BUILDING SITE OR ANY ADJACENT STRUCTURES AROUND THE PROJECT. THE CONSULTANT SHALL BE SOLE AND FINAL JUDGE AS TO THE QUALITY OF THE REPAIRED CONSTRUCTION, ANY ADDITIONAL MODIFICATIONS WHICH MUST BE MADE SHALL BE MADE AT THE CONTRACTOR'S EXPENSE.
- WHERE ONE DETAIL IS SHOWN FOR ONE CONDITION, IT SHALL APPLY FOR ALL LIKE OR SIMILAR CONDITIONS, EVEN THOUGH NOT SPECIFICALLY MARKED ON THE DRAWINGS OR REFERRED TO IN THE SPECIFICATIONS, UNLESS NOTED OTHERWISE
- WHERE NEW PAVING, CONCRETE SIDEWALKS OR PATHS MEET EXISTING CONSTRUCTION. THE CONTRACTOR SHALL MATCH THE EXISTING PITCH, GRADE, AND ELEVATION SO THE ENTIRE STRUCTURE SHALL HAVE A SMOOTH TRANSITION
- 15. THE CONTRACTOR SHALL MODIFY THE EXISTING FLOORS, WALL, CEILING, OR OTHER CONSTRUCTION AS REQUIRED TO GAIN ACCESS TO AREAS FOR ALL MECHANICAL PLUMBING, ELECTRICAL, OR STRUCTURAL MODIFICATIONS. WHERE THE EXISTING CONSTRUCTION DOORS, PARTITIONS, CEILING, ETC., ARE TO BE REMOVED, MODIFIED, OR REARRANGED OR WHERE THE EXPOSED OR HIDDEN MECHANICAL, ELECTRICAL, SYSTEMS ARE ADDED OR MODIFIED, THE GENERAL CONTRACTOR SHALL REPAIR, PATCH AND MATCH ALL EXISTING CONSTRUCTION AND FINISHES OF ALL FLOORS WALLS AND CEILINGS. WHERE CONCRETE MASONRY CONSTRUCTION IS MODIFIED, THE CONTRACTOR SHALL TOOTH IN ALL NEW CONSTRUCTION TO MATCH THE EXISTING BOND. WHERE CONCRETE CONSTRUCTION IS MODIFIED, THE CONTRACTOR SHALL VERIFY THE EXACT DETAILS TO BE USED FOR CONSTRUCTION. ALL WORK SHALL BE COVERED UNDER THE GENERAL CONTRACT

- 16. VERIFY ALL EXISTING DIMENSIONS PRIOR TO PERFORMING WORK.
- 17. VERIFY LOCATION OF ALL BURIED UTILITIES PRIOR TO ANY EXCAVATION.
- 18. IN RAWLAND CONDITIONS, TOWER FOUNDATION STRUCTURAL STEEL TO BE GROUNDED PRIOR TO CONCRETE POUR. TOWER FOUNDATION STRUCTURAL STEEL TO BE CONNECTED. TO PERMANENT GROUND ROD PRIOR TO TOWER ERECTION, TOWER GROUND MUST BE MAINTAINED AT ALL TIMES
- 19. THE GENERAL CONTRACTOR SHALL BE RESPONSIBLE FOR APPLYING FOR COMMERCIAL POWER IMMEDIATELY UPON AWARD OF CONTRACT, THE GENERAL CONTRACTOR IS REQUIRED TO KEEP ALL DOCUMENTATION RECEIVED FROM THE POWER COMPANY. ACKNOWLEDGING APPLICATION FOR POWER, WRITTEN AND VERBAL DISCUSSIONS WITH THE POWER COMPANY ETC.
- 20. THE GENERAL CONTRACTOR SHALL OBTAIN WRITTEN CONFIRMATION OF THE EXPECTED DATE OF COMPLETION OF THE POWER CONNECTION FROM THE POWER COMPANY.
- 21. IF THE POWER COMPANY IS UNABLE TO PROVIDE THE POWER CONNECTION BY OWNER'S REQUIRED DATE, THE GENERAL CONTRACTOR SHALL PROVIDE AND MAINTAIN A TEMPORARY GENERATOR UNTIL THE POWER COMPANY CONNECTION IS COMPLETED, COSTS ASSOCIATED WITH THE TEMPORARY GENERATOR TO BE APPROVED BY THE OWNER.
- 22. IF THE GENERAL CONTRACTOR FAILS TO TAKE NECESSARY MEASURES AS DESCRIBED IN NOTES 19, 20 AND 21 ABOVE, THE GENERAL CONTRACTOR SHALL PROVIDE A TEMPORARY GENERATOR AT NO COST TO THE OWNER.
- 23. PLANS PART OF THIS SET ARE COMPLEMENTARY, INFORMATION IS NOT LIMITED TO ONE PLAN. DRAWINGS AND SPECIFICATIONS ARE INSTRUMENTS OF SERVICE AND SHALL REMAIN THE PROPERTY OF THE ARCHITECT, WHETHER THE PROJECT FOR WHICH THEY ARE MADE IS EXECUTED OR NOT. THEY ARE NOT TO BE USED BY THE OWNER ON OTHER PROJECTS OR EXTENSION TO THIS PROJECT EXCEPT BY AGREEMENT IN WRITING AND WITH APPROPRIATE COMPENSATION TO THE ARCHITECT. THESE PLANS WERE PREPARED TO BE SUBMITTED TO GOVERNMENTAL BUILDING AUTHORITIES FOR REVIEW FOR COMPLIANCE WITH APPLICABLE CODES AND IT IS THE SOLE RESPONSIBILITY OF THE OWNER AND/OR CONTRACTOR TO BUILD ACCORDING TO APPLICABLE BUILDING CODES.
- 24. IF CONTRACTOR OR SUB-CONTRACTOR FIND IT NECESSARY TO DEVIATE FROM ORIGINAL APPROVED PLANS, THEN IT IS THE CONTRACTOR'S AND THE SUB-CONTRACTOR'S RESPONSIBILITY TO PROVIDE THE ARCHITECT WITH 4 COPIES OF THE PROPOSED CHANGES FOR HIS APPROVAL BEFORE PROCEEDING WITH THE WORK. IN ADDITION THE CONTRACTOR AND SUB-CONTRACTORS SHALL BE RESPONSIBLE FOR PROCURING ALL NECESSARY APPROVALS FROM THE BUILDING AUTHORITIES FOR THE PROPOSED CHANGES BEFORE PROCEEDING WITH THE WORK. THE CONTRACTOR AND SUB-CONTRACTORS SHALL BE RESPONSIBLE FOR PROCURING ALL NECESSARY INSPECTIONS AND APPROVALS FROM BUILDING AUTHORITIES DURING THE EXECUTION OF THE WORK
- 25. IN EVERY EVENT, THESE CONSTRUCTION DOCUMENTS AND SPECIFICATIONS SHALL BE INTERPRETED TO BE A MINIMUM ACCEPTABLE MEANS OF CONSTRUCTION BUT THIS SHALL NOT RELIEVE THE CONTRACTOR, SUB-CONTRACTOR, AND/OR SUPPLIER/MANUFACTURER FROM PROVIDING A COMPLETE AND CORRECT JOB WHEN ADDITIONAL ITEMS ARE REQUIRED TO THE MINIMUM SPECIFICATION, IF ANY ITEMS NEED TO EXCEED THESE MINIMUM SPECIFICATIONS TO PROVIDE A COMPLETE, ADEQUATE AND SAFE WORKING CONDITION. THEN IT SHALL BE THE DEEMED AND UNDERSTOOD TO BE INCLUDED IN THE DRAWINGS. FOR EXAMPLE, IF AN ITEM AND/OR PIECE OF EQUIPMENT REQUIRES A LARGER WIRE SIZE (I.E. ELECTRICAL WIRE), STRONGER OR LARGER PIPING, INCREASED QUANTITY (I.E. STRUCTURAL ELEMENTS), REDUCED SPACING, AND/OR INCREASED LENGTH (I.E. BOLT LENGTHS, BAR LENGTHS) THEN IT SHALL BE DEEMED AND UNDERSTOOD TO BE INCLUDED IN THE BID/PROPOSAL. THESE DOCUMENTS ARE MEANT AS A GUIDE AND ALL ITEMS REASONABLY INFERRED SHALL BE DEEMED TO BE INCLUDED.
- 26. THESE CONTRACT DOCUMENTS AND SPECIFICATIONS SHALL NOT BE CONSTRUED TO CREATE A CONTRACTUAL RELATIONSHIP OF ANY KIND BETWEEN THE ARCHITECT AND THE CONTRACTOR

# LINE/ANTENNA NOTES

- ALL THREADED STRUCTURAL FASTENERS FOR ANTENNA SUPPORT ASSEMBLES SHALL CONFORM TO ASTM A307 OR ASTM A36. ALL STRUCTURAL FASTENERS FOR STRUCTURAL STEEL FRAMING SHALL CONFORM TO ASTM A325. FASTENERS SHALL BE 5/8" MIN. DIA. BEARING TYPE CONNECTIONS WITH THREADS EXCLUDED FROM THE PLANE, ALL EXPOSED FASTENERS, NUTS. AND WASHERS SHALL BE GALVANIZED OTHERWISE NOTED. CONCRETE EXPANSION ANCHORS SHALL BE HILTI KWIK BOLTS UNLESS OTHERWISE NOTED. ALL ANCHORS INTO CONCRETE SHALL BE STAINLESS STEEL
- NORTH ARROW SHOWN ON PLANS REFERS TO TRUE NORTH, CONTRACTOR SHALL VERIFY MAGNETIC NORTH AND NOTIFY CONSULTANT OF ANY DISCREPANCY BEFORE STARTING CONSTRUCTION
- PROVIDE LOCK WASHERS FOR ALL MECHANICAL CONNECTIONS FOR GROUND CONDUCTORS. USE STAINLESS STEEL HARDWARE THROUGHOUT.
- THOROUGHLY REMOVE ALL PAINT AND CLEAN ALL DIRT FROM SURFACES REQUIRING GROUND CONNECTIONS.
- MAKE ALL GROUND CONNECTIONS AS SHORT AND DIRECT AS POSSIBLE, AVOID SHARP BENDS. ALL BENDS TO BE A MIN. OF 8" RADIUS.
- FOR GROUNDING TO BUILDING FRAME AND HATCH PLATE GROUND BARS, USE A TWO-BOLT HOLE NEMA DRILLED CONNECTOR SUCH AS T&B 32007 OR APPROVED EQUAL
- FOR ALL EXTERNAL GROUND CONNECTIONS, CLAMPS AND CADWELDS, APPLY A LIBERAL PROTECTIVE COATING OR AN ANTI-OXIDE COMPOUND SUCH AS "NO-OXIDE A" BY DEARBORN
- REPAIR ALL GALVANIZED SURFACES THAT HAVE BEEN DAMAGED BY THERMO-WELDING, USE ERICO T-319 GALVANIZING BAR/COLD GALVANIZING PAINT.
- SEAL ALL CONDUIT PENETRATIONS INTO MODULAR BUILDING WITH A SILICONE SEALANT AND
- 10. ANTENNAS AND COAX TO BE PROVIDED BY VERIZON WIRELESS, CONTRACTOR TO COORDINATE

DO NOT SCALE DRAWINGS, CONTRACTOR MUST VERIFY ALL DIMENSIONS AND ADVISE CONSULTANTS OF ANY ERRORS OF OMISSIONS, NO VARIATIONS OR MODIFICATIONS TO WORK SHOWN SHALL BE IMPLEMENTED WITHOUT PRIOR WRITTEN

No.	Date	Revision
А	03/01/16	90% CD REVIEW SET
В	04/05/16	ISSUED FOR ZONING
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1	-	-
2	-	
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# PROJECT INFORMATION


- THIS IS AN MANNED FACILITY WITH RESTRICTED ACCESS EQUIPMENT AND WILL BE USED FOR THE TRANSMISSION OF RADIO SIGNALS FOR THE PURPOSE OF PROVIDING PUBLIC CELLULAR SERVICE.
- VERIZON WIRELESS CERTIFIES THAT THIS TELEPHONE EQUIPMENT FACILITY WILL BE SERVICED ONLY BY VERIZON WIRELESS EMPLOYEE SERVICE PERSONNEL FOR REPAIR PURPOSES ONLY. THIS FACILITY IS OCCUPIED AND IS DESIGNED FOR HUMAN OCCUPANCY.



WALMART SMALL CELL POR KENTHORPE 19133 WILLAMETTE DR WEST LINN, OR 97068


### **LEGEND**

# BUILDING/WALL/DETAIL SECTION - Detail Number

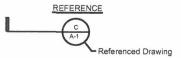

Sheet Numbe Where Detailed

#### LARGE SCALE DETAIL

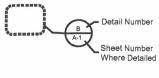


#### THE EXISTING CONDITIONS REPRESENTED HEREIN ARE BASED ON VISUAL OBSERVATIONS AND INFORMATION PROVIDED BY OTHERS. ACOM CONSULTING CANNOT GUARANTEE THE CORRECTNESS NOR COMPLETENESS OF THE EXISTING CONDITIONS SHOWN AND ASSUMES NO RESPONSIBILITY THEREOF. CONTRACTOR AND HIS SUB-CONTRACTORS SHALL VISIT THE SITE AND VERIFY ALL EXISTING CONDITIONS AS REQUIRED FOR PROPER EXECUTION OF PROJECT. REPORT ANY CONFLICTS OR DISCREPANCIES TO THE

CONSULTANT PRIOR TO CONSTRUCTION

**IMPORTANT NOTICE** 

# **GENERAL NOTES** AND SYMBOLS

В	T-2
Revision No:	Sheet No:
AM	cs
Project Manager:	Professional of Record:
RM	RM
Drafter:	Designer:
	04/05/16
Project Number:	Date:

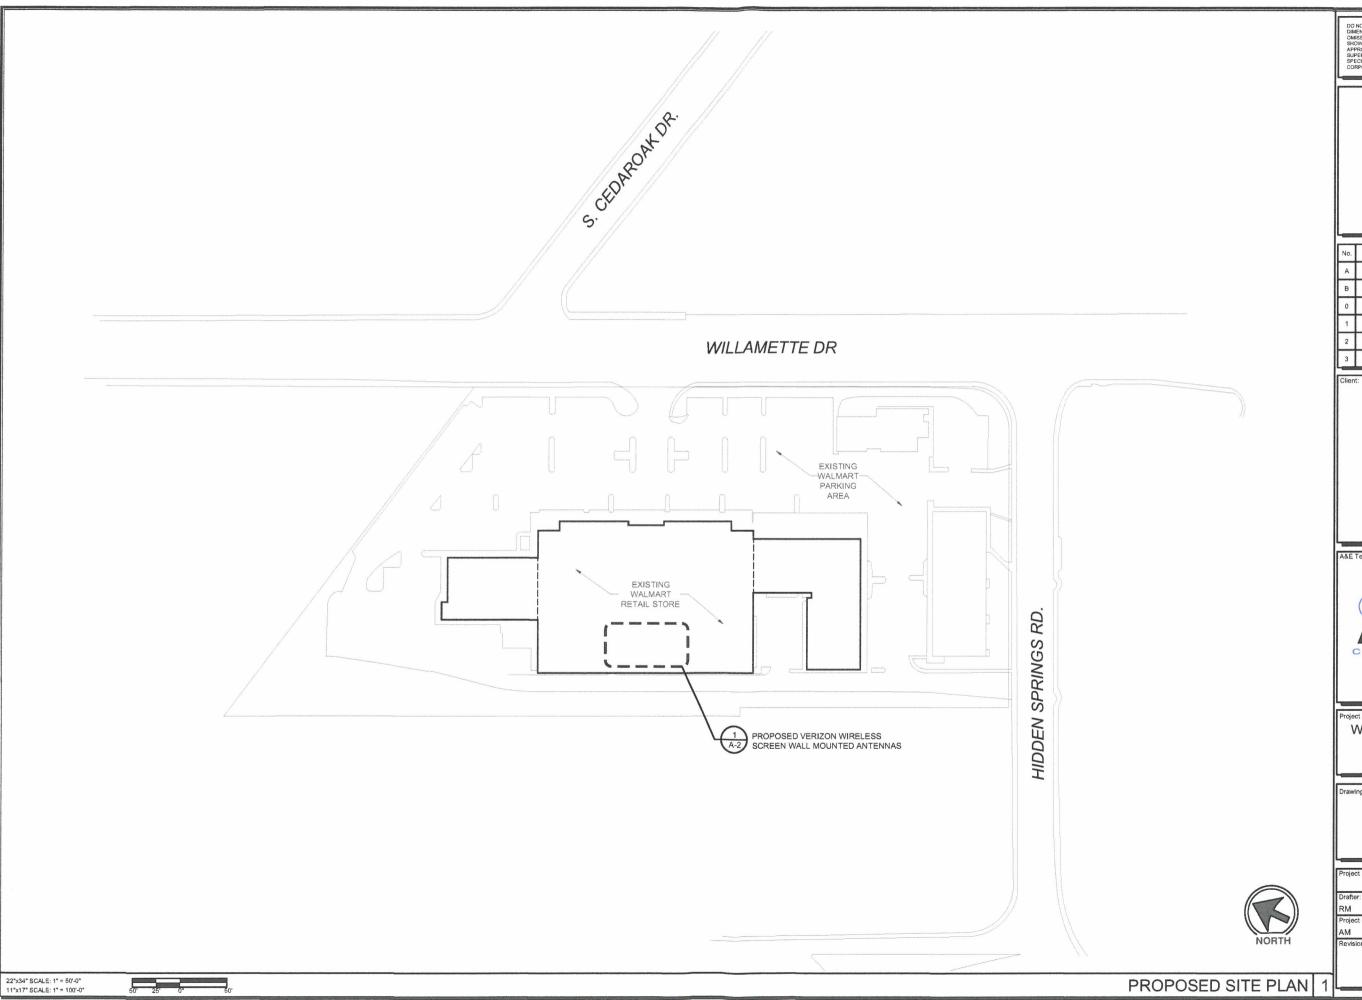

DO NOT SCALE DRAWINGS, CONTRACTOR MUST VERIFY ALL DIMENSIONS AND ADVISE CONSULTANTS OF ANY ERRORS OR OMISSIONS, NO VARIATIONS OR MODIFICATIONS TO WORK SHOWN SHALL BE IMPLEMENTED WITHOUT PRIOR WRITTEN APPROVIAL ALL PREVIOUS ISSUES OF THIS DRAWING ARE SUPERSEDED BY THE LATEST REVISION, ALL DRAWINGS AND SPECIFICATIONS REMAIN THE PROPERTY OF ACOM COPPORATION.

Date 90% CD REVIEW SET 03/01/16 ISSUED FOR ZONING 04/05/16

verizon/





WALMART SMALL CELL POR KENTHORPE 19133 WILLAMETTE DR WEST LINN, OR 97068

**PROPOSED** SITE PLAN

В	A-1
Revision No:	Sheet No:
AM	cs
Project Manager:	Professional of Record:
RM	RM
Drafter:	Designer:
	04/05/16
Project Number:	Date:

CONTRACTOR SHALL NOT DISTURB OR DAMAGE THE EXISTING ROOFING SYSTEM IN ANY WAY, SHAPE OR FORM. IF ANY DAMAGES DO OCCUR, THE CONTRACTOR SHALL REPORT TO THE VZW CONSTRUCTION MANAGER IMMEDIATELY! IT IS THE CONTRACTOR'S RESPONSIBILITY TO MAINTAIN THE ROOFING SYSTEM IN ITS EXISTING CONDITION DURING CONSTRUCTION.

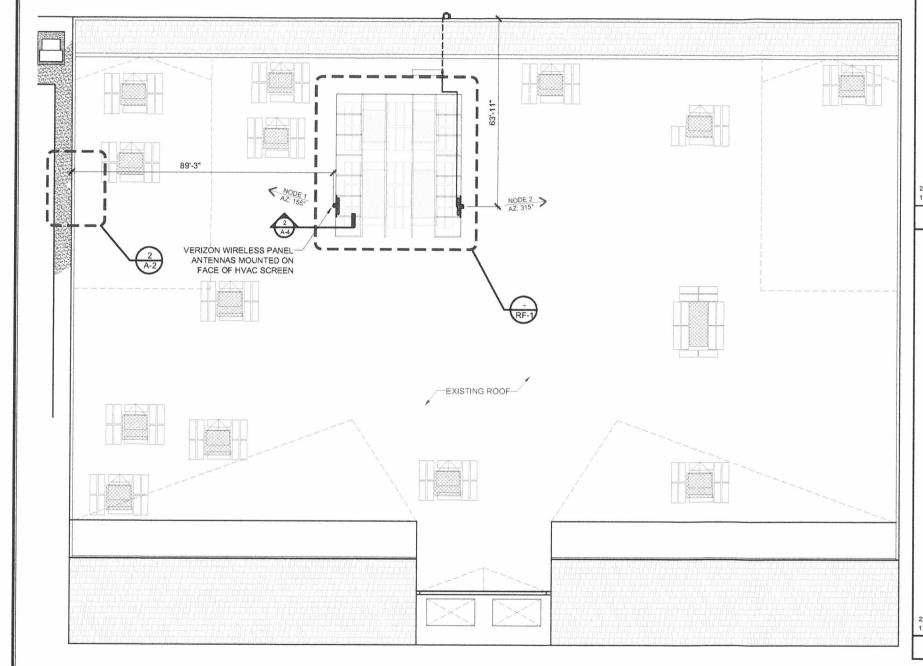

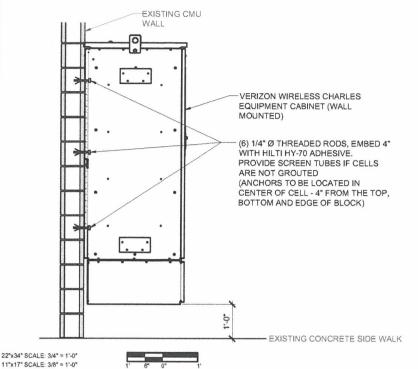

Date 03/01/16 90% CD REVIEW SET ISSUED FOR ZONING 04/05/16

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# verizon v

WALMART SMALL CELL POR KENTHORPE 19133 WILLAMETTE DR WEST LINN, OR 97088

**PROPOSED ROOF PLAN** 

04/05/16 B A-2

EXISTING ASPHALT AREA

EXISTING ROOF

-LOAD CENTER (WALL MOUNTED) VERIZON WIRELESS EQUIPMENT CABINET (WALL MOUNTED) W/ (2) OVP'S PER RF DESIGN -HILTI HY-70 ANCHOR SYSTEM (TYP OF 6 - 3 EACH SIDE)

**EQUIPMENT CABINET MOUNTING DETAIL 3** 

22"x34" SCALE: 3/8" = 1'-0" 11"x17" SCALE: 3/16" = 1'-0"

EDGE OF

VERIZON WIRELESS WALL
MOUNTED CONDUITS:

(2) 2" EMT FOR FIBER CABLE
TO ANTENNAS ENLARGED EQUIPMENT AREA PLAN 2

22"x34" SCALE: 1/16" = 1'-0" 11"x17" SCALE: 1/32" = 1'-0"



PROPOSED ROOF PLAN

