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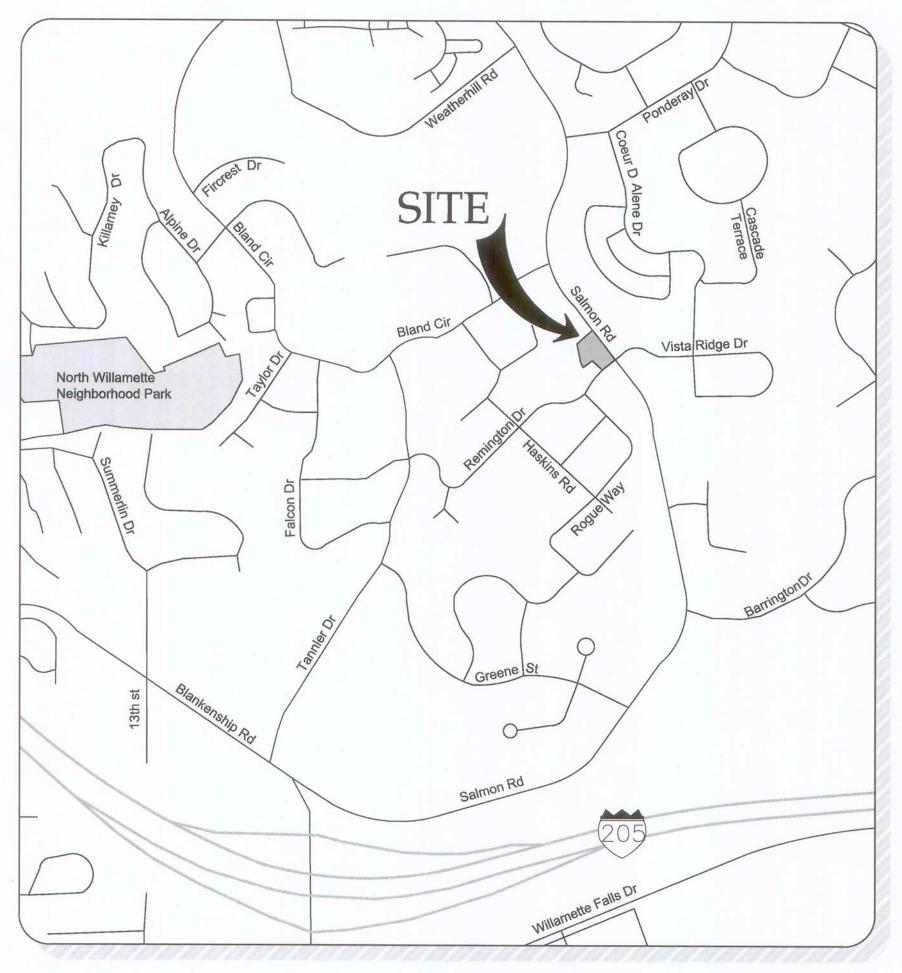
C401.pdf

## CONSTRUCTION DOCUMENTS

# BENJAMIN HEIGHTS **PARTITION**

PREPARED FOR

LF 5, LLC



**APPROVED FOR CONSTRUCTION BY** 

shall not be construed as relieving the Design


Engineer of full responsibility for accuracy and completeness of the drawings. This plan review approval does not prevent the City

from requiring further code corrections in the

CITY OF WEST LINN This approval is only for general conformance with the design concept and general compliance with applicable codes and requirements and

This Plan has been Reviewed & Complies w/

VICINITY MAP NOT TO SCALE

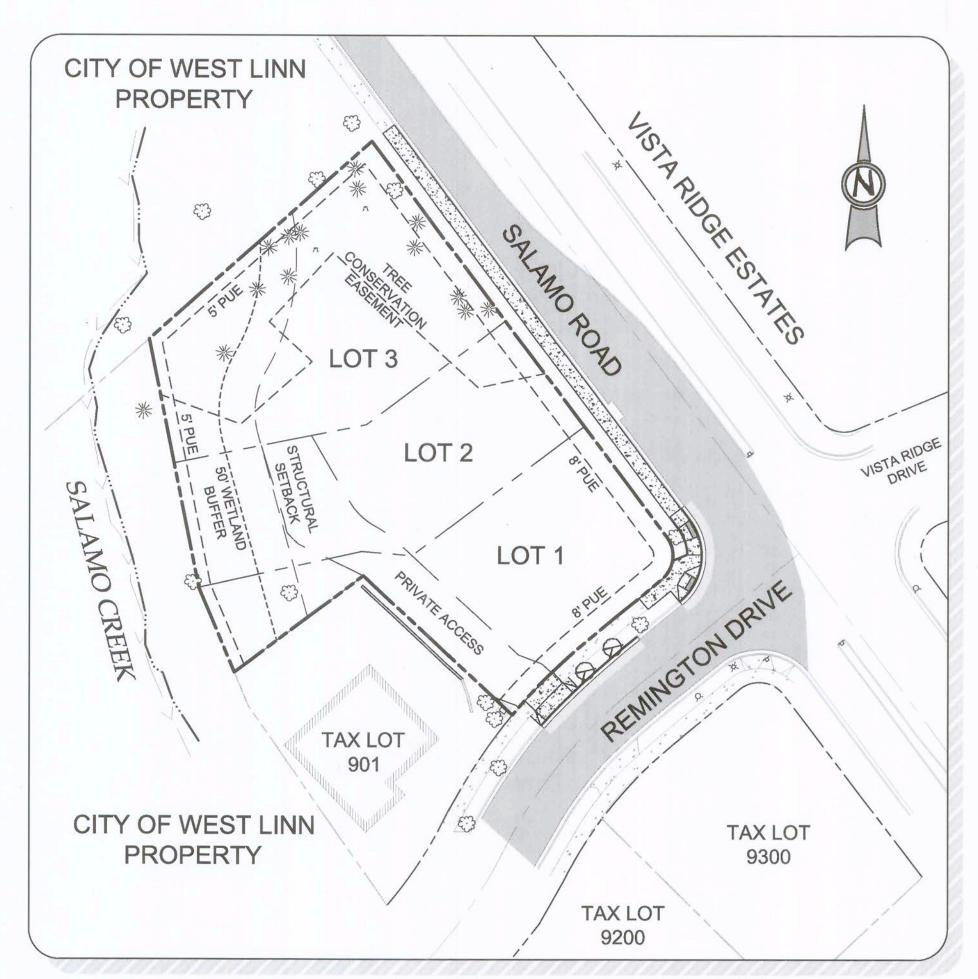

SITE MAP Scale: 1 inch = 80 feet

TAX LOT 900, LOCATED IN THE SW 1/4 OF SECTION 35, T.2S., R.1E., W.M. CITY OF WEST LINN, CLACKAMAS COUNTY, OREGON

### PROJECT TEAM

### OWNER/APPLICANT

LF 5, LLC C/O: J.T. SMITH COMPANIES 5285 MEADOWS ROAD, SUITE #171 LAKE OSWEGO, OR 97035 CONTACT: JOHN WYLAND jwyland@jtsmithco.com

### **PLANNING**

### CONSULTANT 3J CONSULTING, INC 10445 SW CANYON ROAD, SUITE 245 BEAVERTON, OR 97005 CONTACT: ANDREW TULL PHONE: 503-946-9365

EMAIL: andrew.tull@3j-consulting.com

LAND SURVEYOR COMPASS SURVEYING 4107 SE INTERNATIONAL WAY, SUITE 705 MILWAUKIE, OR 97222 CONTACT: DON DEVLAEMINCK, PLS PHONE: 503-653-9093

3J CONSULTING, INC. 10445 SW CANYON ROAD, SUITE 245 BEAVERTON, OR 97005 CONTACT: BRIAN FEENEY PHONE: (503) 946-9365 brian.feeney@3j-consulting.com

**CIVIL ENGINEER** 

### **GEOTECHNICAL** CONSULTANT

GEOPACIFIC ENGINEERING, INC. 14835 SW 72ND AVENUE PORTLAND, OR 97224 CONTACT: SCOTT HARDMAN PHONE: (503) 625-4455 shardman@geopacificeng.com

### SITE INFORMATION

### SITE ADDRESS 23451 SALAMO ROAD WEST LINN, OR 97068

dond@compass-engineering.com

TAX LOT(S) 2S1E35AC 900

FLOOD HAZARD MAP NUMBER: 41005C0257D ZONE X (UNSHADED)

**JURISDICTION** CITY OF WEST LINN

ZONING

### **UTILITIES & SERVICES**

### WATER, STORM, SEWER

CITY OF WEST LINN CONTACT: KHOI LE PHONE: (503) 722-5517

### **POWER**

CONTACT: MIKE HIEB PHONE: (503) 570-4412

NORTHWEST NATURAL CONTACT: LANCE CHEELEY PHONE: (503) 220-2357

### CABLE

COMCAST CONTACT: KENNETH WILLS PHONE: (503) 793-9981 EMAIL: kenneth\_wills@cable.comcast.com

### FIRE

TUALATIN VALLEY FIRE & RESCUE CONTACT: TY DARBY PHONE: (503) 259-1409

POLICE, SCHOOLS, ROADS, PARKS CITY OF WEST LINN


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CENTURYLINK


CONTACT: KENNETH SCIULLI

PHONE: (503) 390-0330

C000	COVER SHEET
C001	CONDITIONS OF APPROVAL
C002	GENERAL NOTES
C100	EXISTING CONDITIONS PLAN
C101	DEMOLITION PLAN
C102	TREE PROTECTION AND REMOVAL PLAN
C110	TENTATIVE PLAT
C120	GRADING AND EROSION CONTROL PLAN
C123	EROSION AND SEDIMENT CONTROL DETAILS
C201	PRIVATE DRIVE PLAN AND PROFILE
C202	SALAMO RD & REMINGTON DR IMPROVEMENTS
C300	COMPOSITE UTILITY PLAN
C301	STREET LIGHTING PLAN
C400	CONSTRUCTION DETAILS I
C401	CONSTRUCTION DETAILS I




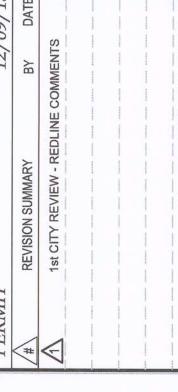

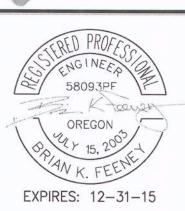

Digital Signature

01/08/2014

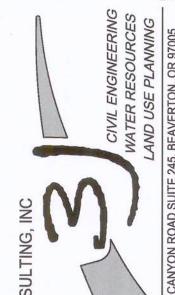

3J JOB ID# | 13117 LAND USE # | \_\_\_\_ TAX LOT # | 2S1E35AC 900

DESIGNED BY | KEF/CLF CHECKED BY | BKF

SHEET TITLE **COVER SHEET** 

Based on findings contained in the applicant's submittal in the City record and the staff findings, there are sufficient grounds to approve this application (MIP-13-03/WAP-13-05) subject to the following conditions of approval:  1. Site Plans. The improvements shall conform to the Tentative Plat (Sheet C2.0) on Page 209 of Exhibit PD-6, the Site Plan (Sheet C2.1) on Page 210 of Exhibit PD-6, and the Utility Plan (Sheet C3.0) on Page 212 of Exhibit PD-6, except as modified by these conditions of approval.	PERMIT   12/09/13
<ol> <li>Conservation Easement and Signage. A conservation easement shall be recorded that applies to all areas within 65 feet of the edge of Salamo Creek and the surrounding designated wetland. The easement shall include the City's standard conservation easement language for water resource area conservation easements (available from the Planning Department) which prohibits further development and protects native vegetation. The edge of the conservation easement on all sides shall be marked with the City's standard permanent markers at 30-foot to 50-foot intervals and at all boundary direction changes.</li> <li>Significant Tree Conservation. The applicant shall preserve the three fir trees proposed for removal in the tree conservation easement on the applicant's submitted plans (sheet C 1.2). (Removal of trees in poor health or which pose a public safety risk must be approved through a Tree Removal Permit process).</li> <li>TVPR Access Requirements.         <ul> <li>A) The applicant shall post and restrict parking along both sides of the private driveway from Remington Drive to the property line separating lots 2 and 3.</li> <li>B) The driveway shall be of an all-weather surface that is easily distinguishable from the surrounding area and is capable of supporting not less than 12,500 pounds point load (wheel load) and 60,000 pounds live load (gross vehicle weight).</li> <li>C) The final construction plans shall adjust grade along elements of the private driveway to 10% or less as needed or as an alternate means of protection, provide residential fire sprinklers within the homes on lots 2 and 3.</li> <li>D) Prior to issuance of a building permit, the applicant shall provide evidence of a current fire flow test of the nearest fire hydrant demonstrating available flow at 20 PSI residual pressure.</li> <li>E) The applicant shall install signage physical address visible from both approaches of Remington Drive.</li> </ul> </li> </ol>	CONDITIONS OF APPROVAL  BENJAMIN HEIGHTS  PARTITION  WEST LINN, OR LF 5, LLC
S. Mitigation Mitigation shall occur at North Willamette Park per the Parks and Recreation Department's restoration plan but it can be on any other parkland with an unhealthy transition area should Parks' plans change. The mitigation for the project's square footage of Water Resource Area disturbance must be complete by the time the final plat is recorded. If this cannot be the case due to delays in the Parks and Recreation Departments project(s), the applicant shall provide bonding or surety for the mitigation prior to recording of the final plat.  6. Fencing in Right of Way. The fence installed in the public right of way along the proposed sidewalk on Salamo Road shall be an Ameristar ornamental steel fence or an approved equal determined by the City Engineer.  1. declare to have no interest in the outcome of this decision due to some past or present involvement with the applicant, the subject property, or surrounding properties, and therefore, can render an impartial decision. The provisions of the Community Development Code Chapter 99 have been met.  Appeals to this decision must be filed with the West Linn Planning Department within 14 days of mailing date. Cost is \$400. The appeal must be filed by an individual who has established standing by submitting comments prior to or on August 13, 2013. Approval will lapse 3 years from effective approval date.  Mailed this Again and Agai	CIVIL ENGINEERING OREGON ONATER RESOURCES LAND USE PLANNING THE 245, BEAVERTON, OR 97005 C. (503) 946-9365

Therefore, the 14-day appeal period ends at 5 p.m., on

august 28, 2013

p:/devrvw/projects folder/projects 2013/MIP-13-03 23451 Salamo Rd/staff report mip-13-03

APPROVED FOR CONSTRUCTION BY
CITY OF WEST LINN
This approval is only for general conformance with the design concept and general compliance with applicable codes and requirements and shall not be construed as relieving the Design Engineer of full responsibility for accuracy and completeness of the drawings. This plan review approval does not prevent the City from requiring further code corrections in the field.

DATE:







3J JOB ID # | 13117 LAND USE # | \_\_\_\_ TAX LOT # | 2S1E35AC 900 DESIGNED BY | KEF/CLF CHECKED BY | BKF

SHEET TITLE C of A

### SANITARY SEWER NOTES

- PIPE SHALL BE PVC SEWER PIPE CONFORMING TO ASTM D-3034 SDR 35. MINIMUM STIFFNESS SHALL BE 46 PSI AND JOINT TYPE SHALL BE ELASTOMERIC GASKET CONFORMING TO ASTM D-3212.
- 2. MANHOLE BASE SHALL BE POURED IN PLACE CONCRETE BASE WITH A MINIMUM COMPRESSIVE STRENGTH OF 3300 PSI OR PRECAST. MANHOLE RISERS AND TOPS SHALL BE PRECAST SECTIONS WITH MINIMUM COMPRESSIVE STRENGTH OF 4000 PSI. TOPS SHALL BE ECCENTRIC CONES EXCEPT WHERE INSUFFICIENT HEADROOM REQUIRES FLAT TOPS. INVERTS SHALL BE CONSTRUCTED SO AS TO PROVIDE SMOOTH FLOW-THROUGH CHARACTERISTICS AND CHANNELS MUST BE ABLE TO PASS A 6"X36" CYLINDER INTO PIPES. PVC PIPE SHALL BE CONNECTED TO MANHOLE BY MEANS OF A FLEXIBLE CONNECTION AND SHALL HAVE A SHEAR JOINT LOCATED 18" OUTSIDE OF MANHOLE. CEMENT GROUT FOR CONNECTING PVC SEWER PIPE TO MANHOLE WILL NOT BE PERMITTED.
- 3. ALL MANHOLES LOCATED IN EASEMENT AREAS REQUIRE TAMPER PROOF LIDS AND THE LID SHALL BE SET 12" ABOVE THE PROPOSED GRADE WHEN PLACED IN UNPAVED AREAS.
- 4. CLEANOUT PIPE, FITTINGS, AND JOINTS SHALL BE THE SAME SPECIFICATIONS AS FOR PIPE. CASTINGS ARE AS SHOWN ON DETAIL AND SHALL CONFORM TO ASTM A48 (GRADE 30). CLEANOUT RISER SHALL MATCH DOWNSTREAM PIPE DIAMETER. FRAME SHALL SIT ON 24"X24" CONCRETE PAD.
- 5. GRANULAR BACKFILL (3/4"-0) IS TO BE COMPACTED TO 95%
  MAXIMUM DRY DENSITY PER AASHTO T-180 TEST METHOD AND
  NATIVE MATERIAL SHALL BE COMPACTED TO 95% OF IN-PLACE DRY
  DENSITY OF SURROUNDING SOIL. EXCAVATION, BEDDING, AND
  BACKFILL SHALL BE IN ACCORDANCE WITH DIVISION 204 OF THE
  CITY OF WEST LINN STANDARD CONSTRUCTION SPECIFICATIONS.
  BACKFILL UNDER NEW STREETS SHALL BE CLASS "B" AND BACKFILL
  IN EXISTING STREETS SHALL BE CLASS "E".
- 6. PVC SERVICE LATERALS SHALL BE 4" PIPE CONFORMING TO THE SAME SPECIFICATIONS AS THE SEWER MAINS. SERVICE LATERALS SHALL BE INSTALLED TO A POINT BEYOND THE LINE OF THE SEWER OR UTILITY EASEMENT AS SHOWN ON THE PLAN. THE SERVICE LATERAL SHALL BE PLUGGED WITH A 4" RUBBER RING PLUG, AND THE LOCATION OF THE LATERAL'S END MARKED WITH A 2"X4" STAKE PAINTED GREEN.
- 7. SANITARY SEWER PIPE AND APPURTENANCES SHALL BE TESTED FOR LEAKAGE IN ACCORDANCE WITH W.LS.C.S. DIVISION 301.03.09 AND MANHOLES SHALL BE VACUUM TESTED IN ACCORDANCE WITH W.L.S.C.S. DIVISION 302.03.07. ALL TESTS SHALL BE WITNESSED BY THE ENGINEER AND THE CITY OF WEST LINN. CONTRACTOR IS RESPONSIBLE FOR COORDINATING TESTING SO THAT ALL TEST SHALL BE PASSED AND NEW LINE SHALL BE ACCEPTED PRIOR TO CONNECTION TO EXISTING SYSTEM.
- A PLUMBING PERMIT FROM THE CITY OF WEST LINN BUILDING DEPARTMENT IS REQUIRED FOR SANITARY SEWER LATERALS BEYOND THE FIRST CLEANOUT.
- ALL MATERIALS, INSTALLATION, TEST, AND INSPECTIONS TO BE MADE IN STRICT ACCORDANCE WITH CITY OF WEST LINN PUBLIC WORKS STANDARD CONSTRUCTION SPECIFICATIONS.

### GENERAL GRADING AND EROSION CONTROL (PART 1)

- APPROVAL OF THIS EROSION CONTROL (ESC) PLAN DOES NOT CONSTITUTE ON APPROVAL OF PERMANENT ROAD OR DRAINAGE DESIGN (E.G. SIZE AND LOCATION OF ROADS, PIPES, RESTRICTORS, CHANNELS, RETENTION FACILITIES, UTILITIES, ETC.)
- THE IMPLEMENTATION OF THESE ESC PLANS AND THE CONSTRUCTION, MAINTENANCE, REPLACEMENT, AND UPGRADING OF THESE ESC FACILITIES IS THE RESPONSIBILITY OF THE APPLICANT/CONTRACTOR UNTIL ALL CONSTRUCTION IS COMPLETED AND APPROVED, AND VEGETATION OF LANDSCAPING IS ESTABLISHED.
- THE ESC FACILITIES ON THIS PLAN MUST BE CONSTRUCTED IN CONJUNCTION WITH ALL CLEARING AND GRADING ACTIVITIES, AND IN SUCH A MANNER AS TO ENSURE THAT SEDIMENT LADEN WATER DOES NOT ENTER THE DRAINAGE SYSTEM OR VIOLATE APPLICABLE WATER STANDARDS.
- 4. THE ESC FACILITIES SHOWN ON THIS PLAN ARE THE MINIMUM REQUIREMENTS FOR ANTICIPATED SITE CONDITIONS. DURING THE CONSTRUCTION PERIOD, THESE ESC FACILITIES SHALL BE UPGRADED AS NEEDED FOR UNEXPECTED STORM EVENTS AND TO ENSURE THAT SEDIMENT LADEN WATER DOES NOT LEAVE THE SITE.
- THE ESC FACILITIES SHALL BE INSPECTED DAILY BY THE APPLICANT/CONTRACTOR AND MAINTAINED AS NECESSARY TO ENSURE THEIR CONTINUED FUNCTIONING.
- THE ESC FACILITIES ON INACTIVE SITES SHALL BE INSPECTED AND MAINTAINED A MINIMUM OF ONCE A MONTH, OR WITHIN 24 HOURS FOLLOWING A STORM EVENT.
- 7. AT NO TIME SHALL MORE THAN ONE FOOT OF SEDIMENT BE ALLOWED TO ACCUMULATE WITHIN A TRAPPED CATCH BASIN. ALL CATCH BASINS AND CONVEYANCE LINES SHALL BE CLEANED PRIOR TO PAVING. THE CLEANING OPERATION SHALL NOT FLUSH SEDIMENT LADEN WATER INTO THE DOWNSTREAM SYSTEM.
- 8. STABILIZED CONSTRUCTION ENTRANCES SHALL BE INSTALLED AT THE BEGINNING OF CONSTRUCTION AND MAINTAINED FOR THE DURATION OF THE PROJECT. ADDITIONAL MEASURES MAY BE REQUIRED TO ENSURE THAT ALL PAVED AREAS ARE KEPT CLEAN FOR THE DURATION OF THE PROJECT.

### WATER NOTES

- 1. WATER MAINS SHALL BE DUCTILE IRON PIPE CONFORMING TO AWWA C151 CLASS 52. PIPE IS TO HAVE CEMENT MORTAR LINING AND BITUMINOUS SEAL COAT CONFORMING TO AWWA C104. JOINTS ARE TO BE PUSH-ON RUBBER GASKETED JOINTS UNLESS NOTED OTHERWISE ON THE PLAN. PIPE FITTINGS ARE TO BE OF THE SAME MATERIAL AND CLASS AS PIPE OF DOMESTIC ORIGIN.
- 2. WATER MAINS HAVE A MINIMUM COVER OF 36".
- 3. THRUST BLOCKS ARE TO BE PROVIDED AT ALL CHANGES IN DIRECTION AND BRANCHES. THRUST BLOCKING CONCRETE STRENGTH IS TO BE 3300 PSI. SEE DETAILS FOR THRUST BLOCK SIZING. POUR THRUST BLOCKS AGAINST UNDISTURBED EARTH.
- 4. GATE VALVES SHALL BE RESILIENT SEAT, NON-RISING STEM WITH "0" RING PACKING, COMPLYING WITH AWWA CLASS "C" SPECIFICATIONS. THE VALVES SHALL BE DESIGNED TO WITHSTAND A WORKING PRESSURE OF 150 PSI. GATE VALVES SHALL BE FURNISHED WITH A TWO-INCH SQUARE OPERATING NUT AND SHALL OPEN COUNTERCLOCKWISE WHEN VIEWING FROM ABOVE. BUTTERFLY VALVES SHALL BE RUBBER SEAT TYPE AND BUBBLE-TIGHT AT 150 PSI, AND SHALL CONFORM TO AWWA C504. BUTTERFLY VALVES SHALL BE MUELLER OR APPROVED EQUAL. OPERATING NUT SHALL BE LOCATED ON THE SIDE OF THE MAIN SHOWN ON THE PLANS. VALVE BOXES SHALL BE "VANCOUVER" PATTERN.
- 5. GRANULAR BACKFILL (3/4" -0) IS TO BE COMPACTED TO 95% MAXIMUM DRY DENSITY PER AASHTO T 180 TEST METHOD AND NATIVE MATERIAL SHALL BE COMPACTED TO 95% OF IN-PLACE DRY DENSITY OF SURROUNDING SOIL. EXCAVATION, BEDDING, AND BACKFILL SHALL BE IN ACCORDANCE WITH DIVISION 204 OF THE CITY OF WEST LINN STANDARD CONSTRUCTION SPECIFICATIONS. BACKFILL UNDER NEW STREETS SHALL BE CLASS "E".
- 6. SERVICE LATERALS SHALL BE TYPE K COPPER LATERAL SIZES SHALL BE 1". FOR DOUBLE SERVICES TWO 1" WATER SERVICES SHALL BE LAID SIDE BY SIDE. CORPORATION STOPS SHALL BE MUELLER H 15008 OR FORD F1000 4Q. ANGLE METER STOP SHALL BE MUELLER H 14258 OR FORD 1" KV43-444W-Q. METER BOXES SHALL BE EQUAL TO BROOKS #37 WITH A 37-S LID AND COVER. METER BOXES ARE TO BE INSTALLED 3/4" ABOVE FINISH GRADE AND 2- 1/2" FROM THE CURB IN PLANTER STRIPS OR FLUSH WITH SIDEWALK SURFACE IN A SIDEWALK.
- 7. ALL WATERLINES WILL BE PRESSURE TESTED AND PURIFICATION TESTED BEFORE CONNECTION TO THE CITY WATER SYSTEM. PRESSURE TEST SHALL BE CONDUCTED AT 180 PSI OR 1.5 TIMES THE NORMAL WORKING PRESSURE, WHICHEVER IS HIGHER AND SHALL MEET THE REQUIREMENTS OF DIVISION 403.14 OF THE WEST LINN PUBLIC WORKS STANDARD CONSTRUCTION SPECIFICATIONS.
- 8. CHLORINATION SHALL CONFORM WITH DIVISION 403.13 OF THE W.L.S.C.S.
- DO NOT CONNECT NEW PIPE TO EXISTING PIPE PRIOR TO TESTING.
  THE CITY OF WEST LINN REQUIRES ACCEPTANCE OF NEW
  WATERLINE PRIOR TO CONNECTION TO EXISTING WATER SYSTEM.
- A PLUMBING PERMIT IS REQUIRED FOR SERVICE LATERAL INSTALLATIONS BEYOND THE WATER METER.
- ALL MATERIALS, INSTALLATION, TESTS, AND CHLORINATION TO BE IN STRICT ACCORDANCE WITH THE CITY OF WEST LINN PUBLIC WORKS STANDARD CONSTRUCTION SPECIFICATIONS, AND THE OREGON STATE HEALTH DIVISION ADMINISTRATION RULES, CHAPTER 333.

### GENERAL GRADING AND EROSION CONTROL (PART 2)

- CLEAN WASTE MATERIAL EXCAVATED FROM ROAD CUT OR TRENCHING AREAS NOT USED IN STREET FILL AREAS MAY BE SPREAD EVENLY ACROSS LOT AREAS IN DEPTHS NOT TO EXCEED SIX INCHES, EXCEPT WHERE NOTED OTHERWISE ON THE PLANS.
- DURING CONSTRUCTION, STRAW BALES, CUTOFF TRENCHES OR SOME OTHER METHOD OF RUNOFF CONTROL SHALL BE USED TO PREVENT EROSION AND/OR SILTATION FROM CROSSING OUTSIDE THE WORK AREA BOUNDARIES.
- LARGE ORGANIC MATERIAL, MISCELLANEOUS PIPE OR CONSTRUCTION MATERIAL MUST BE REMOVED FROM THE SITE AND DISPOSED OF PROPERLY.
- 4. NO FILLING OR CUTTING SHALL BE DONE OUTSIDE OF APPROVED GRADING AREAS.
- 5. ALL EROSION CONTROL FACILITIES SHALL MEET THE REQUIREMENTS OF THE CLACKAMAS COUNTY DEPARTMENT OF UTILITIES, EROSION PREVENTION AND SEDIMENT CONTROL PLANS TECHNICAL GUIDANCE HANDBOOK (ECTGH), REVISED AUGUST, 1994; CHAPTER 31 OF THE COMMUNITY DEVELOPMENT CODE; AND THE OREGON ADMINISTRATIVE RULES.

### STORM SEWER NOTES

- 1. EIGHT INCH TO 24-INCH STORM DRAIN PIPE IS PREFERRED TO BE SEAMLESS RIBBED PVC PIPE CONFORMING TO ASTM F 794. WHERE LARGER PIPE IS REQUIRED OR LACK OF COVER PREVENTS USE OF RIBBED PVC PIPE, PIPE SHALL BE CLASS 3 NON-REINFORCED, CONCRETE PIPE CONFORMING TO ASTM C14, REINFORCED CONCRETE PIPE CONFORMING TO ASTM C-76, CLASS IV, OR DUCTILE IRON PIPE CONFORMING TO AWWA C151 CLASS 52. RUBBER JOINTS ARE REQUIRED FOR ALL CONCRETE PIPE. SIX INCH AND SMALLER STORM DRAIN PIPE SHALL CONFORM TO ASTM D 3034 PVC PIPE.
- GUTTER INLETS SHALL BE POURED IN-PLACE CONCRETE WITH A MINIMUM COMPRESSIVE STRENGTH OF 3300 PSI. FRAME SHALL BE FABRICATED OF STRUCTURAL STEEL, ASTM A-7, A-36, A-373.
- 3. MANHOLE BASE MAY BE POURED IN PLACE CONCRETE WITH A MINIMUM COMPRESSIVE STRENGTH OF 3300 PSI OF PRECAST. MANHOLE RISERS AND TOPS SHALL BE PRECAST SECTIONS WITH A MINIMUM COMPRESSIVE STRENGTH OF 4000 PSI. TOPS SHALL BE ECCENTRIC CONES EXCEPT WHERE INSUFFICIENT HEADROOM REQUIRES FLAT TOPS. INTERIOR DIMENSIONS NOTED ON THE PLANS ARE MINIMUMS. SOME OR ALL OF THE STORM DRAIN REQUIRED WILL BE OVERSIZED MANHOLES, CONTRACTOR SHALL CHECK WITH MANHOLE MANUFACTURER FOR ACTUAL SIZE OF MANHOLE NEEDED FOR TYPE AND SIZE OF PIPE TO BE USED. INVERTS SHALL BE CONSTRUCTED SO AS TO PROVIDE SMOOTH FLOW-THROUGH CHARACTERISTICS. PIPE SHALL BE CONNECTED TO MANHOLE BY MEANS OF A FLEXIBLE CONNECTION AND SHALL HAVE A SHEAR JOINT LOCATED 18" OUTSIDE OF THE MANHOLE.
- 4. ALL MANHOLES LOCATED IN EASEMENT AREAS REQUIRE TAMPER PROOF LIDS AND LID SHALL BE SET 12 INCHES ABOVE PROPOSED GRADE
- CLEANOUT PIPE, FITTINGS, AND JOINTS SHALL BE THE SAME SPECIFICATIONS AS FOR PIPE. CASTINGS ARE SHOWN ON DETAILS AND SHALL CONFORM TO ASTM A48 (GRADE 30). CLEANOUT RISER SHALL MATCH DOWNSTREAM PIPE DIAMETER.
- GRANULAR BACKFILL (3/4"-0) IS TO BE COMPACTED TO 95%
   MAXIMUM DRY DENSITY PER AASHTO T-180 TEST METHOD AND
   NATIVE MATERIAL SHALL BE COMPACTED TO 95% OF IN-PLACE DRY
   DENSITY OF SURROUNDING SOIL.
- 7. STORM DRAIN SERVICE LATERALS SHALL BE 4" PIPE CONFORMING TO THE SAME SPECIFICATIONS AS THE STORM DRAIN MAIN LINES. SERVICES LATERALS SHALL BE INSTALLED TO A POINT BEYOND THE LINE OR UTILITY EASEMENT AS SHOWN ON THE PLAN. THE SERVICE LATERAL SHALL BE PLUGGED WITH 4" RUBBER RING PLUG, AND THE LOCATION OF THE LATERALS END MARKED WITH A 2'X4" STAKE PAINTED WHITE.
- 8. STORM DRAINS SHALL BE TESTED FOR DEFLECTION IN ACCORDANCE WITH DIVISION 601.03.11 AND VIDEO INSPECTED IN ACCORDANCE WITH DIVISION 601.03.12 OF THE WEST LINN STANDARD CONSTRUCTION SPECIFICATIONS. ALL TESTS SHALL BE WITNESSED BY THE ENGINEER AND A REPRESENTATIVE OF THE CITY.
- A PLUMBING PERMIT FORM THE CITY OF WEST LINN BUILDING DEPARTMENT IS REQUIRED FOR STORM DRAINS BEYOND THE FIRST CLEANOUT.
- ALL MATERIALS, INSTALLATION, TESTS, AND INSPECTIONS TO BE IN STRICT ACCORDANCE WITH THE CITY OF WEST LINN STANDARD CONSTRUCTION SPECIFICATIONS.
- INFILTRATION RAIN GARDEN PLANTINGS TO CONFORM TO PLANTING SPECIFICATION AS SHOWN ON THE PLANS AND DETAILS CONTAINED HEREIN.

1. THE INTENT OF THE REQUIREMENT IS TO PREVENT SILTATION FROM

REACHING STORM DRAIN SYSTEMS AND DRAINAGE WAYS.

THE MINIMUM MEASURES NEED TO BE MADE ON ALL PROJECTS.

VEHICLES WILL LEAVE THE CONSTRUCTION SITE.

WILL CROSS OUTSIDE THE WORK AREA.

SOON AS POSSIBLE.

A. A GRAVEL PAD, AT LEAST 50 FEET LONG, IS REQUIRED WHERE

B. A SEDIMENT BARRIER IS TO BE CONSTRUCTED OF STRAW BALES OR A

C. WHERE EXCAVATED MATERIAL IS PLACED ON HARD SURFACES (SUCH

D. RE-SEED OR COVER DISTURBED AREAS AS SOON AS IS POSSIBLE AND

ON THE OTHER PHASES OF WORK, EROSION CONTROL MEASURES

SUCH AS HAY BALES AND SILT FENCES MUST REMAIN IN PLACE UNTIL

SEEDED AREAS SHOW GROWTH SUBSTANTIAL TO PREVENT EROSION.

AS STREETS) MATERIAL MUST BE BROOMED OR SCRAPED CLEAN AS

PRACTICAL BUT NO LATER THAN THE COMPLETION OF CONSTRUCTION

SEDIMENT FENCE WHERE NOTED IN THE DETAILS OR WHERE SEDIMENT

**EROSION CONTROL SUMMARY** 

### STREET NOTES

- NEW STREET SECTIONS ARE TO BE CLEARED OF ALL SURFACE VEGETATION AND OTHER MISCELLANEOUS STRUCTURES OR MATERIALS. GRUB IMPROVEMENT AREAS TO REMOVE ALL BURIED VEGETATIVE MATTER AND DEBRIS TO A DEPTH 8" BELOW SUBGRADE. PROPERLY DISPOSE OF ALL WASTE MATERIAL.
- STREET SUBGRADE SHALL CONFORM TO DIVISION 501 OF THE CITY
  OF WEST LINN STANDARD CONSTRUCTION SPECIFICATIONS.
  AREAS TO RECEIVE FILL ARE TO BE INSPECTED BY CITY OF WEST
  LINN PERSONNEL PRIOR TO PLACEMENT OF THE FILL. THE
  CONTRACTOR SHALL HAVE FILL AREAS TESTED FOR COMPACTION
  BY A CERTIFIED TESTING LAB IN ACCORDANCE WITH W.L.S.C.S.
  DIVISION 501.03.08. SUCH TESTING WILL BE AT THE CONTRACTOR'S
  EXPENSE.
- 3. AGGREGATE BASE ROCK SHALL CONFORM TO THE REQUIREMENTS OF W.L.S.C.S. DIVISION 205. BASE COURSE SHALL BE 1-1 /2" -0 CRUSHED ROCK AND LEVELING COURSE SHALL BE 3/4" -0. CITY OF WEST LINN REQUIRES A PROOF ROLL WITH A LOADED 10 YARD DUMP TRUCK OF THE SUBGRADE PRIOR TO PLACEMENT OF THE ROCK AND AGAIN AFTER PLACEMENT OF THE BASE ROCK AND PRIOR TO PAVING. ALL UNDERGROUND UTILITIES INCLUDING LATERALS, SERVICES, AND POWER OR GAS CONDUITS WILL BE IN PLACE BEFORE SUBGRADE PROOF ROLL WILL TAKE PLACE.
- 4. ASPHALT CONCRETE SHALL CONFORM TO THE REQUIREMENTS OF W.L.S.C.S. DIVISION 205. 2" BASE LIFT SHALL BE CLASS "B" A.C. AND 2" FINAL LIFT SHALL BE CLASS "C" A.C. MEETING THE SPECIFICATIONS OF W.L.S.C.S. DIVISION 505. THE TOP LIFT OF ASPHALT CONCRETE SHALL NOT BE PLACED PRIOR TO RECEIVING PERMISSION FROM THE CITY OF WEST LINN ENGINEERING DEPARTMENT.
- 5. CONSTRUCT CURB AND GUTTER USING 3300 PSI CONCRETE MEETING THE SPECIFICATIONS OF W.L.S.C.S. DIVISION 205 (AFTER 28 DAYS) WITH MAXIMUM 1-1/2" AGGREGATE SIZE. CONTRACTION JOINTS AT 15' MAXIMUM ON CENTERS. THREE INCH WEEPHOLES ARE TO BE INSTALLED ON ALL LOTS UPHILL OR EVEN WITH THE STREET. GENERALLY, WEEPHOLES SHALL BE LOCATED AT THE CENTER AND LOWEST EDGE OF CURB FOR EACH LOT. CONTRACTOR SHALL STAMP LOCATION OF SEWER AND WATER CROSSINGS WITH AN (S) OR A (W). A PROOF ROLL OF THE CURBLINES IS REQUIRED PRIOR TO POURING CURBS.
- ALL MATERIALS, INSTALLATION, TESTS, AND INSPECTIONS TO BE IN STRICT ACCORDANCE WITH CITY OF WEST LINN PUBLIC WORKS STANDARD CONSTRUCTION SPECIFICATIONS.
- 7. A STREET CONSTRUCTION ENCROACHMENT PERMIT OR SIMILAR PERMIT MAY BE REQUIRED FROM THE CITY OF WEST LINN. CONSTRUCTION PERMIT FEES OR OTHER SIMILAR FEES OR BONDING REQUIRED OF THE CONTRACTOR WILL BE THE CONTRACTOR'S RESPONSIBILITY TO OBTAIN.

APPROVED FOR CONSTRUCTION BY
CITY OF WEST LINN

This approval is only for general conformance with the design concept and general compliance with applicable codes and requirements and shall not be construed as relieving the Design Engineer of full responsibility for accuracy and completeness of the drawings. This plan review approval does not prevent the City from requiring further code corrections in the field.

DATE: BY:

### **GENERAL NOTES**

- ALL REFERENCES TO CITY DESIGN STANDARDS REFER TO THE CURRENT STANDARDS.
- THE DESIGN ENGINEER WILL BE RESPONSIBLE FOR INSPECTION OF THE PROPOSED IMPROVEMENTS WITH OVERSIGHT FROM THE CITY'S PUBLIC WORKS AND ENGINEERING STAFF.
- 3. A WORK SCHEDULE WILL BE REQUIRED FROM THE CONTRACTOR SO THAT THE ENGINEER CAN HAVE AN INSPECTOR ONSITE AT THE APPROPRIATE TIMES. IF THE WORK SCHEDULE IS REVISED THE CONTRACTOR IS TO NOTIFY THE ENGINEER AT LEAST 24 HOURS NOTICE OF ANY TESTING REQUIRING THE PRESENCE OF THE ENGINEER AND/OR CITY STAFF.
- THE CONTRACTOR IS TO RECEIVE THE APPROVAL OF THE ENGINEER AND THE CITY OF ANY PROPOSED CHANGES TO THE PLANS OR STANDARD REQUIREMENTS.
- A BUILDING DEPARTMENT PLUMBING PERMIT IS REQUIRED FOR UTILITIES BEYOND THE FIRST CLEANOUT OR METER ON PRIVATE PROPERTY.
- A PUBLIC IMPROVEMENT GUARANTEE AGREEMENT OR A PUBLIC WORKS PERMIT, A PRE-CONSTRUCTION MEETING WITH THE CITY OF WEST LINN, AND INSTALLATION OF EROSION CONTROL MEASURES ARE REQUIRED PRIOR TO BEGINNING CONSTRUCTION.
- 7. PRIOR TO SITE CLEARING, 8' TALL CHAIN-LINK FENCING SHALL BE PLACED AT TREE EASEMENT BOUNDARIES PRIOR TO SITE GRADING. THE CITY ARBORIST SHALL INSPECT & APPROVE ALL ONSITE TREE PROTECTION MEASURES PRIOR TO THE START OF THE SITE WORK. IT IS THE CONTRACTOR'S RESPONSIBILITY TO CONTACT THE CITY ARBORIST AND ARRANGE FOR THIS APPROVAL TO TAKE PLACE. NO PERMITS WILL BE ISSUED FROM ENGINEERING, PLANNING, OR BUILDING DEPARTMENTS WITHOUT TREE PROTECTION APPROVAL FROM THE CITY ARBORIST. ALL TREE PROTECTION MEASURES SHALL REMAIN IN PLACE AND FULLY FUNCTIONAL FOR THE ENTIRE TIME THAT SITE WORK AND CONSTRUCTION IS TAKING PLACE.
- 8. A CITY REPRESENTATIVE AND A REPRESENTATIVE OF THE ENGINEER MUST BE PRESENT AT ALL TESTING AND THE CITY SHALL BE FURNISHED A COPY OF ALL TEST RESULTS. IF ENGINEER OR CITY DO NOT WITNESS TESTING, CONTRACTOR WILL BE REQUIRED TO RE-TEST.
- ALL FEES FOR STREET TREES SHALL BE PAID TO THE CITY OF WEST LINN PARKS AND RECREATION DEPARTMENT.
- NO BUILDING PERMITS WILL BE GIVEN UNTIL THE IMPROVEMENTS
  HAVE BEEN ACCEPTED BY THE CITY AS SUBSTANTIALLY
  COMPLETE.
- 11. CONTRACTOR SHALL VERIFY DEPTH AND LOCATION OF EXISTING UTILITIES AND POINTS OF CONNECTION PRIOR TO ORDERING MANHOLES. IF DISCREPANCIES ARE FOUND, CONTRACTOR SHALL NOTIFY THE ENGINEER.

### SEDIMENT FENCE

- THE FILTER FABRIC SHALL BE PURCHASED IN A CONTINUOUS ROLL CUT TO THE LENGTH OF THE BARRIER TO AVOID USE OF JOINTS. WHEN JOINTS ARE NECESSARY, FILTER CLOTH SHALL BE SPLICED TOGETHER ONLY AT A SUPPORT POST, WITH A MINIMUM 6-INCH OVERLAP, AND BOTH ENDS SECURELY FASTENED TO THE POST.
- THE FILTER FABRIC FENCE SHALL BE INSTALLED TO FOLLOW THE CONTOURS, WHERE FEASIBLE. THEN FENCE POSTS SHALL BE SPACED A MAXIMUM OF SIX FEET APART AND DRIVEN SECURELY INTO THE GROUND A MINIMUM OF 18 INCHES.
- 3. A TRENCH SHALL BE EXCAVATED, ROUGHLY 6 INCHES WIDE BY 6 INCHES DEEP, UPSLOPE AND ADJACENT TO THE WOOD POST TO ALLOW THE FILTER FABRIC TO BE BURIED. BURY THE BOTTOM OF THE FABRIC 6" VERTICALLY BELOW FINISHED GRADE. ALL AREAS OF FILTER FABRIC TRENCH SHALL BE COMPACTED.
- 4. THE FILTER FABRIC SHALL BE INSTALLED WITH STITCHED LOOPS OVER FENCE POSTS. THE FENCE POST SHALL BE CONSTRUCTED OF 2" X 2" FIR, PINE, OR STEEL. THE FENCE POST MUST BE A MINIMUM OF 48" LONG. THE FILTER FABRIC SHALL NOT BE STAPLED OR ATTACHED TO EXISTING TREES.
- 5. SEDIMENT FENCES SHALL BE REMOVED WHEN THEY HAVE SERVED THEIR USEFUL PURPOSE, BUT NOT BEFORE THE UPSLOPE AREA HAS BEEN PERMANENTLY STABILIZED.
- 6. SEDIMENT FENCES SHALL BE INSPECTED BY APPLICANT/CONTRACTOR IMMEDIATELY AFTER EACH RAINFALL, AND AT LEAST DAILY DURING PROLONGED RAINFALL. ANY REQUIRED REPAIRS SHALL BE MADE IMMEDIATELY.


### SEEDING/MULCHING

- ALL AREAS DISTURBED DURING CONSTRUCTION TO BE GRADED TO DRAIN AND COMPACTED TO A MINIMUM OF 90% OF AASHTO T-99 IMMEDIATELY AFTER INSTALLATION OF UTILITIES OR GRADING.
- RECOMMENDED SEED MIXTURE: 80% ELKA DWARF PERENNIAL RYEGRASS AND 20% CREEPING RED FESCUE, BY WEIGHT. APPLICATION RATE SHALL BE 100 POUNDS MINIMUM PER ACRE.
- FERTILIZER SHALL BE 12-16-8 WITH 50% OF THE NITROGEN DERIVED FROM UREA FORMALDEHYDE, AND APPLIED AT A RATE OF 400 POUNDS PER ACRE.
- 4. SEED AND MULCH AT A RATE OF 2000 LBS/AC WITH HEAVY BONDING AGENT OR NETTING AND ANCHORS. MULCH SHALL BE A WOOD CELLULOSE FIBER OR OTHER MATERIAL SUITABLE FOR HYDROMULCHING.
- 5. TEMPORARY OR PERMANENT HYDROSEEDING ARE ACCEPTABLE SEEDING AND MULCHING MUST BE PROVIDED WHENEVER PERENNIAL COVER CANNOT BE ESTABLISHED ON SITES WHICH WILL BE EXPOSED FOR 60 DAYS OR MORE.

# GENERAL NOTES BENJAMIN HEIGHTS PARTITION





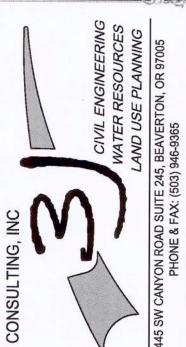


3J JOB ID # | 13117 LAND USE # | \_\_\_\_\_ TAX LOT # | 2S1E35AC 900 DESIGNED BY | KEF/CLF

SHEET TITLE
GENERAL NOTES

CHECKED BY | BKF

SHEET NUMBER

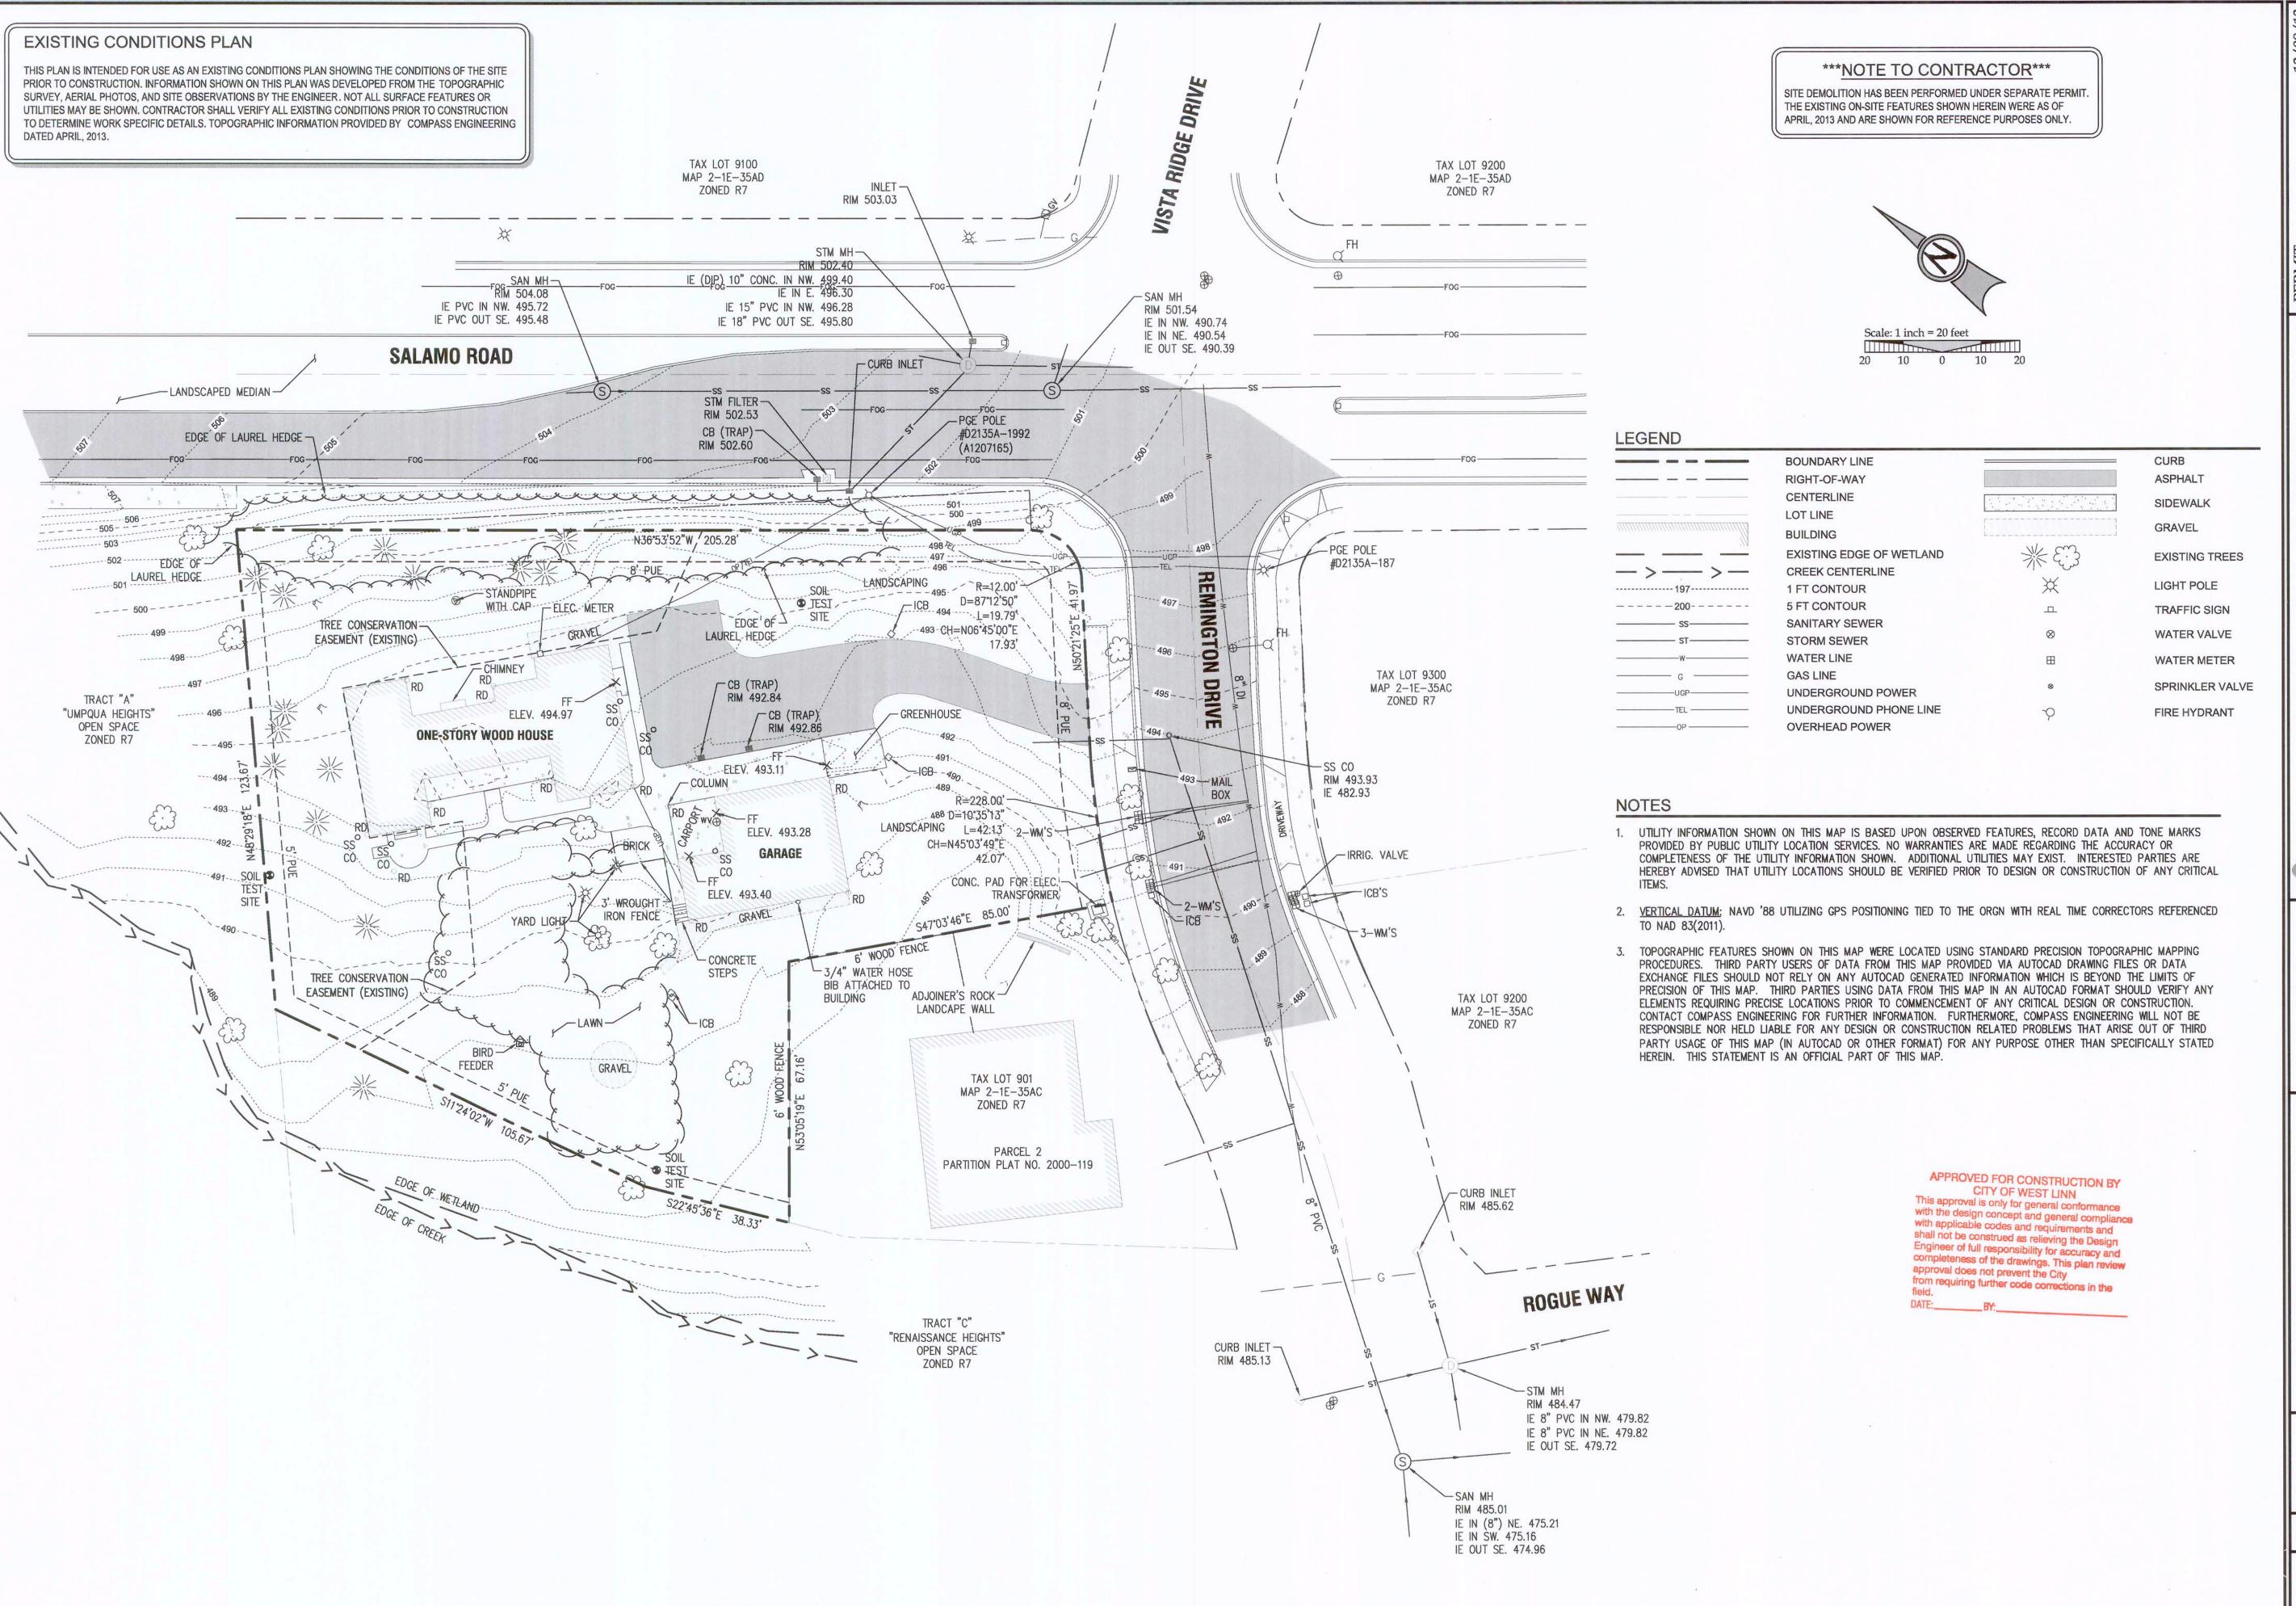

PERMIT 12/09/

EXISTING CONDITIONS SINIAMIN HEIGHTS

J.T. SMITH

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EXPIRES: 12–31–15 Digital Signature 01/08/2014

CONSULTING, INC

CIVIL ENGINEERING

WATER RESOURCES

LAND USE PLANNING


15 SW CANYON ROAD SUITE 245, BEAVERTON, OR 97005

3J JOB ID # | 13117 LAND USE # | \_\_\_\_

TAX LOT # | 2S1E35AC 900
DESIGNED BY | KEF/CLF

CHECKED BY | BKF
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EXISTING COND.'S
SHEET NUMBER

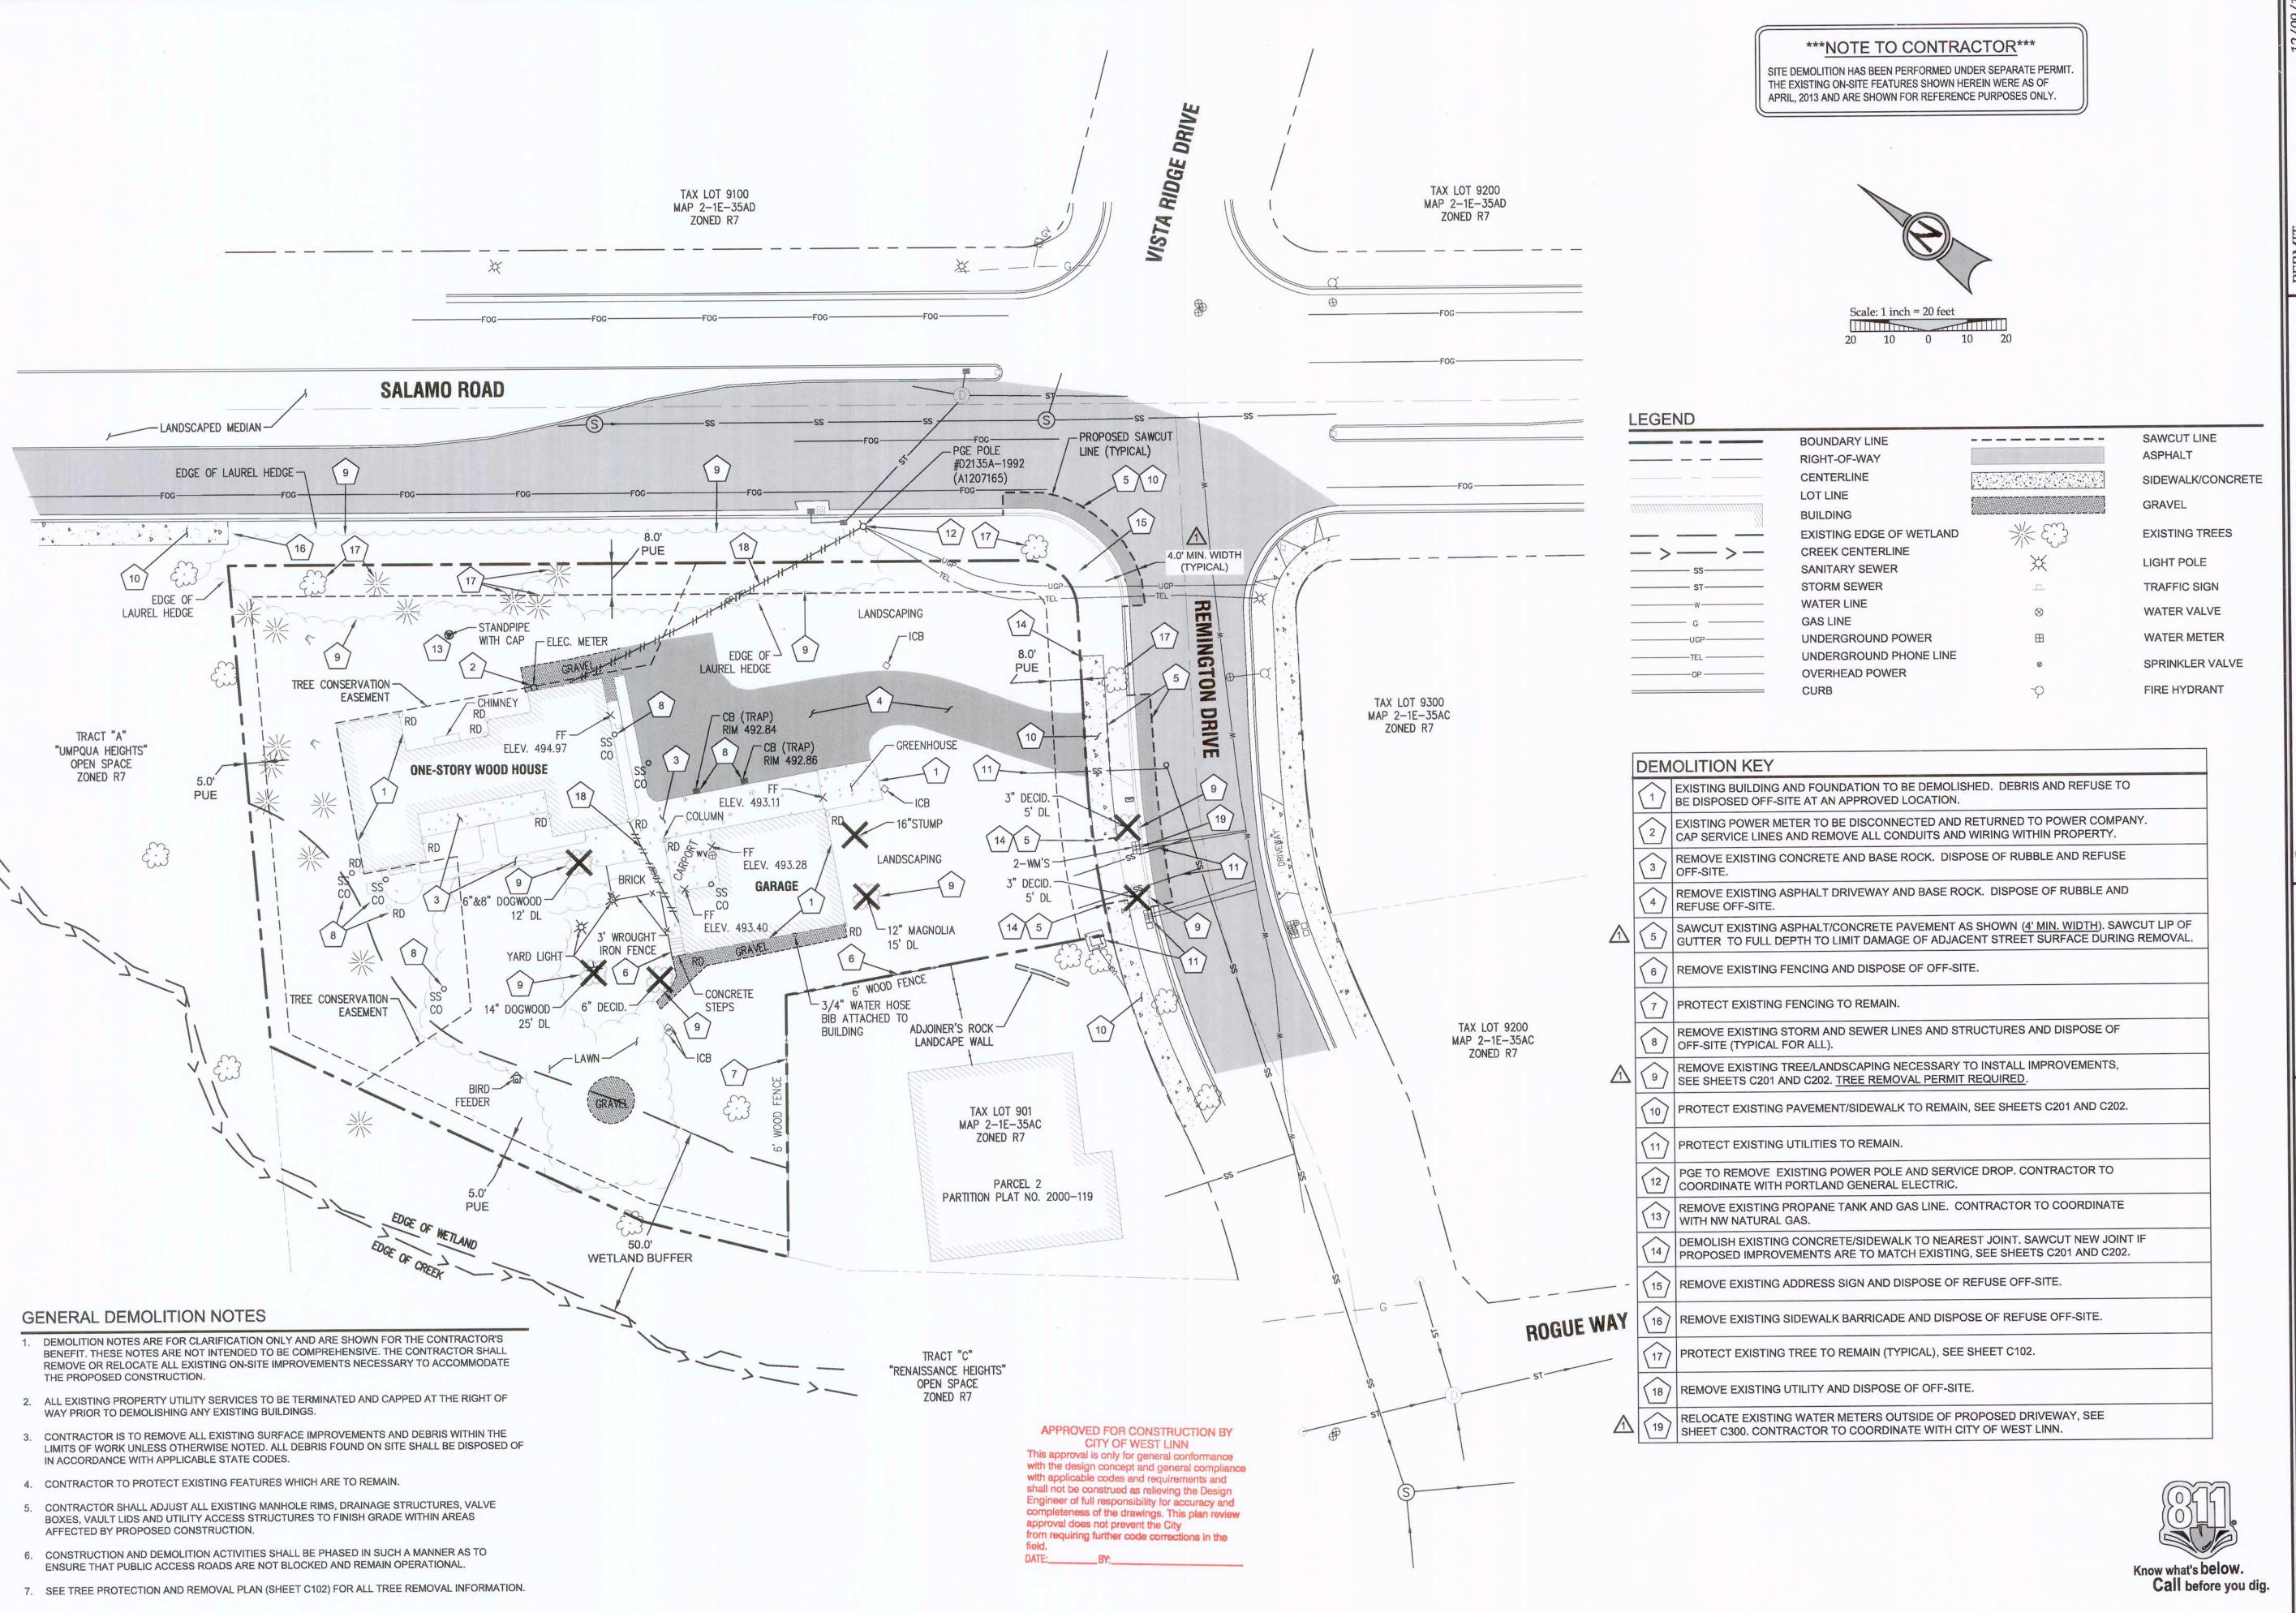


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J.T. SMITF



EXPIRES: 12-31-15 Digital Signature 01/08/2014

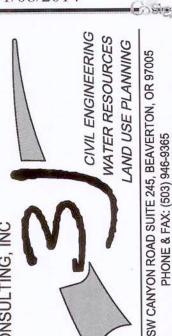


3J JOB ID # | 13117

LAND USE # | \_\_\_\_ TAX LOT # | 2S1E35AC 900

DESIGNED BY | KEF/CLF CHECKED BY | BKF

SHEET TITLE **DEMOLITION** 

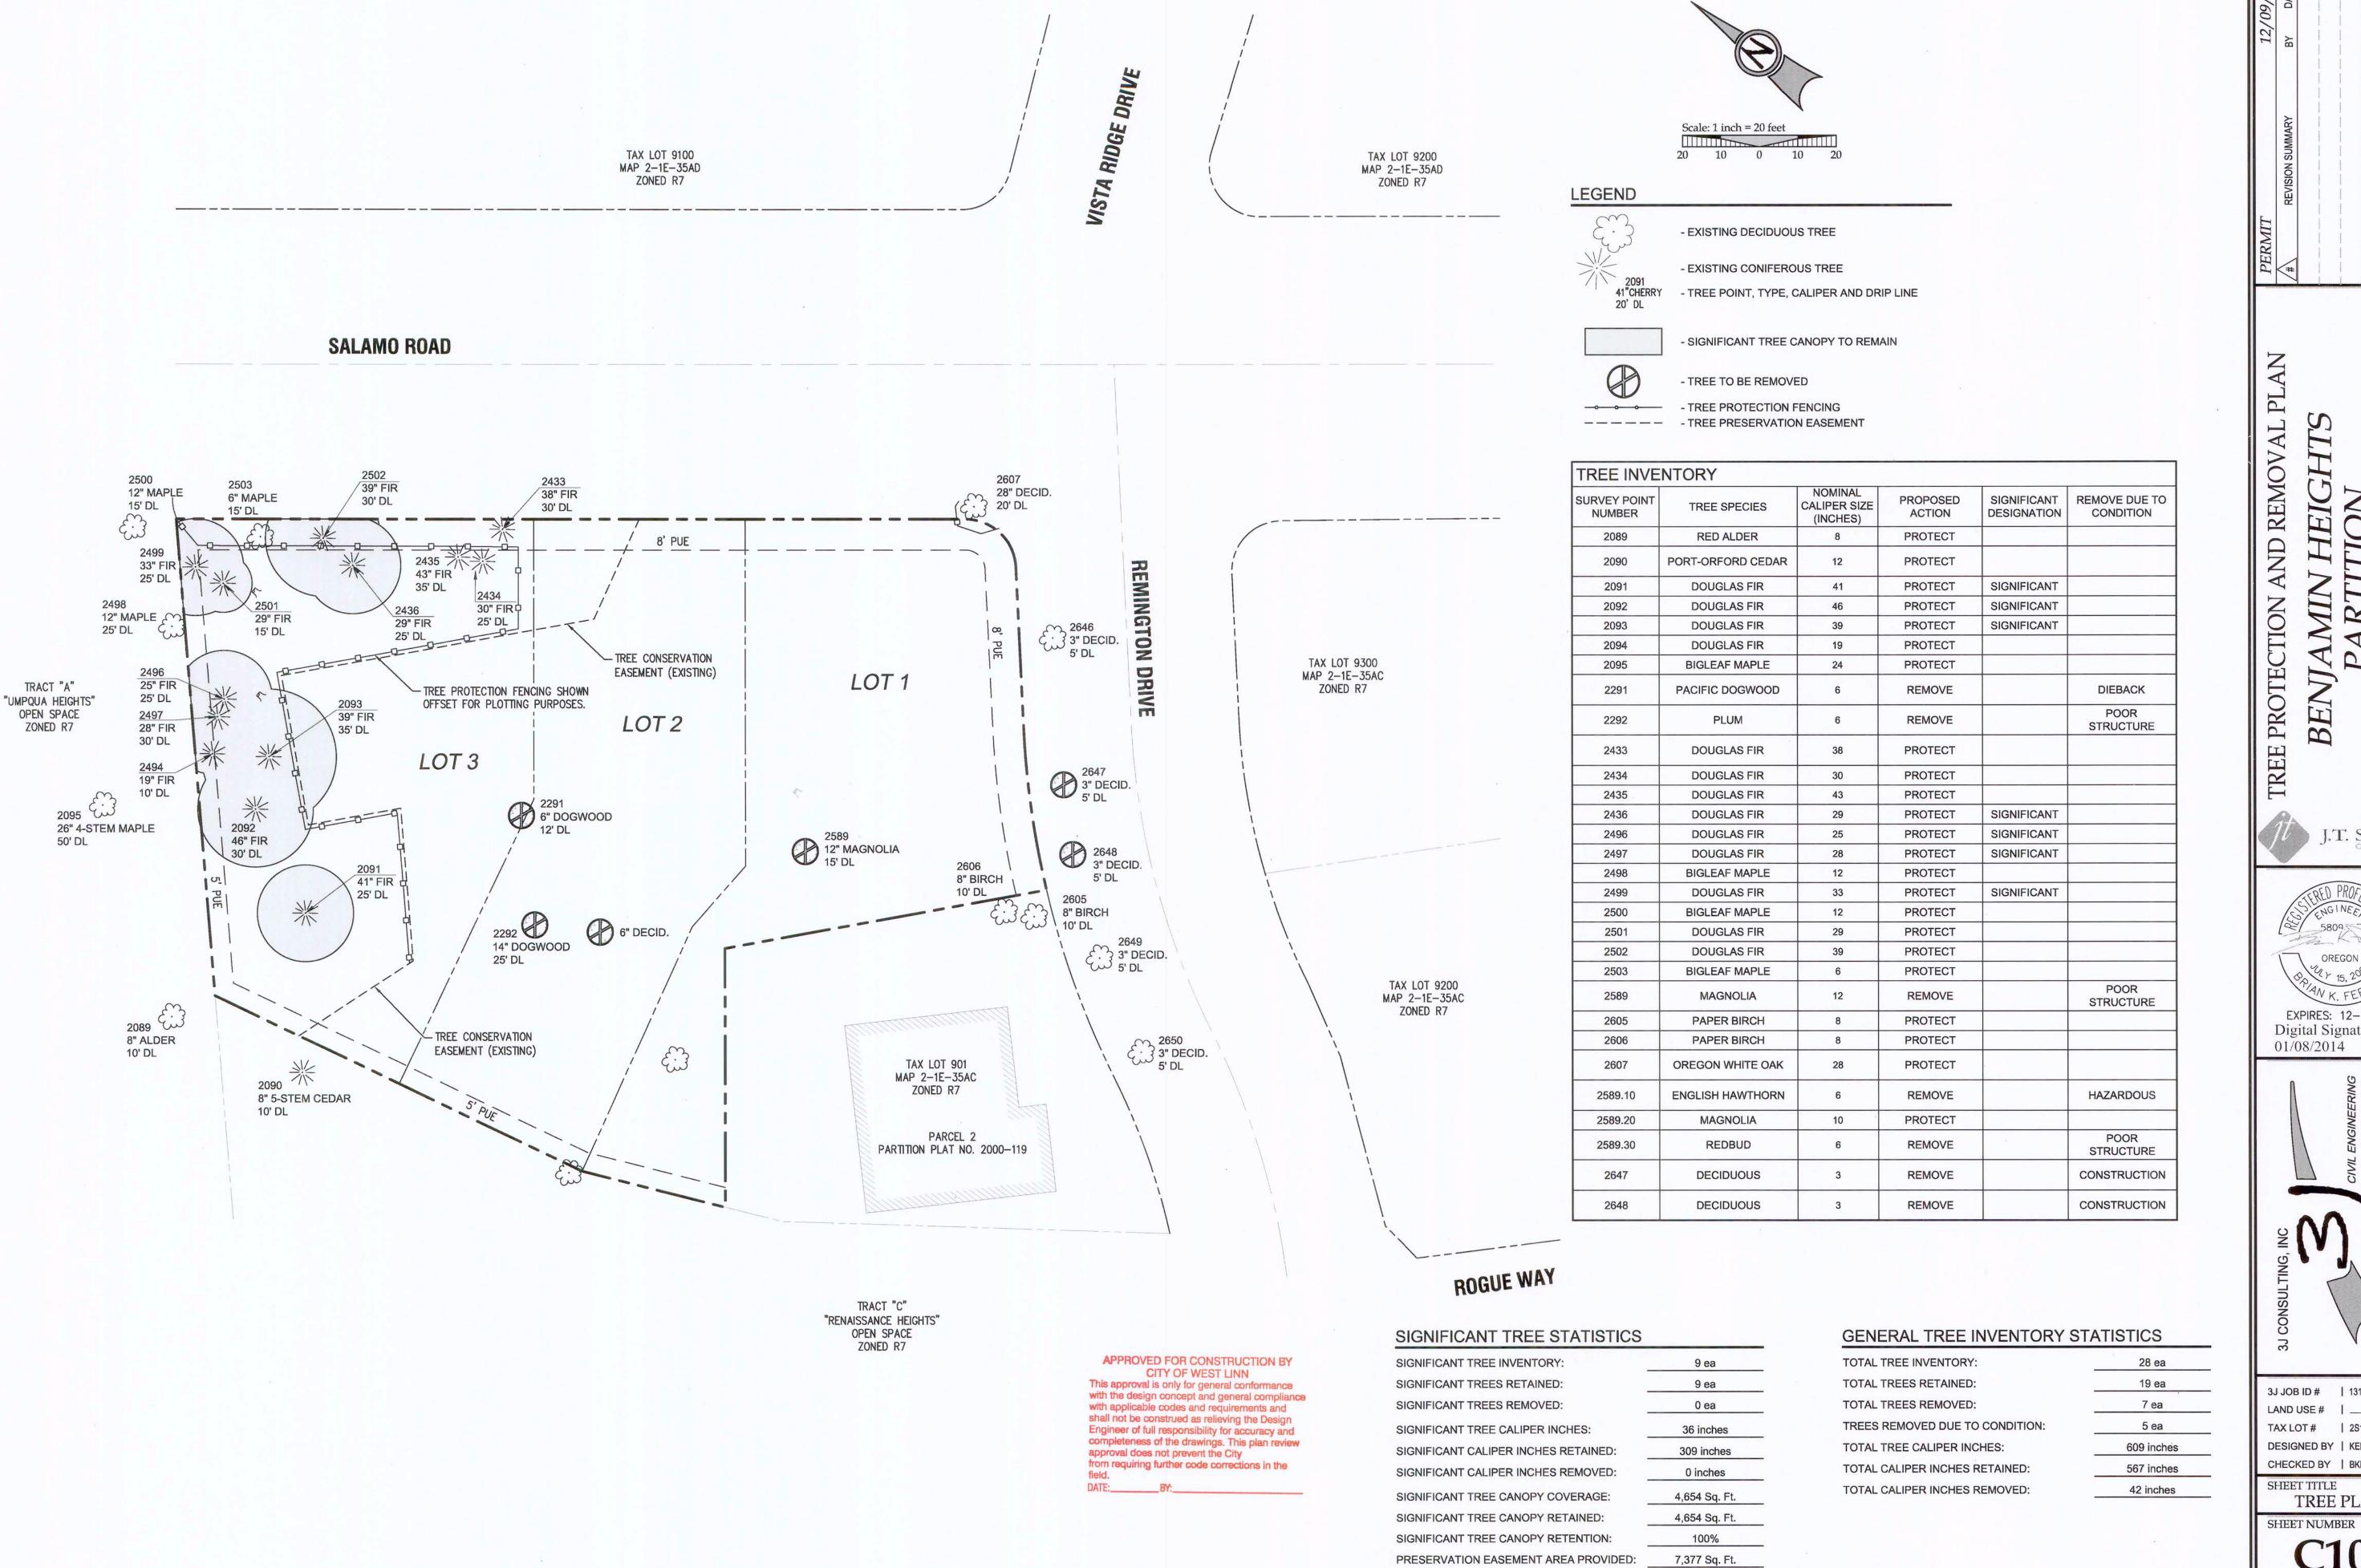

HEIGHTS BENI

J.T. SMITH

5809.5 OREGON EXPIRES: 12-31-15


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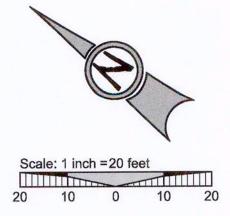
3J JOB ID # | 13117 LAND USE # | \_\_\_\_

TAX LOT # | 2S1E35AC 900

DESIGNED BY | KEF/CLF CHECKED BY | BKF

SHEET TITLE TREE PLAN



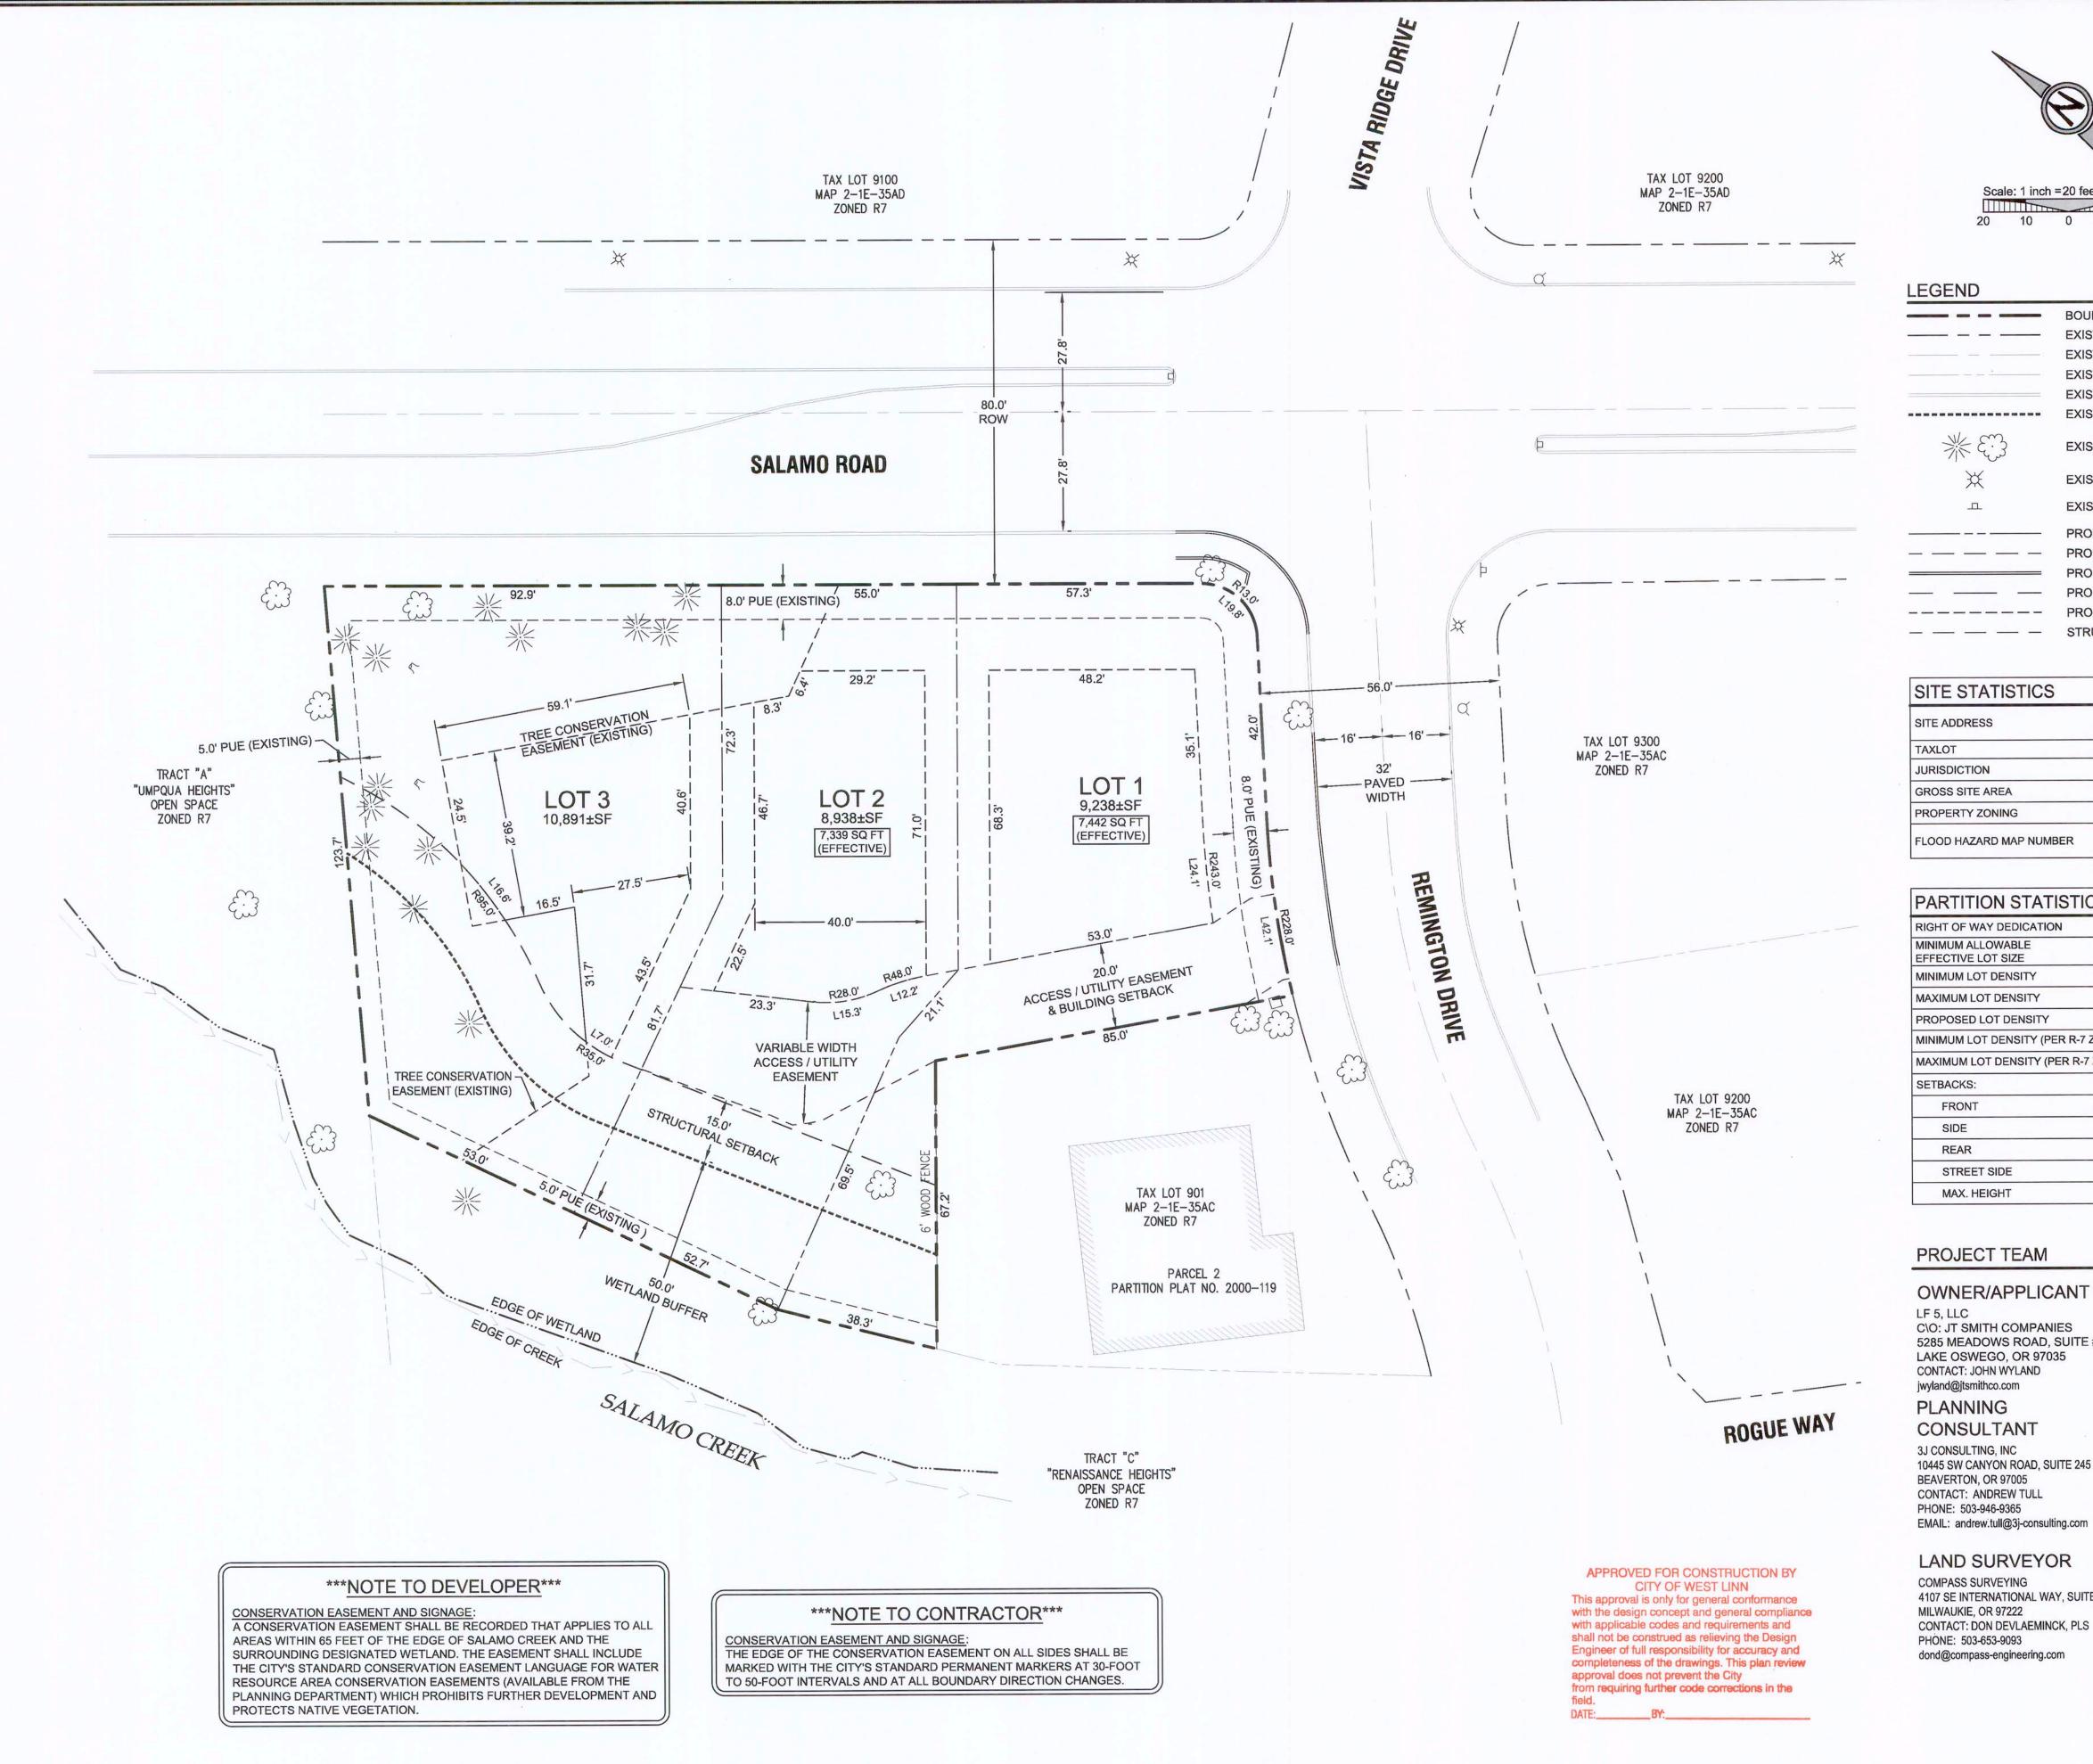

BOUNDARY LINE
EXISTING RIGHT-OF-WAY
EXISTING CENTERLINE
EXISTING LOT LINE
EXISTING CURB
EXISTING 50' WETLAND BUFFER
EXISTING TREES
EXISTING LIGHT POLE
EXISTING TRAFFIC SIGN
PROPOSED LOT LINE
PROPOSED 20 FT ACCESS / UTILITY EASEMENT
PROPOSED CURB
PROPOSED ACCESS/DRIVEWAY BOUNDARY
PROPOSED BUILDING SETBACK LINE
STRUCTURAL SETBACK LINE

SITE ADDRESS	23451 SALAMO ROAD WEST LINN, OREGON
TAXLOT	2S1E35AC 00900
JURISDICTION	CITY OF WEST LINN
GROSS SITE AREA	0.67 ACRES
PROPERTY ZONING	R-7
FLOOD HAZARD MAP NUMBER	41005C0257D ZONE X (UNSHADED)

RIGHT OF WAY DEDICATION	N/A
MINIMUM ALLOWABLE EFFECTIVE LOT SIZE	7,000 SF
MINIMUM LOT DENSITY	2.91 UNITS
MAXIMUM LOT DENSITY	4.15 UNITS
PROPOSED LOT DENSITY	4.48 UNITS/ACRE
MINIMUM LOT DENSITY (PER R-7 ZONING)	4.34 UNITS/ACRE
MAXIMUM LOT DENSITY (PER R-7 ZONING)	6.20 UNITS/ACRE
SETBACKS:	
FRONT	20 FEET
SIDE	7.5 FEET
REAR	20 FEET
STREET SIDE	15 FEET
MAX. HEIGHT	35 FEET

### PROJECT TEAM

### OWNER/APPLICANT

C\O: JT SMITH COMPANIES 5285 MEADOWS ROAD, SUITE #171 LAKE OSWEGO, OR 97035 CONTACT: JOHN WYLAND jwyland@jtsmithco.com

10445 SW CANYON ROAD, SUITE 245 CONTACT: ANDREW TULL

LAND SURVEYOR

COMPASS SURVEYING 4107 SE INTERNATIONAL WAY, SUITE 705 CONTACT: DON DEVLAEMINCK, PLS dond@compass-engineering.com

### **CIVIL ENGINEER**

3J CONSULTING, INC. 10445 SW CANYON ROAD, SUITE 245 BEAVERTON, OR 97005 CONTACT: BRIAN FEENEY PHONE: (503) 946-9365 brian.feeney@3j-consulting.com

GEOTECHNICAL CONSULTANT GEOPACIFIC ENGINEERING, INC. 14835 SW 72ND AVENUE PORTLAND, OR 97224 CONTACT: SCOTT HARDMAN PHONE: (503) 625-4455

shardman@geopacificeng.com






EXPIRES: 12-31-15 Digital Signature

01/08/2014

3J JOB ID# | 13117 LAND USE # | \_\_\_\_ TAX LOT # | 2S1E35AC 900 DESIGNED BY | KEF/CLF CHECKED BY | BKF

SHEET TITLE TENTATIVE PLAT SHEET NUMBER

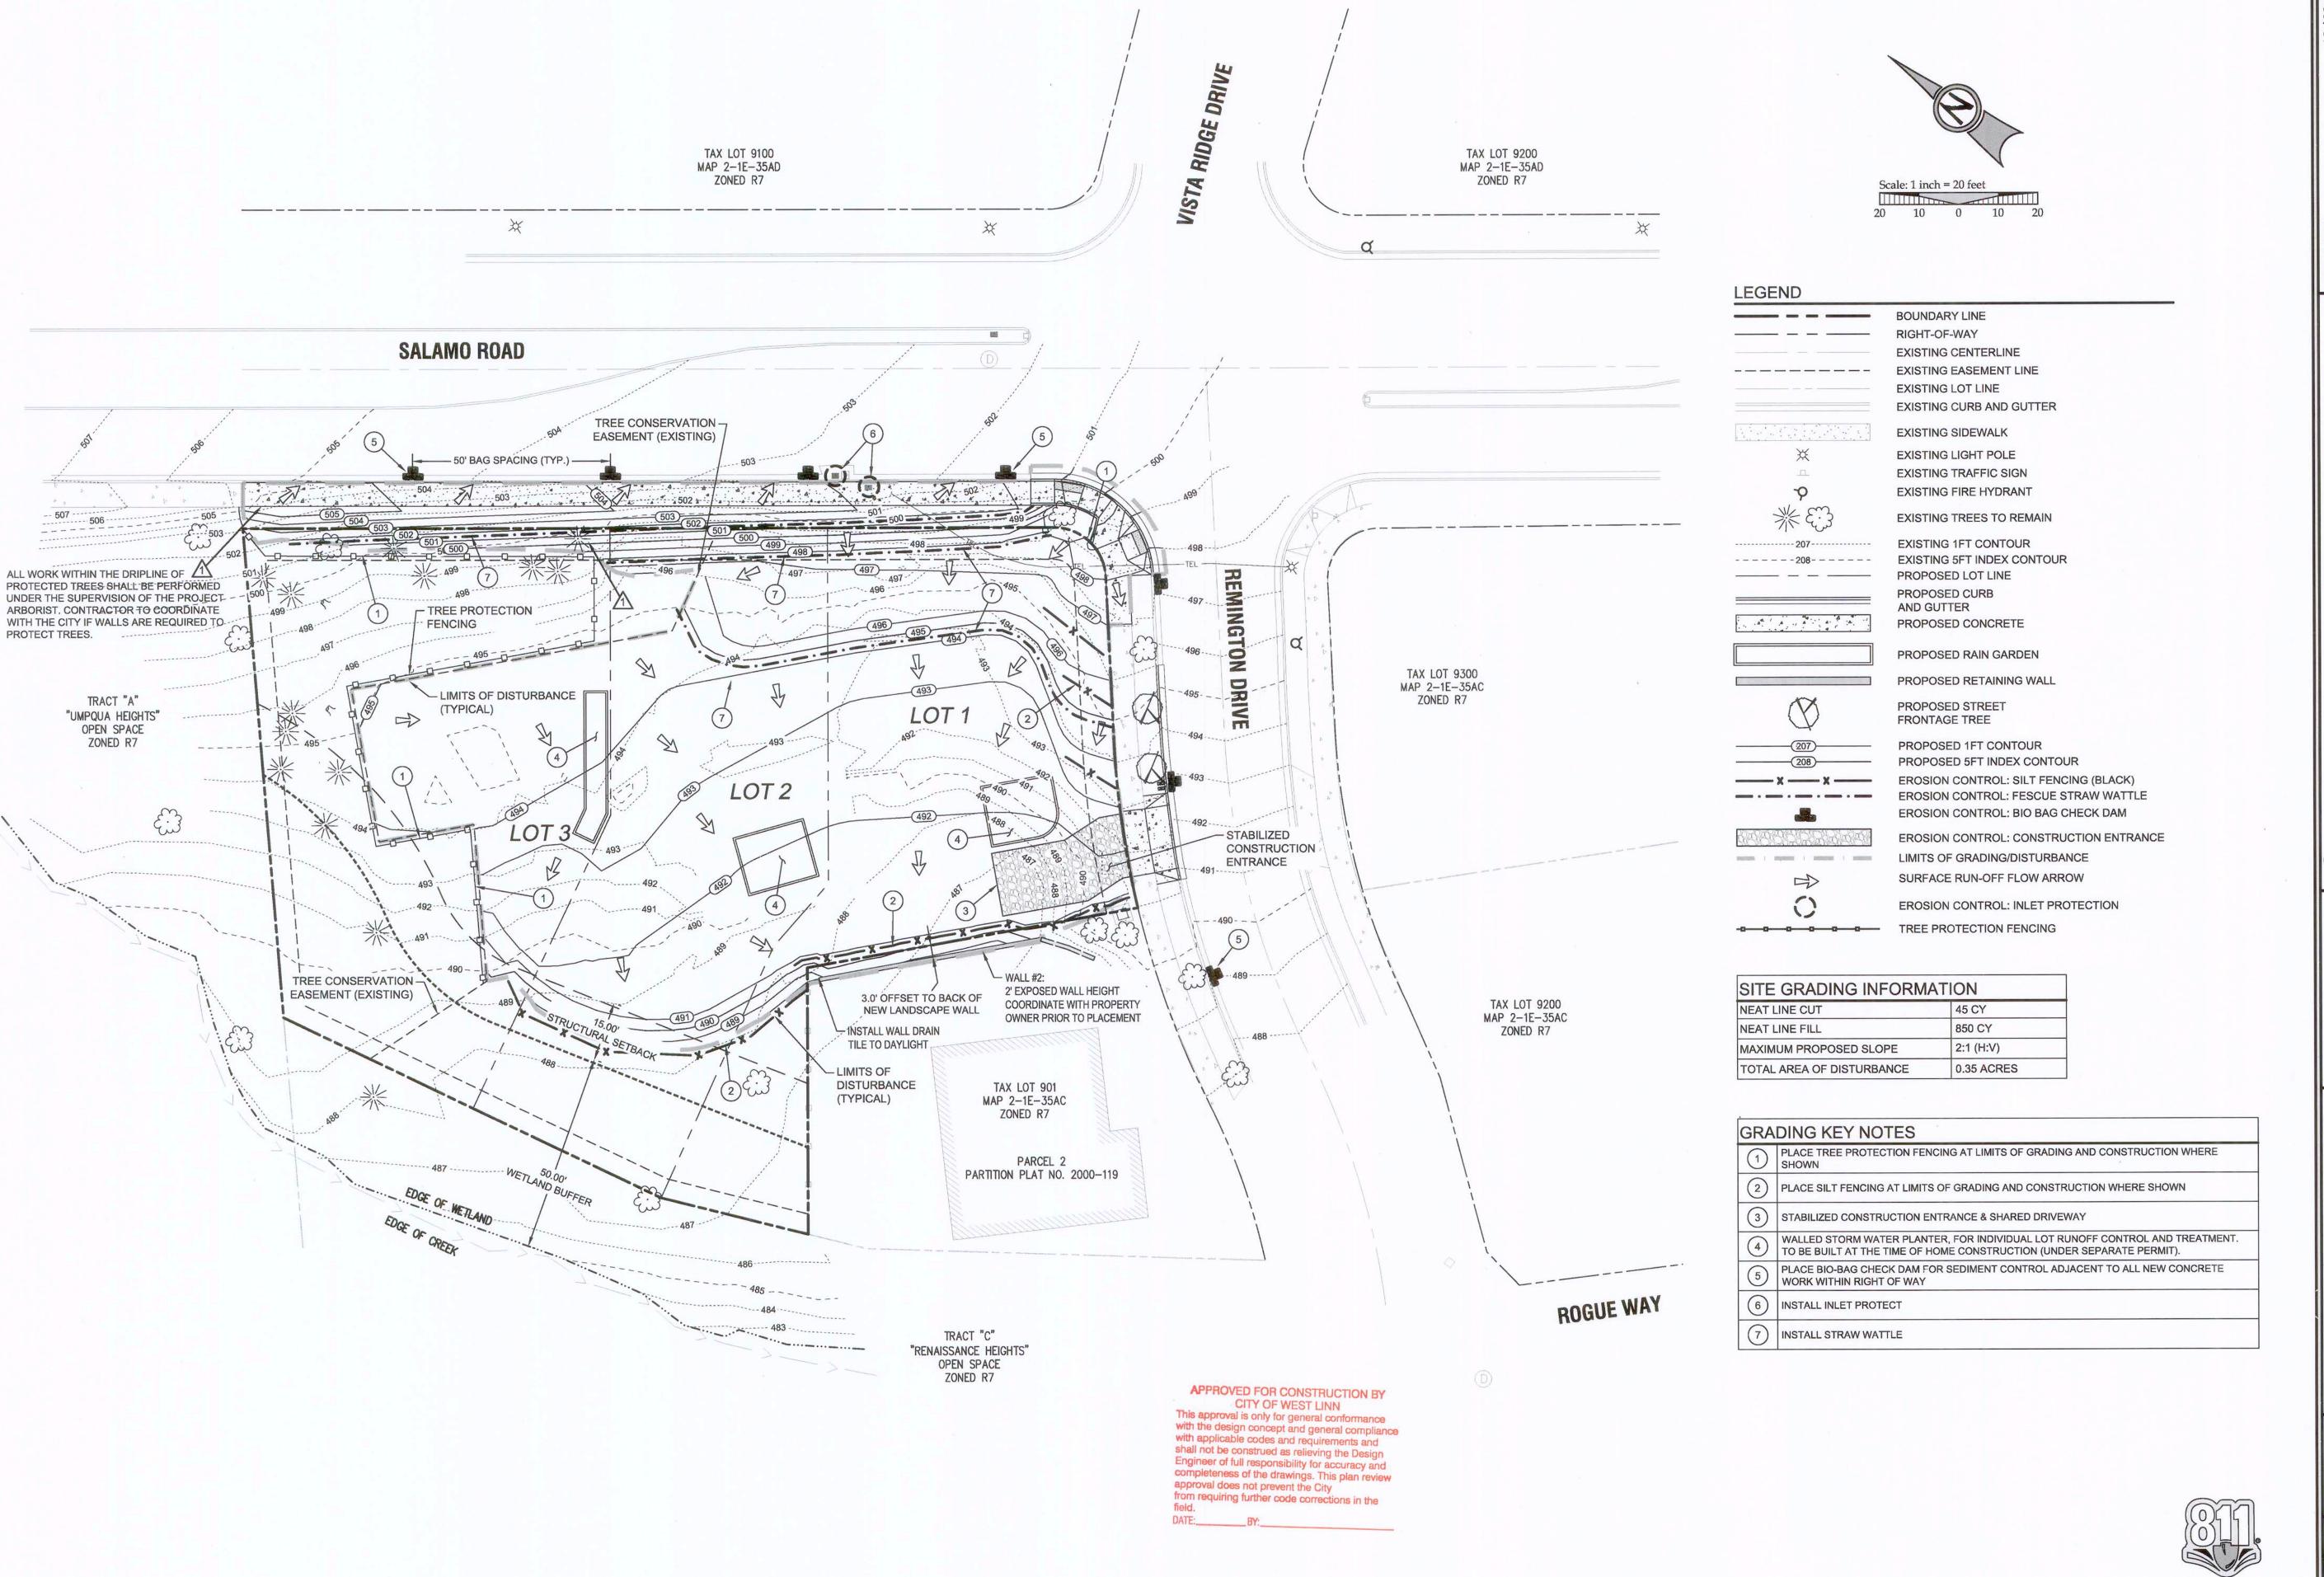

PERMIT

REVISION SUMMARY

REVISION SUMMARY

12/09/11

A

1st CITY REVIEW - REDLINE COMMENTS

AND EROSION CONTROL PLAN

J.T. SMITF

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EXPIRES: 12–31–15 Digital Signature 01/08/2014



3J JOB ID # | 13117 LAND USE # | \_\_\_\_\_ TAX LOT # | 2S1E35.

Know what's below.

Call before you dig.

LAND USE # | \_\_\_\_\_

TAX LOT # | 2S1E35AC 900

DESIGNED BY | KEF/CLF

SHEET TITLE
GRADING / ESCP

### EROSION AND SEDIMENT CONTROL PLAN NOTES

- APPLY TEMPORARY AND/OR PERMANENT SOIL STABILIZATION MEASURES IMMEDIATELY ON ALL DISTURBED AREAS AS GRADING PROGRESSES.
- CONSTRUCTION ACTIVITIES MUST AVOID OR MINIMIZE EXCAVATION AND CREATION OF BARE GROUND ON SLOPES FROM OCTOBER 1 THROUGH MAY 31 EACH YEAR.
- 3. DURING WET WEATHER PERIODS TEMPORARY STABILIZATION OF THE SITE MUST OCCUR AT THE END OF EACH WORKDAY IF RAINFALL IS FORECAST IN THE NEXT 24
- ALL EROSION AND SEDIMENT CONTROLS NOT IN THE DIRECT PATH OF WORK MUST BE INSTALLED PRIOR TO ANY LAND DISTURBANCE.
- PRESERVE EXISTING VEGETATION AND RE-VEGETATE OPEN AREAS WHEN PRACTICABLE BEFORE AND AFTER GRADING OR CONSTRUCTION.
- 6. ALL TEMPORARY SEDIMENT CONTROLS MUST REMAIN IN PLACE UNTIL PERMANENT VEGETATION OR OTHER PERMANENT COVERING OF EXPOSED SOIL IS ESTABLISHED.
- SEDIMENT CONTROLS MUST BE INSTALLED AND MAINTAINED ON ALL DOWN GRADIENT SIDES OF THE CONSTRUCTION SITE AT ALL TIMES DURING CONSTRUCTION.
- 8. ALL ACTIVE CATCH BASINS SEDIMENT CONTROLS MUST HAVE SEDIMENT CONTROLS INSTALLED AND MAINTAINED AT ALL TIMES DURING CONSTRUCTION.
- WATER-TIGHT TRUCKS MUST BE USED TO TRANSPORT SATURATED SOILS FROM THE CONSTRUCTION SITE. AN APPROVED EQUIVALENT IS TO DRAIN THE SOIL ON-SITE AT A DESIGNATED LOCATION USING APPROPRIATE BMPS SOIL MUST BE DRAINED SUFFICIENTLY FOR MINIMAL SPILLAGE.
- 10. TEMPORARY STABILIZATION OR COVERING OF SOIL STOCKPILES MUST OCCUR AT THE END OF EACH WORKDAY OR OTHER BMPS MUST BE IMPLEMENTED TO PREVENT TURBID DISCHARGES TO SURFACE WATERS.
- 11. DEVELOP AND MAINTAIN ON-SITE A WRITTEN SPILL PREVENTION AND RESPONSE
- 12. ANY USE OF TOXIC OR OTHER HAZARDOUS MATERIALS MUST INCLUDE PROPER STORAGE, APPLICATION, AND DISPOSAL.
- 13. THE PERMITEE MUST PROPERLY PREVENT AND MANAGE HAZARDOUS WASTES, USED OILS, CONTAMINATED SOILS, CONCRETE WASTE, SANITARY WASTE, LIQUID WASTE, OR OTHER TOXIC SUBSTANCES DISCOVERED OR GENERATED DURING CONSTRUCTION AND MEET ALL STATE AND FEDERAL REGULATIONS AND APPROVALS.
- 14. SIGNIFICANT AMOUNTS OF SEDIMENT, WHICH LEAVES THE SITE, MUST BE CLEANED UP WITHIN 24 HOURS AND PLACED BACK ON THE SITE AND STABILIZED OR PROPERLY DISPOSED. THE CAUSE OF THE SEDIMENT RELEASE MUST BE FOUND AND PREVENTED FROM CAUSING A RECURRENCE OF THE DISCHARGE WITHIN THE SAME 24 HOURS. ANY IN-STREAM CLEAN UP OF SEDIMENT SHALL BE PERFORMED ACCORDING TO THE OREGON DIVISION OF STATE LANDS REQUIRED TIME FRAME.
- 15. SEDIMENT MUST NOT BE INTENTIONALLY WASHED INTO STORM SEWERS, DRAINAGE WAYS, OR WATERBODIES. DRY SWEEPING MUST BE USED TO CLEAN UP RELEASED SEDIMENTS.
- 16. THE APPLICATION RATE OF FERTILIZERS USED TO RE-ESTABLISH VEGETATION MUST FOLLOW THE MANUFACTURER'S RECOMMENDATIONS. NUTRIENT RELEASES FROM FERTILIZERS TO SURFACE WATERS MUST BE MINIMIZED. TIME RELEASE FERTILIZERS SHOULD BE USED AND CARE SHOULD BE TAKEN IN THE APPLICATION OF FERTILIZERS WITHIN ANY WATERWAY RIPARIAN ZONE.
- 17. SEDIMENT MUST BE REMOVED FROM BEHIND A SEDIMENT FENCE WHEN IT HAS REACHED A HEIGHT OF 1/3 THE HEIGHT OF THE FENCE ABOVEGROUND AND BEFORE FENCE REMOVAL
- 18. SEDIMENT MUST BE REMOVED FROM BEHIND BIO BAGS AND OTHER BARRIERS WHEN IT HAS REACHED A HEIGHT OF TWO (2) INCHES AND BEFORE BMP REMOVAL.
- CLEANING OF TRAPPED CATCH BASINS MUST OCCUR WHEN THE SEDIMENT RETENTION CAPACITY HAS BEEN REDUCED BY FIFTY (50) PERCENT, AND AT THE COMPLETION OF A PROJECT.
- 20. REMOVAL OF TRAPPED SEDIMENT IN A SEDIMENT BASIN OR SEDIMENT TRAP OR CATCH BASINS MUST OCCUR WHEN THE SEDIMENT RETENTION CAPACITY HAS BEEN REDUCED BY FIFTY (50) PERCENT AND AT COMPLETION OF PROJECT.
- 21. DEQ MUST APPROVE OF ANY TREATMENT SYSTEM AND OPERATIONAL PLAN THAT MAY BE NECESSARY TO TREAT CONTAMINATED CONSTRUCTION DEWATERING OR SEDIMENT AND TURBIDITY IN STORMWATER RUNOFF.
- 22. SHOULD ALL CONSTRUCTION ACTIVITIES CEASE FOR THIRTY DAYS OR MORE, THE ENTIRE SITE MUST BE TEMPORARILY STABILIZED USING VEGETATION OR A HEAVY MULCH LAYER, TEMPORARY SEEDING, OR OTHER METHOD.
- 23. SHOULD CONSTRUCTION ACTIVITIES CEASE FOR FIFTEEN (15) DAYS OR MORE ON ANY SIGNIFICANT PORTION OF A CONSTRUCTION SITE TEMPORARY STABILIZATION IS REQUIRED FOR THAT PORTION OF THE SITE WITH STRAW, COMPOST, OR OTHER TACKIFIED COVERING THAT PREVENT SOIL OR WIND EROSION UNTIL WORK RESUMES ON THAT PORTION OF THE SITE.

### LOCAL AGENCY SPECIFIC EROSION CONTROL NOTES

- OWNER OR DESIGNATED PERSON SHALL BE RESPONSIBLE FOR PROPER INSTALLATION AND MAINTENANCE OF ALL EROSION AND SEDIMENT CONTROL MEASURES IN ACCORDANCE WITH THE LOCAL, STATE, AND FEDERAL REGULATIONS.
- 2. PRIOR TO ANY LAND DISTURBING ACTIVITIES, THE BOUNDARIES OF THE CLEARING LIMITS, VEGETATED BUFFERS, AND ANY SENSITIVE AREAS SHOWN 0 THIS PLAN SHALL BE CLEARLY DELINEATED LID IN THE FIELD. DURING THE CONSTRUCTION PERIOD, NO DISTURBANCE IS PERMITTED BEYOND THE CLEARING LIMITS. THE OWNER/PERMILIE MUST MAINTAIN THE DELINEATION FOR THE DURATION OF THE PROJECT. NOTE: VEGETATED CORRIDORS TO BE DELINEATED WITH ORANGE CONSTRUCTION FENCE OR APPROVED EQUAL.
- 3. PRIOR TO ANY LAND DISTURBING ACTIVITIES, THE BMPS THAT MUST BE INSTALLED ARE A GRAVEL CONSTRUCTION ENTRANCE, PERIMETER SEDIMENT CONTROL, AND INLET PROTECTION. THESE BMPS MUST BE MAINTAINED FOR THE DURATION OF THE
- IF VEGETATED SEED MIXES ARE SPECIFIED, SEEDING MUST TAKE PLACE NO LATER THAN SEPTEMBER 1; THE TYPE AND PERCENTAGES OF SEED IN THE MIX MUST BE IDENTIFIED ON THE PLANS.
- 5. THE ESC PLAN MUST BE KEPT ON SITE. ALL MEASURES SHOWN ON THE PLAN MUST BE INSTALLED PROPERLY TO ENSURE THAT SEDIMENT OR SEDIMENT LADEN WATER DOES NOT ENTER A SURFACE WATER SYSTEM, ROADWAY, OR OTHER PROPERTIES.

NOTES:

1. STAKING SPECIFICATIONS:

HIGHLY EROSIVE SOILS.

1"X2" WOODEN STAKES


ADDITIONAL STAKES MAY BE INSTALLED ON


WATTLES

DOWNHILL SIDE OF WATTLES, ON STEEP SLOPE OR

2. SPACING IN ACCORDANCE WITH DETAIL 940.


- 6. THE ESC MEASURES SHOWN ON THIS PLAN ARE MINIMUM REQUIREMENTS FOR ANTICIPATED SITE CONDITIONS. DURING THE CONSTRUCTION PERIOD, THESE MEASURES SHALL BE UPGRADED AS NEEDED TO COMPLY WITH ALL APPLICABLE LOCAL, STATE, AND FEDERAL EROSION CONTROL REGULATIONS.
- 7. ALL EXPOSED SOILS MUST BE COVERED DURING THE WET WEATHER PERIOD.

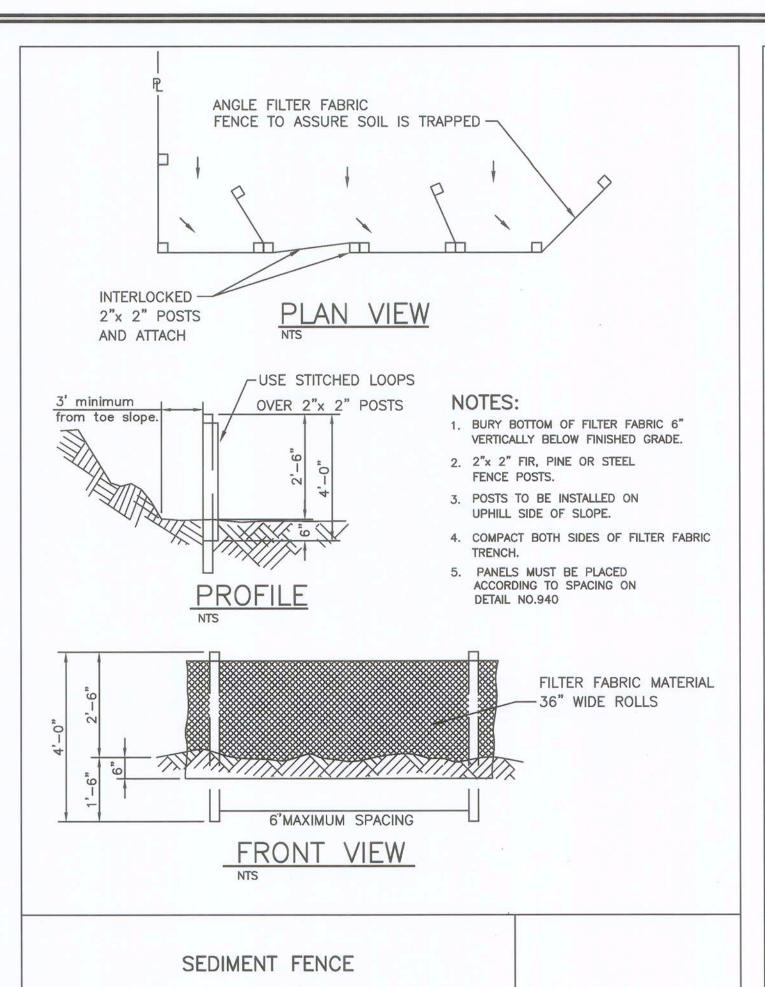

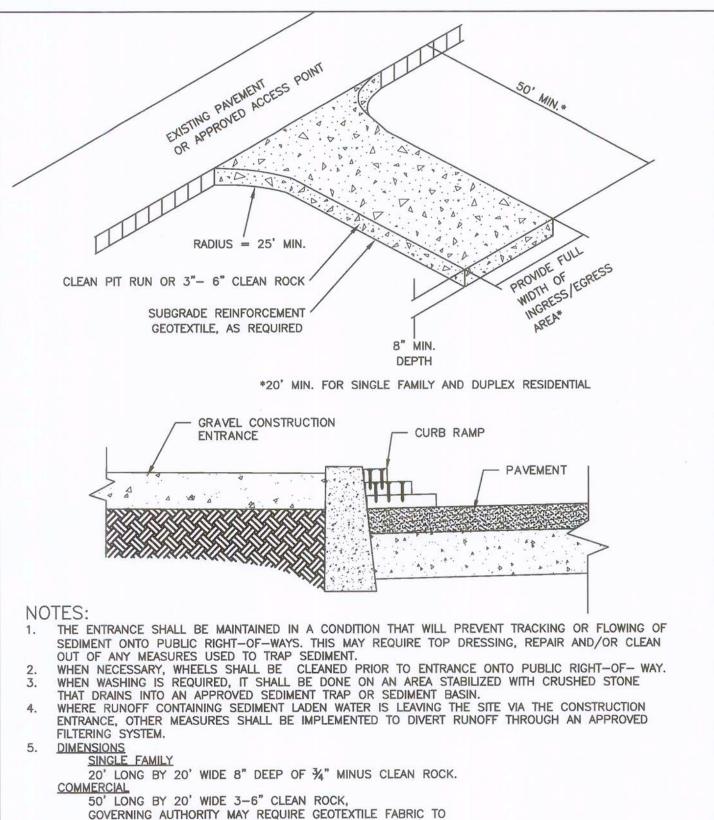

PREVENT SUB-SOIL PUMPING.

CONSTRUCTION ENTRANCE

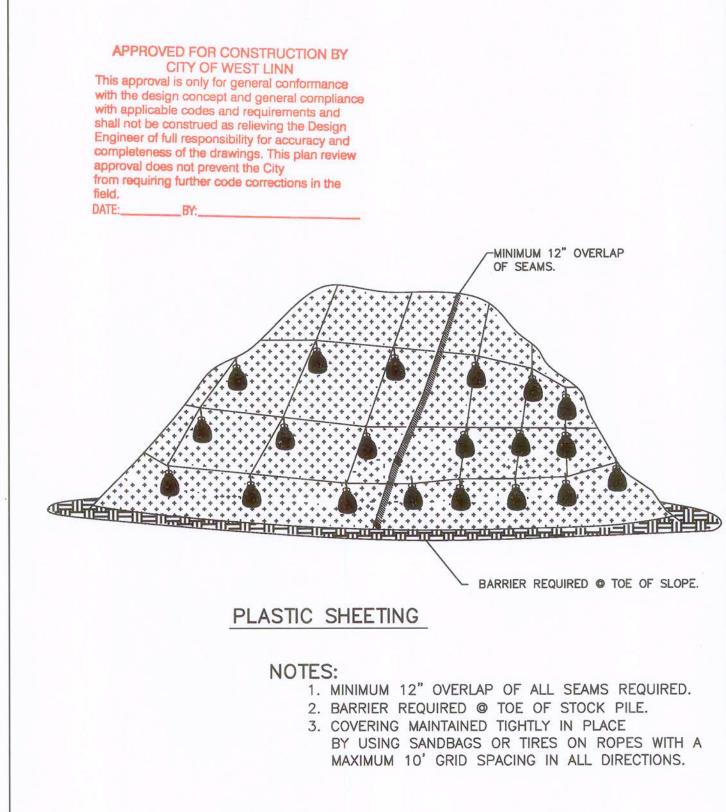

PLASTIC SHEETING

# PLACE WATTLES ALONG SLOPE CONTOURS. PROFILE RICE, COCONUT OR EXCELSIOR WATTLES STAGGER JOINTS SECTION STAKING SPACING 4' O.C. PLOW D D TIGHTLY ABUT ADJACENT WATTLES.

FOR FURTHER INFORMATION


ON DESIGN CRITERIA SEE


AND SEDIMENT CONTROL


CHAPTER 4 OF CLEAN WATER


SERVICES EROSION PREVENTION

PLANNING AND DESIGN MANUAL.

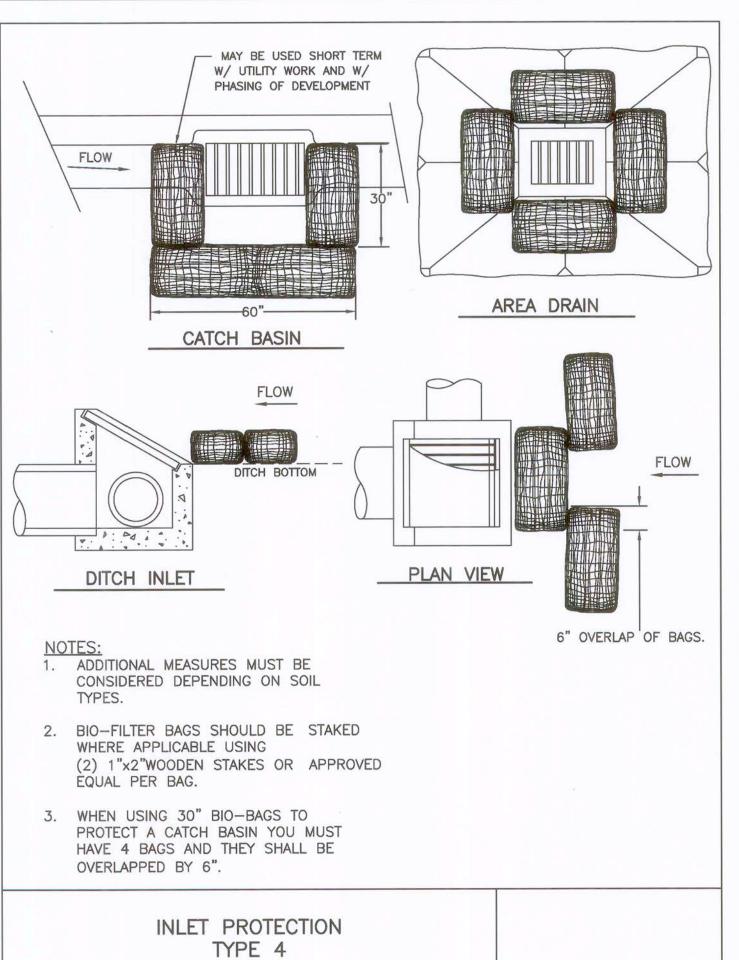


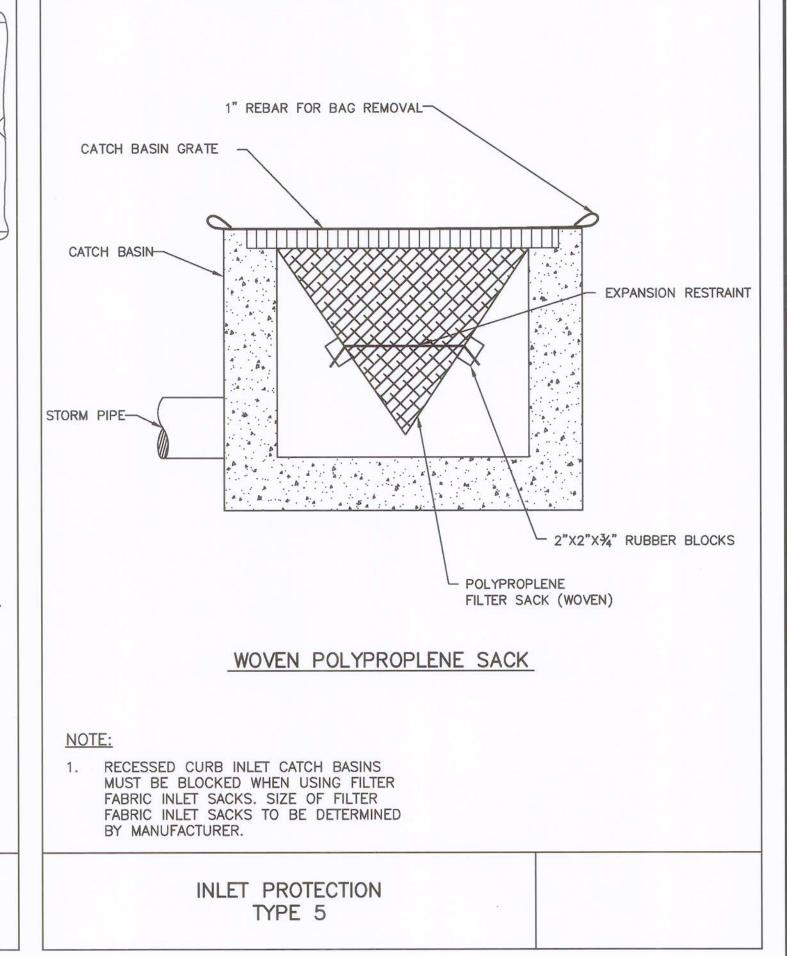

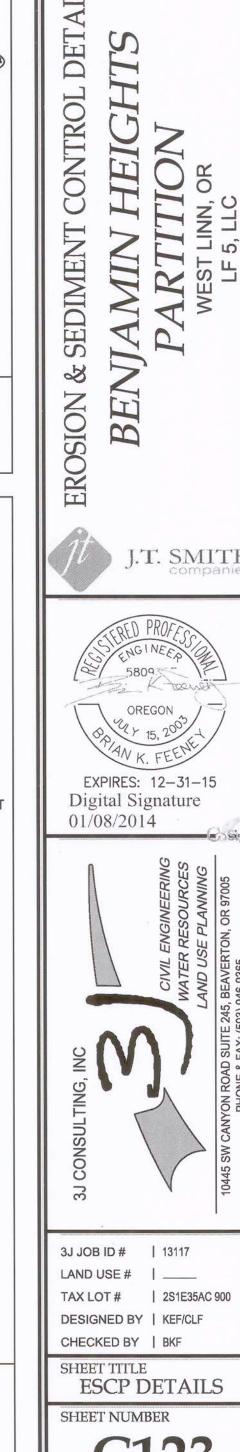

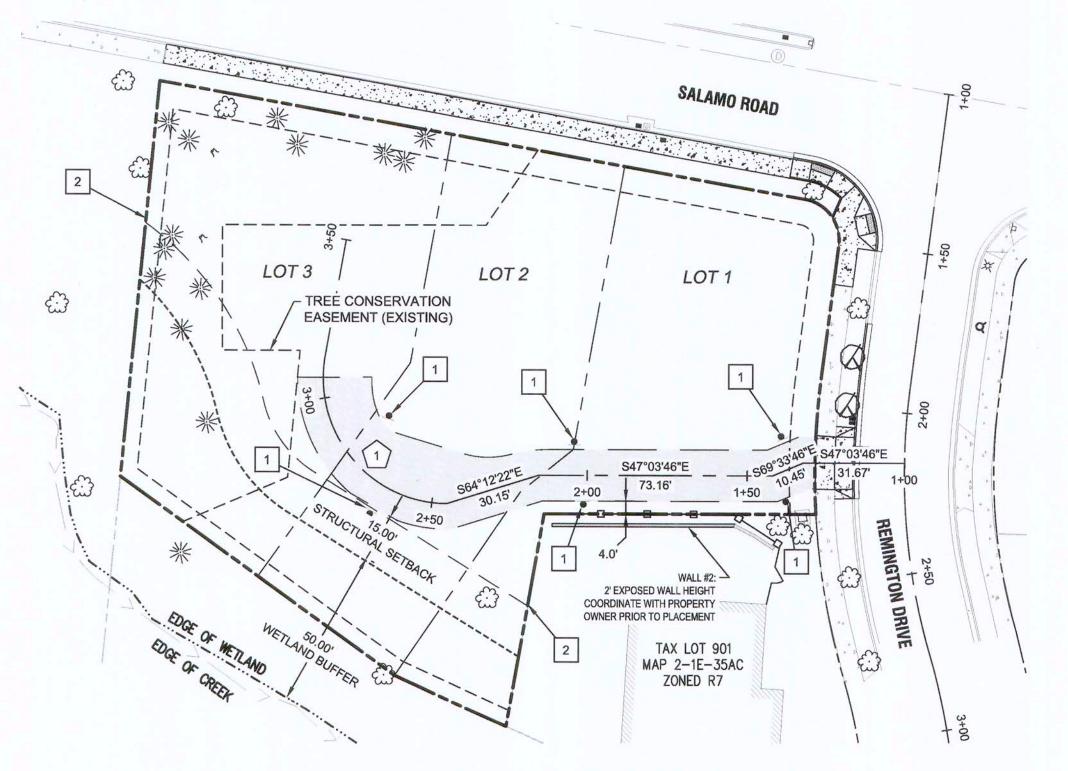


PRIVATE DRIVE - PLAN VIEW

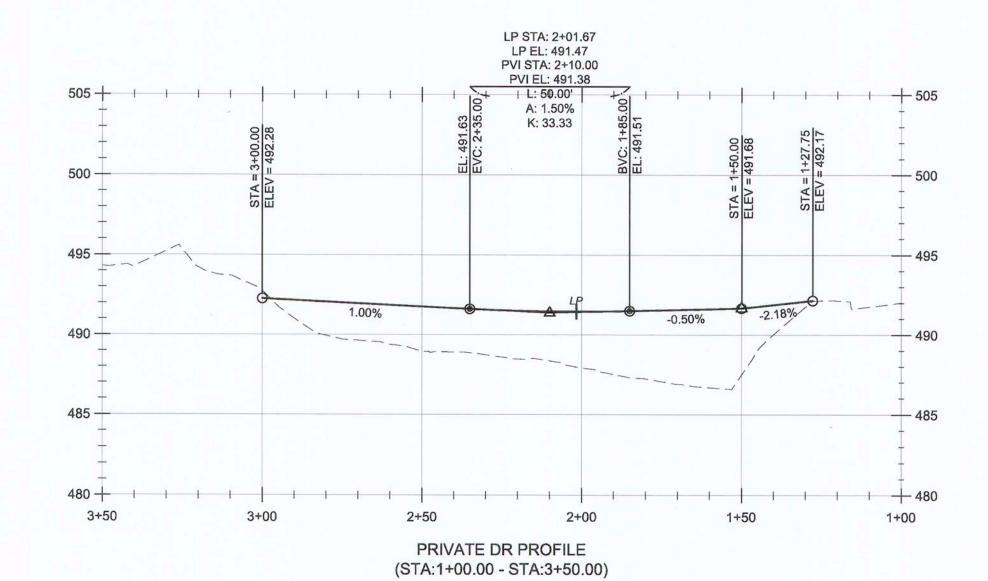

SCALE: HORIZ 1" = 30'

VERT 1" = 6'

### **LEGEND**

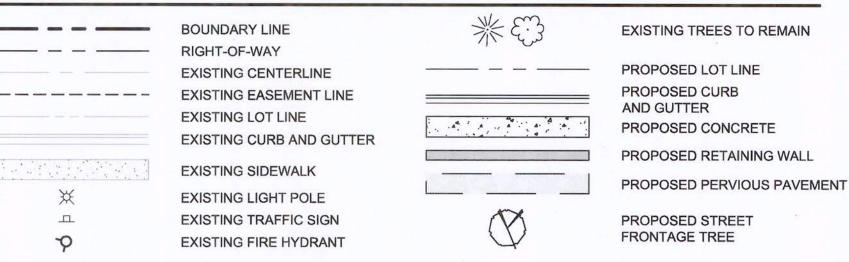

CENTERLINE CURVE TABLE				
TAG NO.	DELTA	RADIUS	TANGENT	LENGTH
1	89d45'0"	39'	38.80'	61.0'


### GENERAL SITE CONSTRUCTION NOTES

- 1 "NO PARKING" SIGN (SEE DETAIL ON SHEET C401). PARKING SHALL BE RESTRICTED ALONG BOTH SIDES OF THE PRIVATE DRIVE FROM REMINGTON DRIVE TO THE PROPERTY LINE SEPARATING LOTS 2 AND 3.
- THE EDGE OF THE CONSERVATION EASEMENT ON ALL SIDES SHALL BE MARKED WITH THE CITY'S STANDARD PERMANENT MARKERS AT 30-FOOT TO 50-FOOT INTERVALS AND AT ALL BOUNDARY DIRECTION CHANGES.

APPROVED FOR CONSTRUCTION BY
CITY OF WEST LINN
This approval is only for general conformance


This approval is only for general conformance with the design concept and general compliance with applicable codes and requirements and shall not be construed as relieving the Design Engineer of full responsibility for accuracy and completeness of the drawings. This plan review approval does not prevent the City from requiring further code corrections in the field.

DATE:\_\_\_\_\_BY:

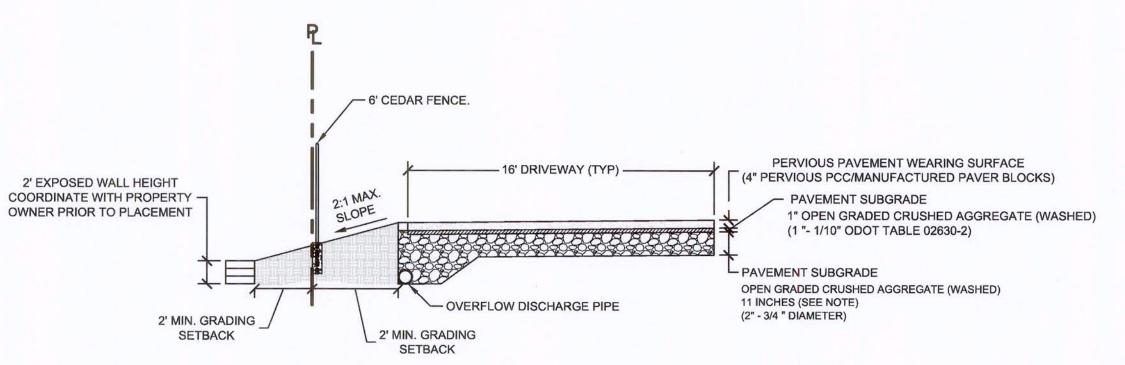

### COMMON DRIVEWAY IMPROVEMENTS

SCALE: N.T.

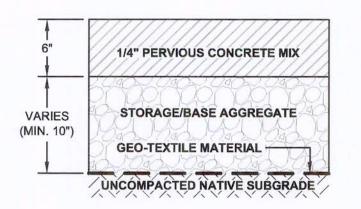

### PERVIOUS CONCRETE PAVING SECTION

### MATERIAL AND GENERAL PAVEMENT NOTES:

- 1. STORAGE/ BASE AGGREGATE SHOULD MEET OR EXCEED THE REQUIREMENTS AND SPECIFICATIONS OF O.S.S.C. 00641 (AGGREGATE SUBBASE, BASE, AND SHOULDERS) FOR OPEN GRADED AGGREGATE. THE GRADATION AND MATERIAL REQUIREMENTS SHOULD BE AS SPECIFIED IN O.S.S.C. 02630.11 (OPEN GRADED AGGREGATE). PRIOR TO COMMENCING CONCRETE WORK, CONTRACTOR SHALL SCHEDULE A PRE-PAVING CONFERENCE WITH THE ENGINEER, AND OWNER'S REPRESENTATIVE(S).
- 2. PERVIOUS CONCRETE SHOULD BE CONSTRUCTED IN ACCORDANCE WITH ACI-522 (PERVIOUS CONCRETE SPECIFICATIONS), CONTAIN BETWEEN 15% AND 19% AIR VOIDS, AND OBTAIN A STRENGTH OF 2,000PSI OR GREATER. REFER TO PROJECT SPECIFICATIONS FOR ADDITIONAL INFORMATION ON PERVIOUS CONCRETE MIXES, PERFORMANCE CRITERIA AND PLACEMENT REQUIREMENTS.
- 3. <u>SUB-GRADE GEOTEXTILE</u> SHOULD MEET OR EXCEED THE REQUIREMENTS AND SPECIFICATIONS OF O.S.S.C. 00350 (GEOSYNTHETIC INSTALLATION) AND 02320 (GEOSYNTHETICS) FOR TYPE II DRAINAGE FABRICS.




# REVISION SUMMARY

BENJAMIN HEIGHTS
PARTITION





EXPIRES: 12–31–15 Digital Signature 01/08/2014

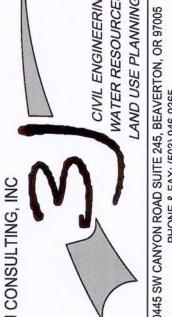


3J JOB ID # | 13117 LAND USE # | \_\_\_\_

TAX LOT # | 2S1E35AC 900

DESIGNED BY | KEF/CLF

CHECKED BY | BKF

SHEET TITLE DRIVEWAY PROF.

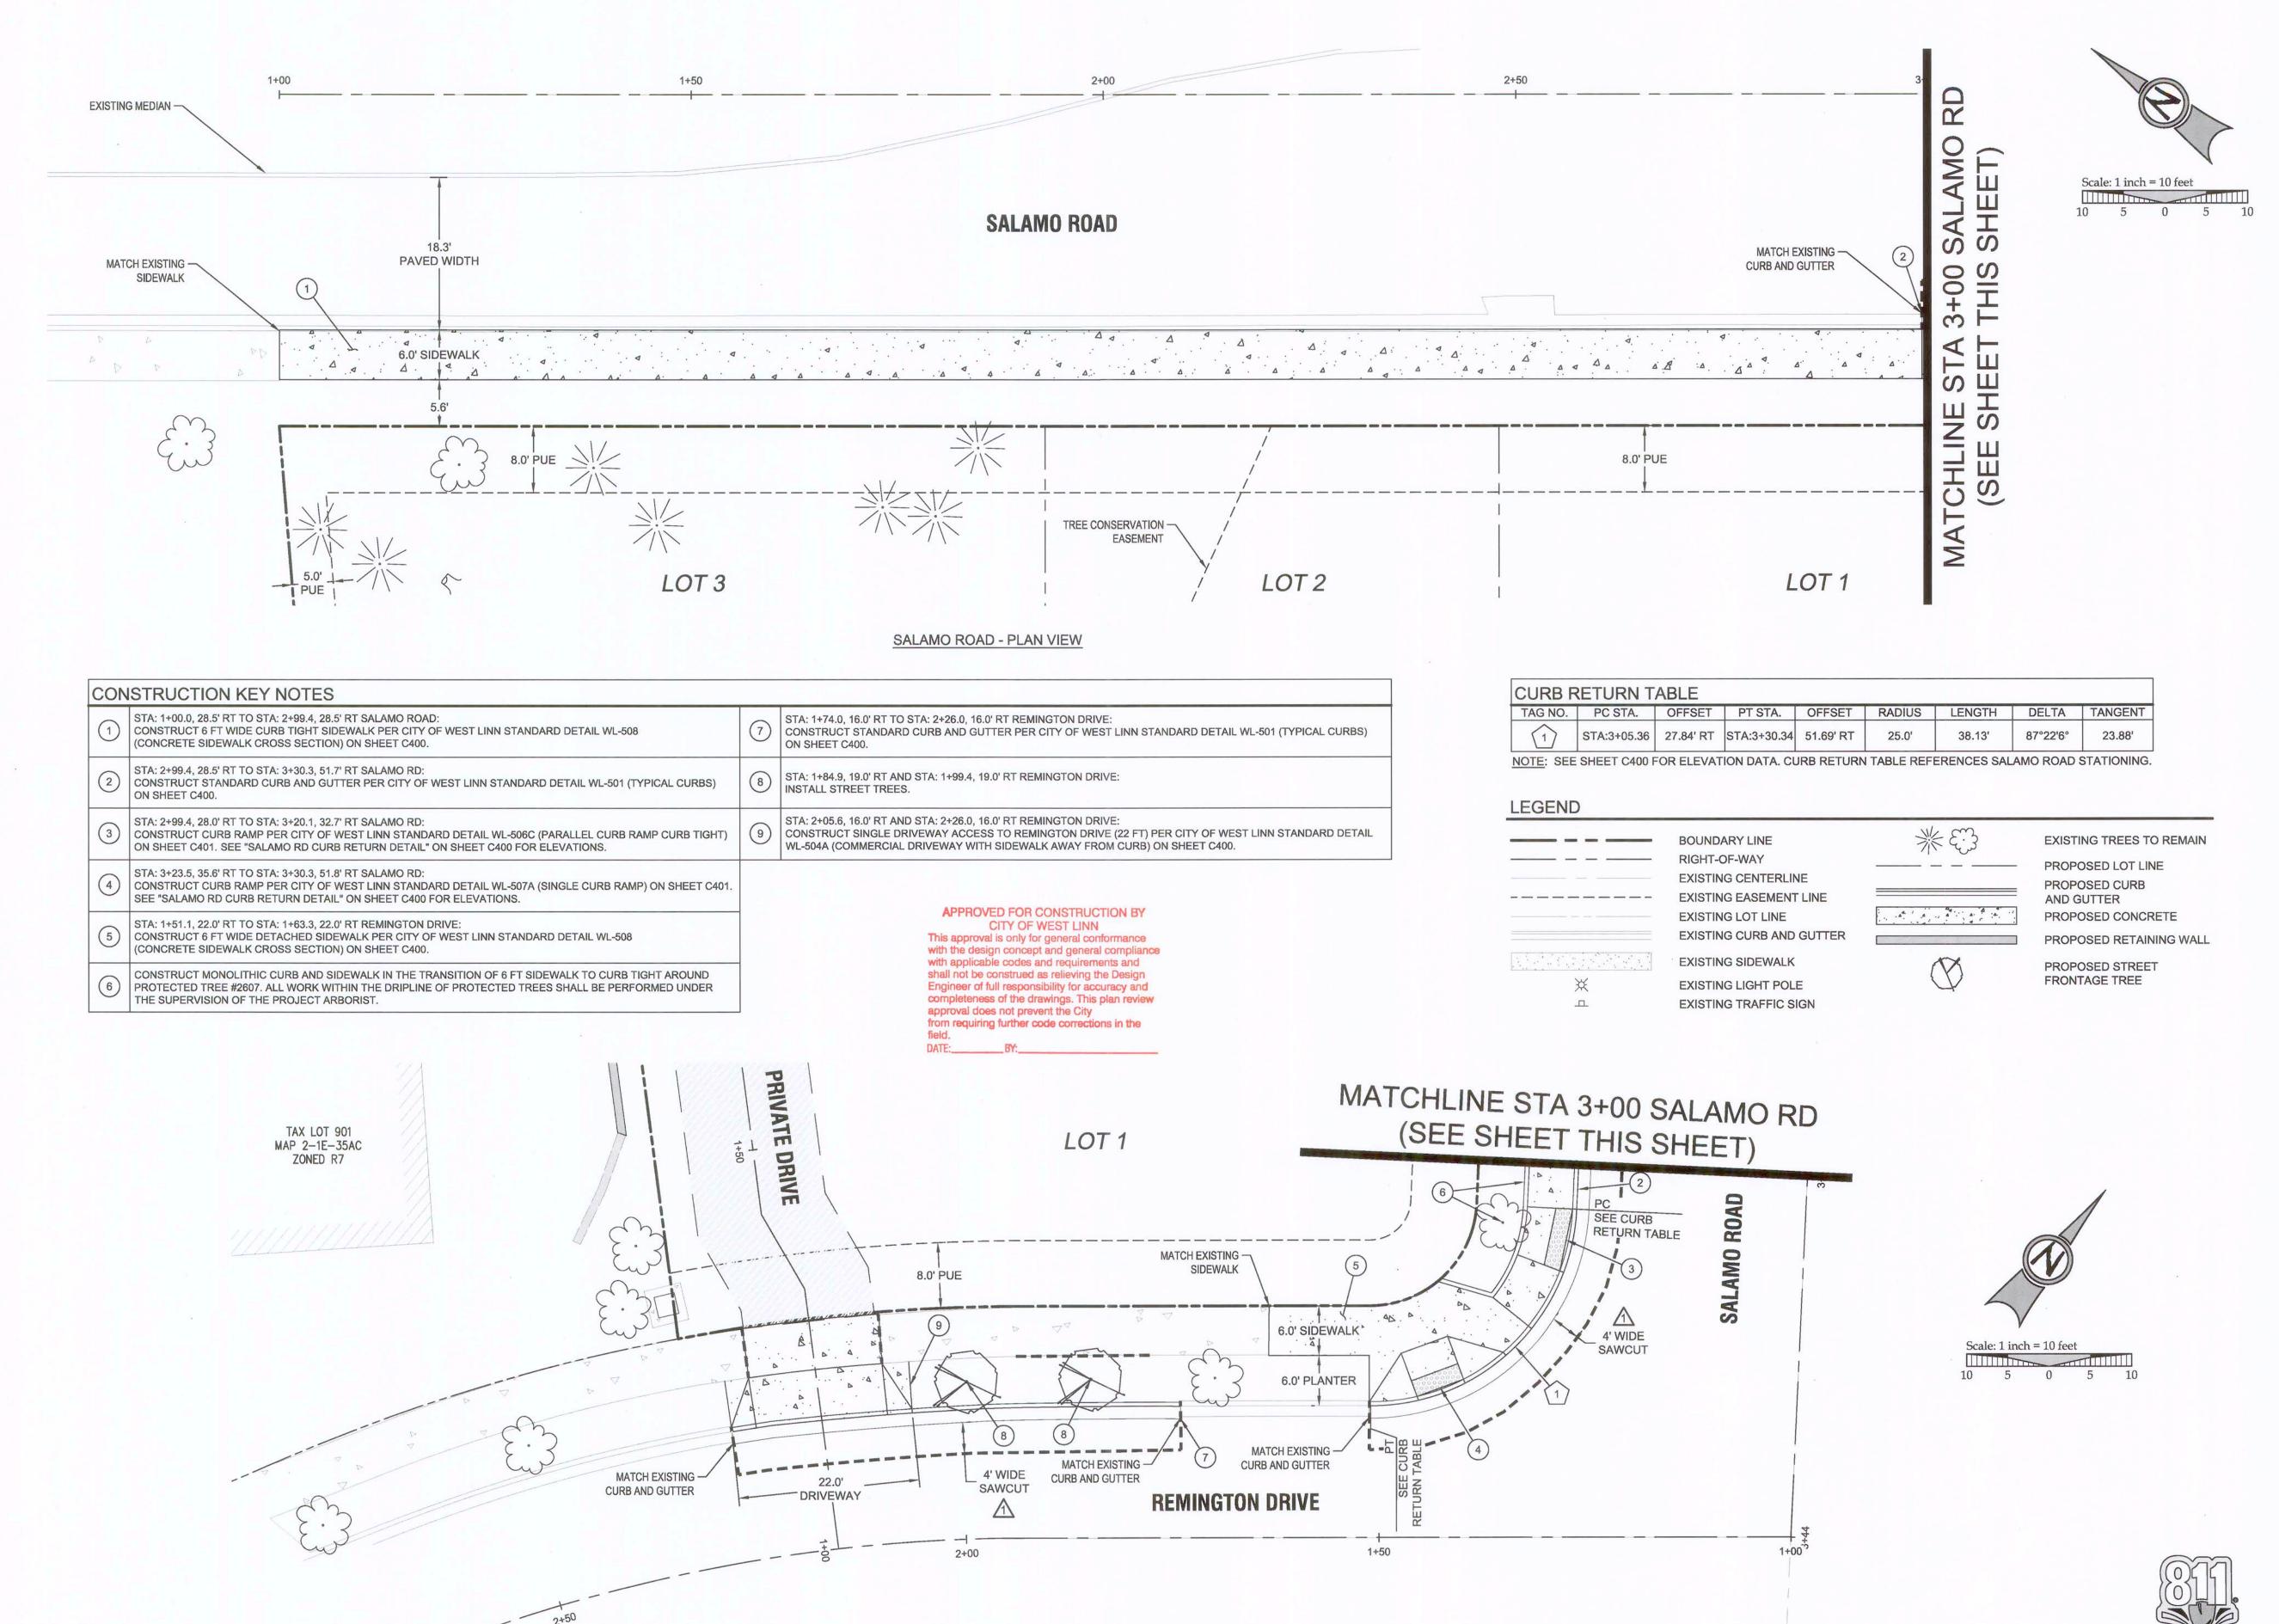

REMINGTON DRIVE - PLAN VIEW

PERMIT

REVISION SUMMARY

BY DAT

1st CITY REVIEW - REDLINE COMMENTS


MO RD & REMINGTON DR IMPROVEMENTS

BENJAMIN HEIGHTS

J.T. SMITH

OREGON
OREGON
EXPIRES: 12-31-15
Digital Signature

EXPIRES: 12–31–1
Digital Signature
01/08/2014

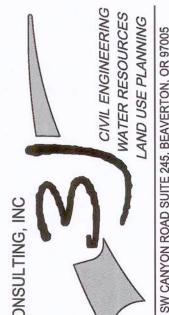

3J JOB ID # | 13117

LAND USE # | \_\_\_\_\_

TAX LOT # | 2S1E35AC 900

DESIGNED BY | KEF/CLF

CHECKED BY | BKF

CHECKED BY | BKF

SHEET TITLE


ROW IMPROV.'S

SHEET NUMBER

C202

Know what's below.

Call before you dig.

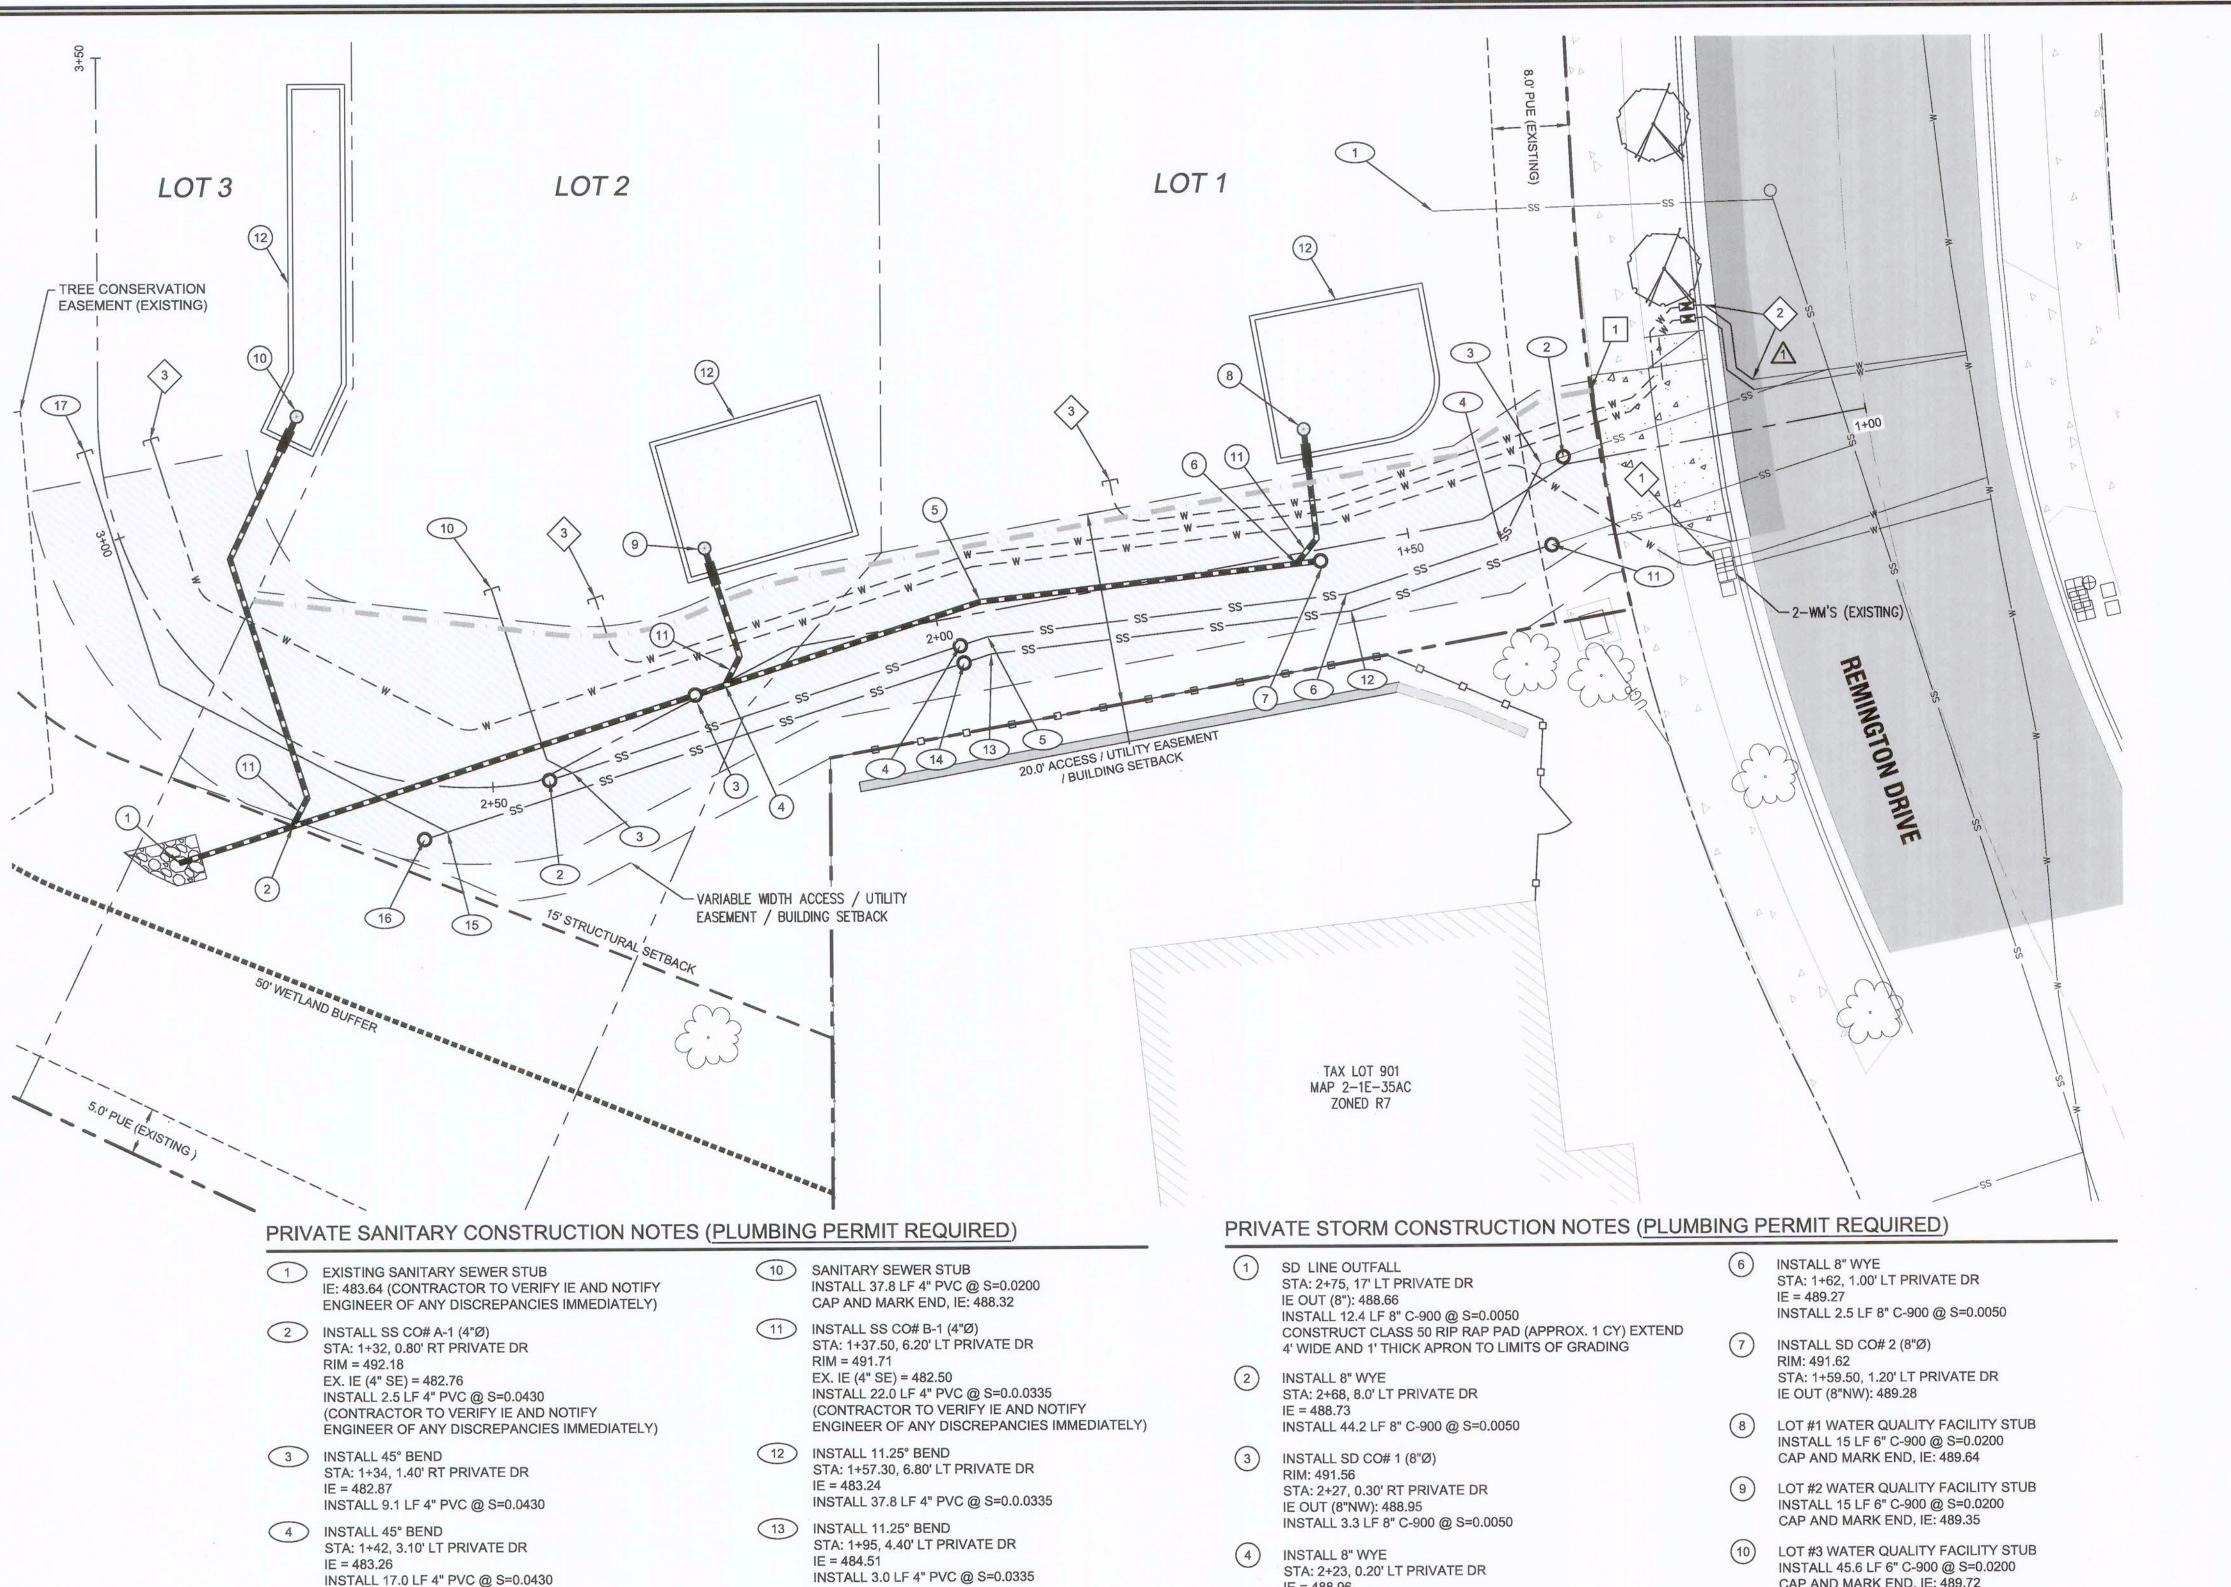

INSTALL SS CO# B-2 (4"Ø)

RIM = 491.42

**INSTALL 4" WYE** 

IE = 486.51

RIM = 491.79

IE (4" SE) = 486.59

IE (4" NW) = 484.61

STA: 1+98, 4.80' LT PRIVATE DR

INSTALL 56.7 LF 4" PVC @ S=0.0335

STA: 2+54.50, 4.70' LT PRIVATE DR

INSTALL 2.5 LF 4" PVC @ S=0.0335

STA: 2+56.50, 5.70' LT PRIVATE DR

INSTALL 59.0 LF 4" PVC @ S=0.0200

CAP AND MARK END, IE: 487.69

INSTALL SS CO# B-3 (4"Ø)

SANITARY SEWER STUB

**INSTALL 45° BEND** 

INSTALL 11.25° BEND

INSTALL SS CO# A-2 (4"Ø)

INSTALL SS CO# A-3 (4"Ø)

IE = 485.61

RIM = 491.44

IE (4" SE) = 485.73

**INSTALL 4" WYE** 

IE = 487.56

RIM = 491.72

IE (4" SE) = 487.67

STA: 1+57.50, 5.0' LT PRIVATE DR

INSTALL 37.7 LF 4" PVC @ S=0.0430

INSTALL 3.0 LF 4" PVC @ S=0.0430

INSTALL 42.6 LF 4" PVC @ S=0.0430

STA: 2+41.70, 0.90' LT PRIVATE DR

INSTALL 2.5 LF 4" PVC @ S=0.0430

STA: 2+44, 0.50' LT PRIVATE DR

STA: 1+95, 2.6' LT PRIVATE DR

STA: 1+98, 3.0' LT PRIVATE DR

STA: 2+23, 0.20' LT PRIVATE DR IE = 488.96INSTALL 28.0 LF 8" C-900 @ S=0.0050

INSTALL 11.25° BEND STA: 1+95, 1.10' RT PRIVATE DR IE = 489.10INSTALL 33.3 LF 8" C-900 @ S=0.0050

PRIVATE WATER SERVICE CONSTRUCTION NOTES (PLUMBING PERMIT REQUIRED)

CONNECT TO EXISTING WATER SERVICE. CONTRACTOR TO COORDINATE WITH CITY OF WEST LINN PUBLIC WORKS.

RELOCATE EXISTING WATER METERS OUT OF PROPOSED DRIVEWAY TO LOCATIONS SHOWN. INTERCEPT EXISTING SERVICE LINE AS REQUIRED. CONTRACTOR TO COORDINATE WITH CITY OF WEST LINN PUBLIC WORKS.

EXTEND 1" WATER SERVICE AS SHOWN.


### PRIVATE DRY UTILITY CONSTRUCTION NOTES

EXTEND PRIVATE UTILITIES WITHIN JOINT TRENCH ALIGNMENT SHOWN. CONTRACTOR TO COORDINATE WITH UTILITY PROVIDER TO OBTAIN DESIGN INFORMATION.

CAP AND MARK END, IE: 489.72

INSTALL 8"x6" REDUCER

WATER QUALITY PLANTERS TO BE CONSTRUCTED UNDER SEPARATE PERMIT AT THE TIME OF HOME CONSTRUCTION (SEE CONSTRUCTION DETAILS ON SHEET C401 FOR REFERENCE).

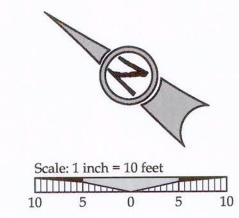

### LEGEND

RIGHT-OF-WAY **EXISTING CENTERLINE** EXISTING EASEMENT LINE EXISTING LOT LINE EXISTING CURB AND GUTTER EXISTING SANITARY SEWER LINE EXISTING WATER LINE EXISTING STORM LINE EXISTING GAS LINE EXISTING UNDERGROUND POWER **EXISTING ASPHALT** 

**BOUNDARY LINE** 

EXISTING SIDEWALK EXISTING LIGHT POLE EXISTING TRAFFIC SIGN EXISTING FIRE HYDRANT

> EXISTING WATER METER EXISTING SANITARY MANHOLE EXISTING STORM MANHOLE EXISTING CATCHBASIN

> > **EXISTING TREES TO REMAIN** PROPOSED LOT LINE PROPOSED CURB AND GUTTER

PROPOSED STORM LINE PROPOSED SANITARY LINE PROPOSED WATER LINE PROPOSED CLEAN-OUT

PROPOSED ASPHALT PROPOSED PERVIOUS CONCRETE

PROPOSED CONCRETE

PROPOSED RAIN GARDEN

PROPOSED JOINT UTILITY TRENCH PROPOSED RETAINING WALL

PROPOSED STREET FRONTAGE TREE

**GENERAL UTILITY NOTES** 


1. WATER QUALITY TREATMENT AND STORM WATER QUANTITY ATTENUATION FOR FUTURE HOMES TO BE HANDLED INDIVIDUALLY ON A PER LOT BASIS. 2. ALL OVERHEAD UTILITIES TO BE ROUTED UNDERGROUND ALONG PROJECT

FRONTAGE. CONTRACTOR TO COORDINATE WITH APPROPRIATE PURVEYORS.

3. SEE STD. DWG. WL-206 ON SHEET C400 FOR CLEANOUT DETAIL. ALL STORM PIPE TO BE C-900.

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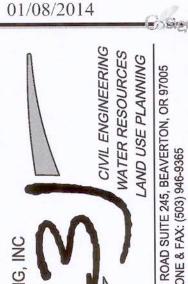


COMPOSITE

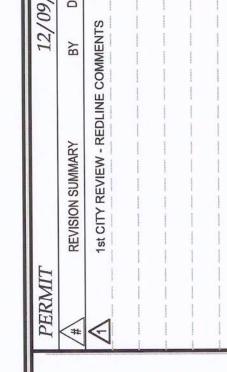





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3J JOB ID# | 13117 LAND USE # | \_\_\_\_\_ TAX LOT # | 2S1E35AC 900 DESIGNED BY | KEF/CLF

CHECKED BY | BKF SHEET TITLE **UTILTIY PLAN** 




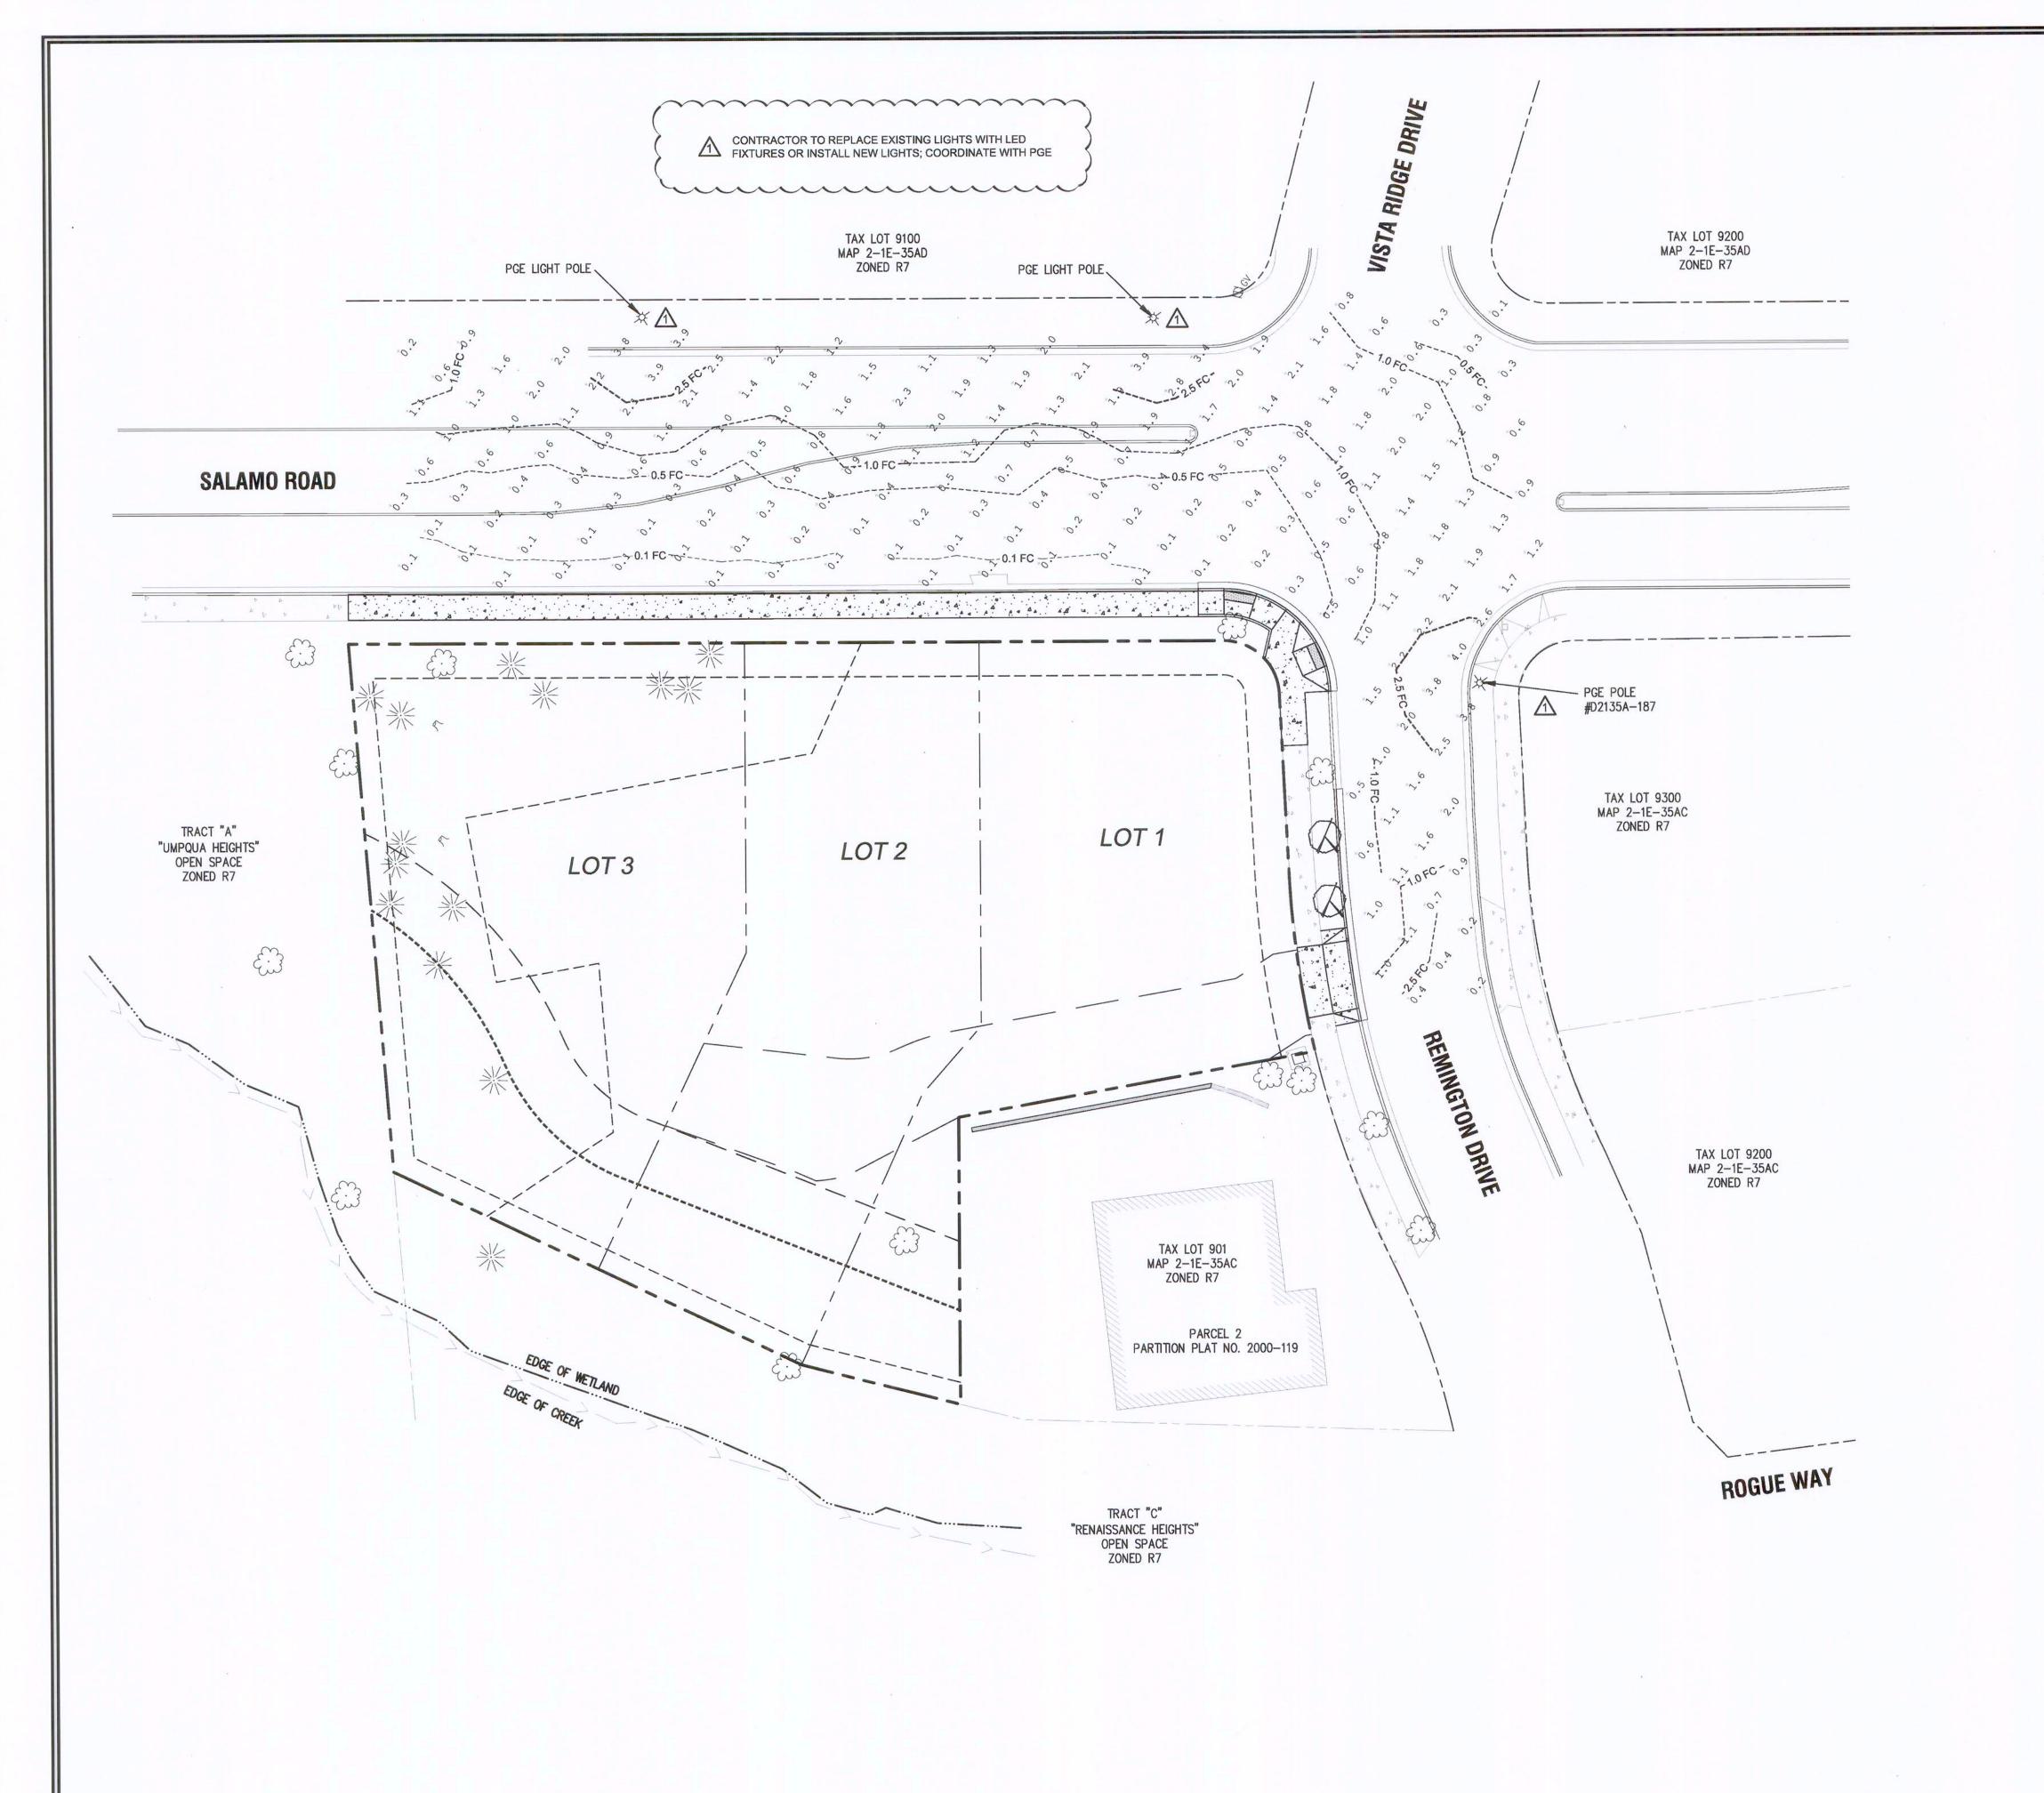

**LEGEND** 

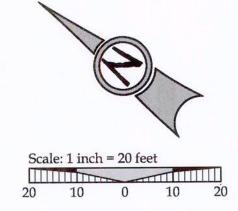- SUBDIVISION BOUNDARY LINE
- EXISTING RIGHT OF WAY
- EXISTING PROPERTY LINE
- PROPOSED LOT LINE

†0.7 - ILLUMINATION ANALYSIS POINT (FC)
FC - FOOT CANDLE UNIT

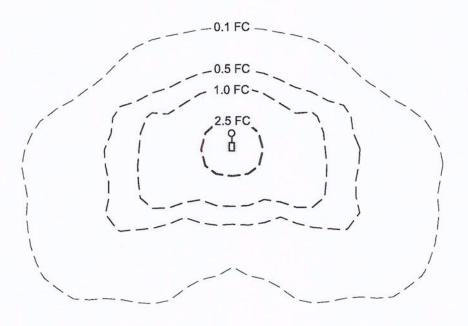

### EXISTING STREET LIGHTING STATISTICS

-	ROAD CLASSIFICATION (SALAMO)	MINOR ARTERIAL
	ROAD CLASSIFICATION (REMINGTON)	LOCAL
	EXISTING LIGHT(S) INCLUDED	3
	MAX. ILLUMINATION	4.0FC
	MIN. ILLUMINATION	0.1FC
	AVERAGE ILLUMINATION	1.06FC
	UNIFORMITY (AVG/MIN)	10.6

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PERMIT

REVISION SUMMARY

BY DAT

1st CITY REVIEW - REDLINE COMMENTS

EIGHTS
N

STREET LIGHTING


BENJAMIN HEI

PARTITION

WEST LINN, OR





EXPIRES: 12–31–15 Digital Signature 01/08/2014

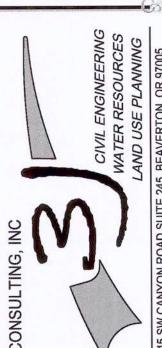


3J JOB ID # | 13117 LAND USE # | \_\_\_\_\_ TAX LOT # | 2S1E35AC 900 DESIGNED BY | KEF/CLF CHECKED BY | BKF


SHEET TITLE
LIGHTING PLAN
SHEET NUMBER

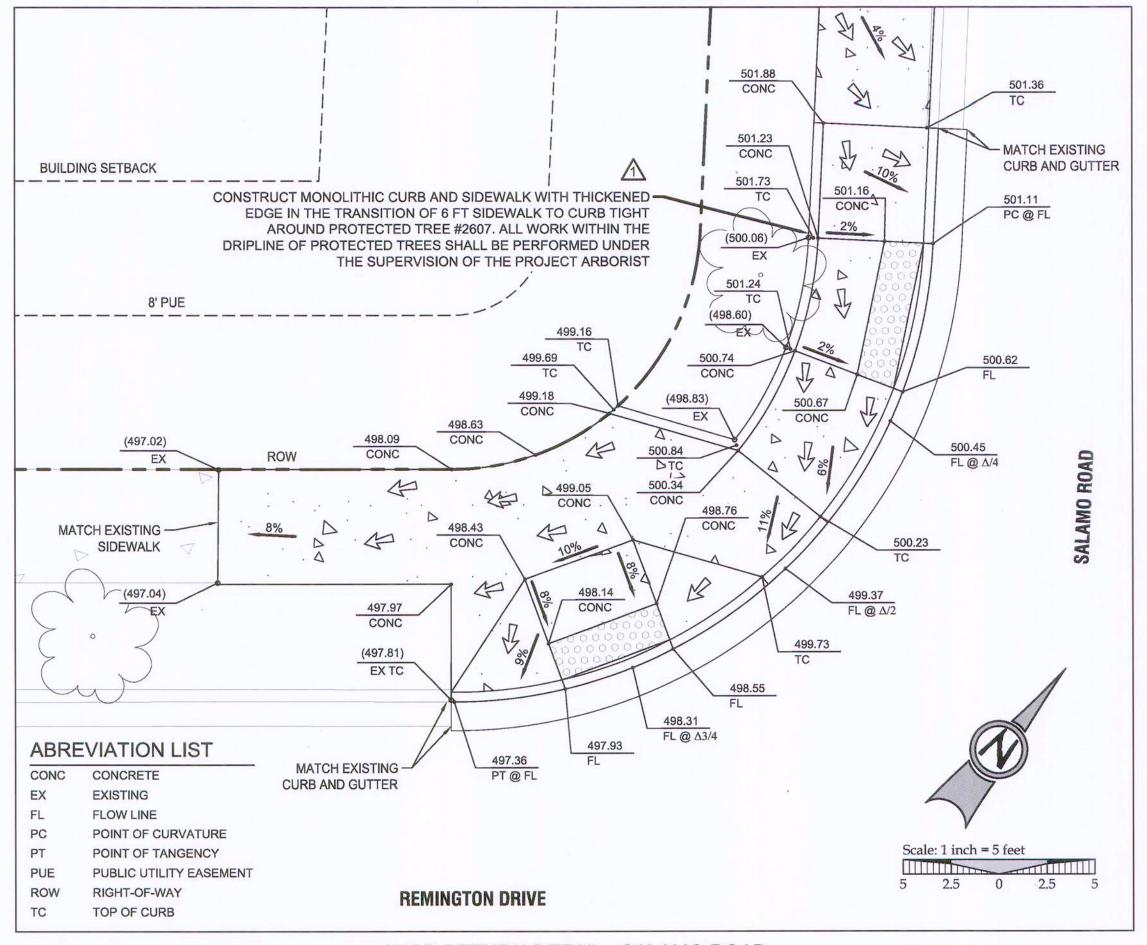

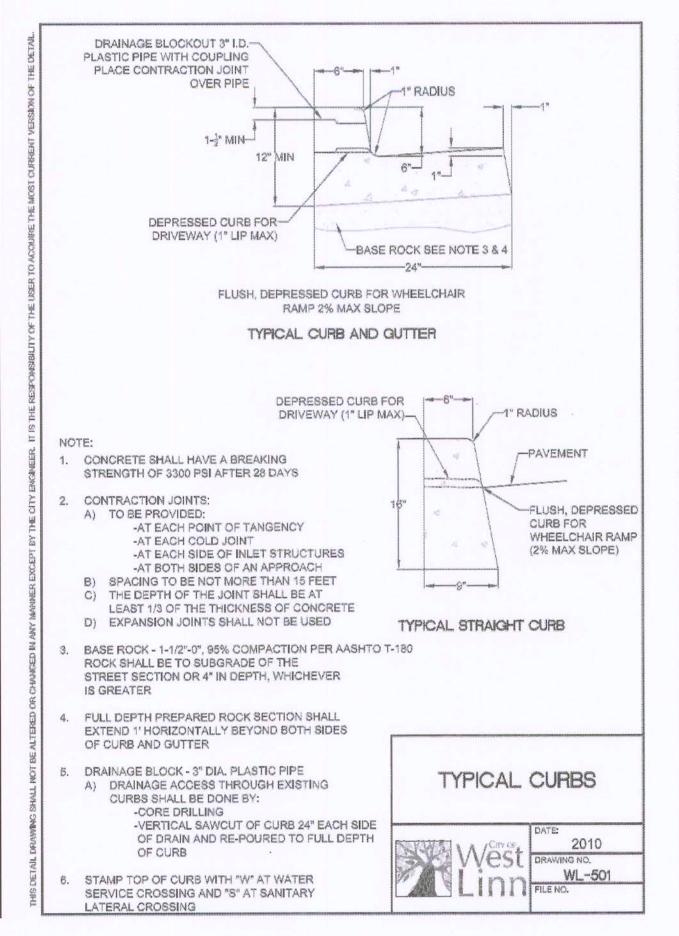

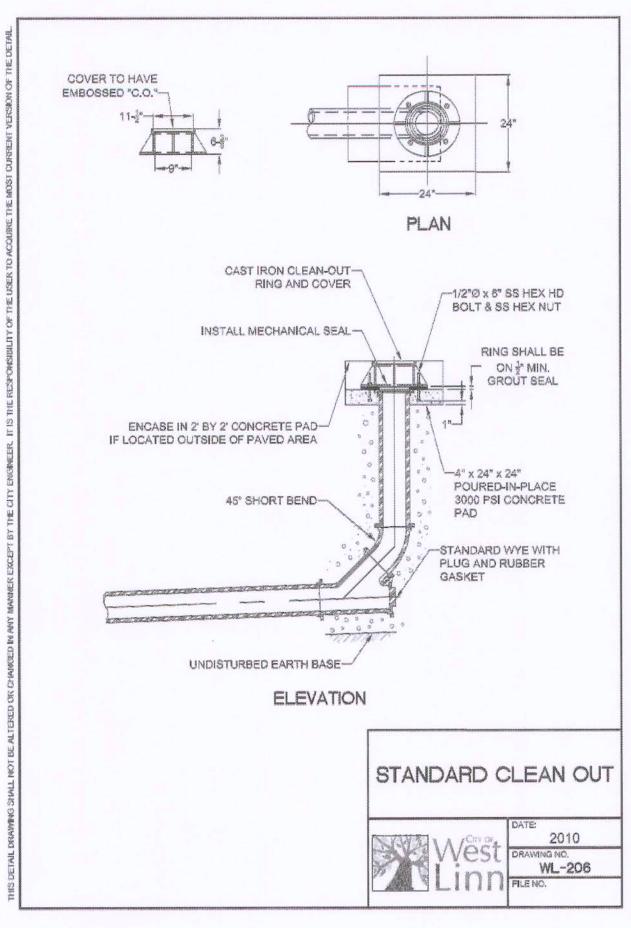





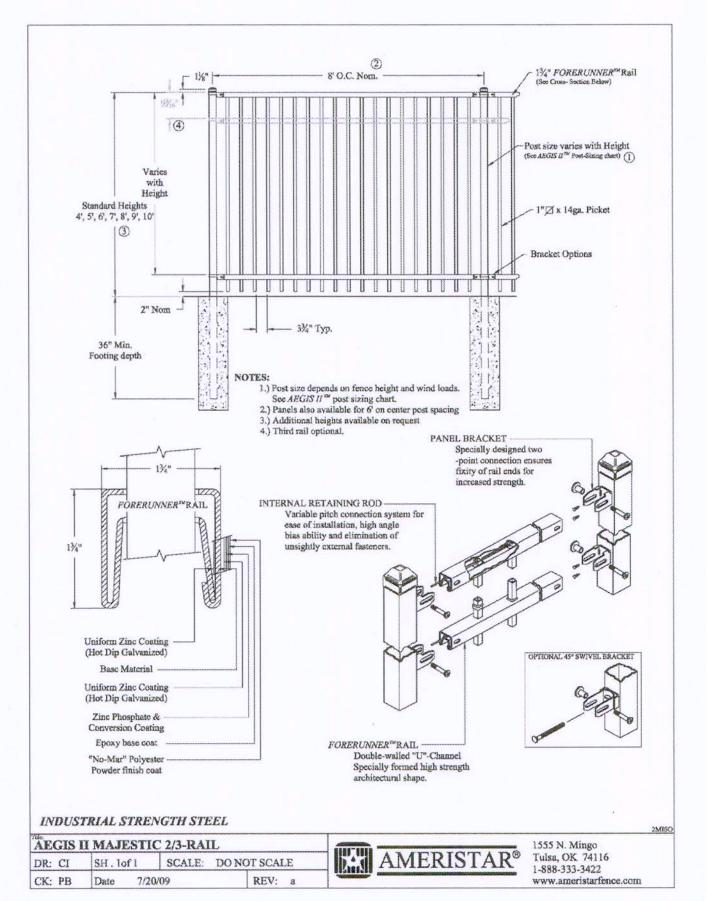






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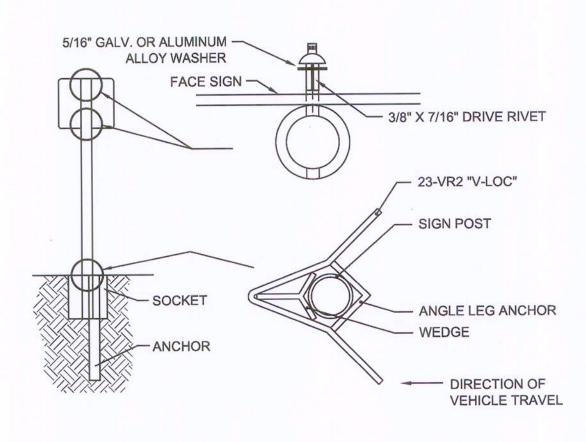


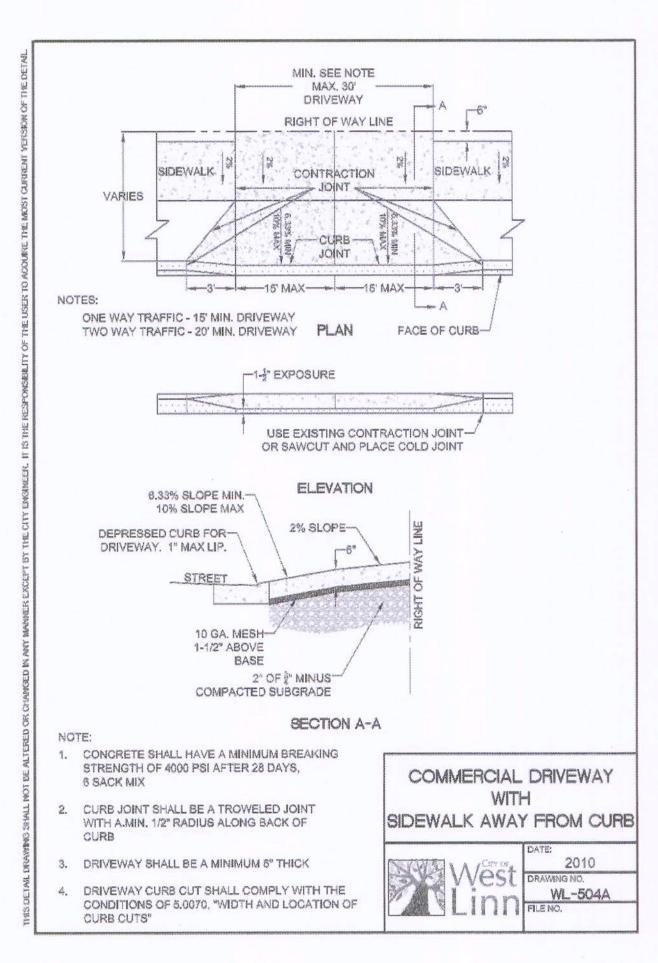

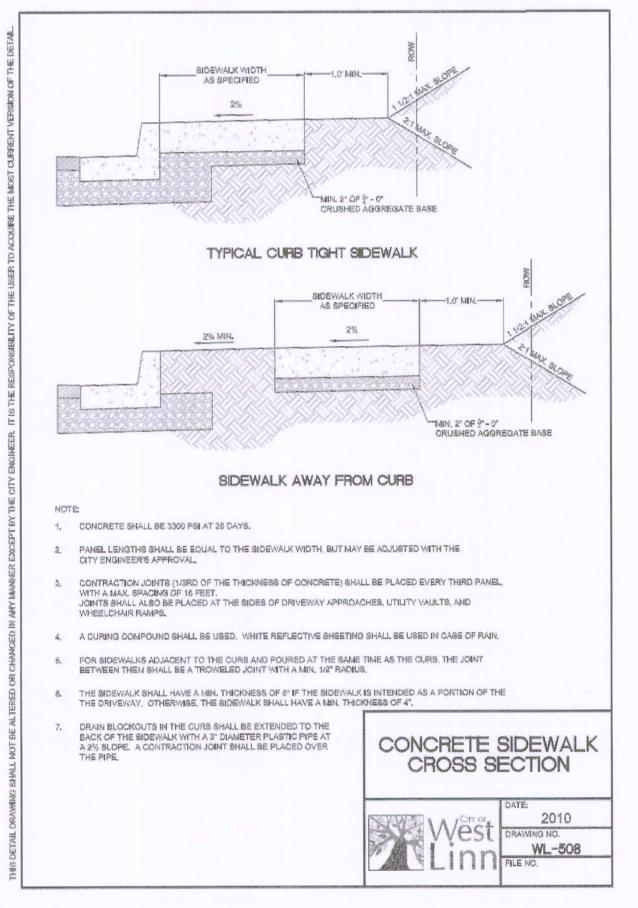CONSTRUCTION

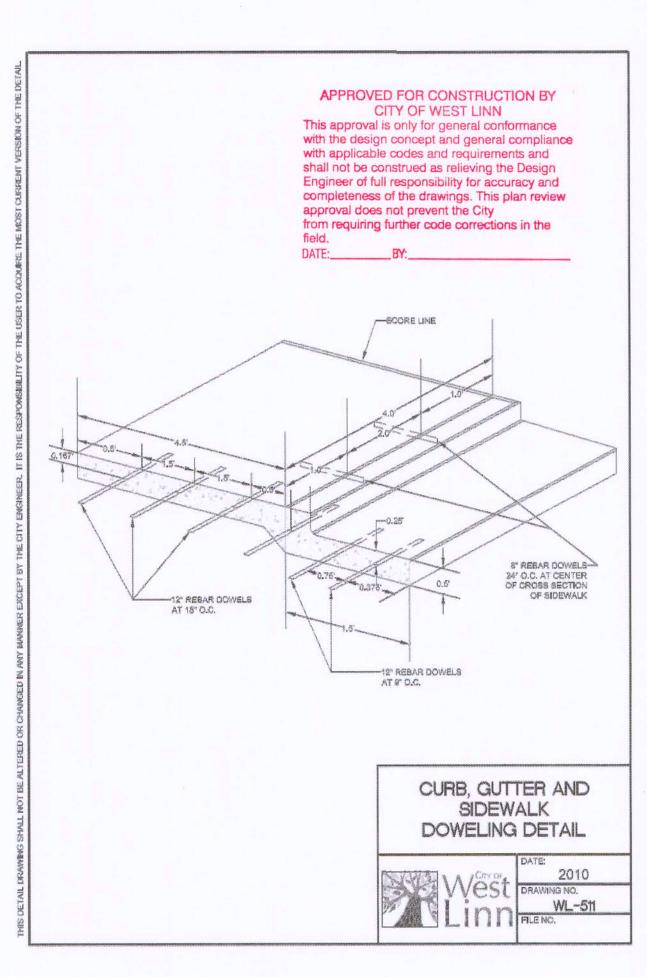

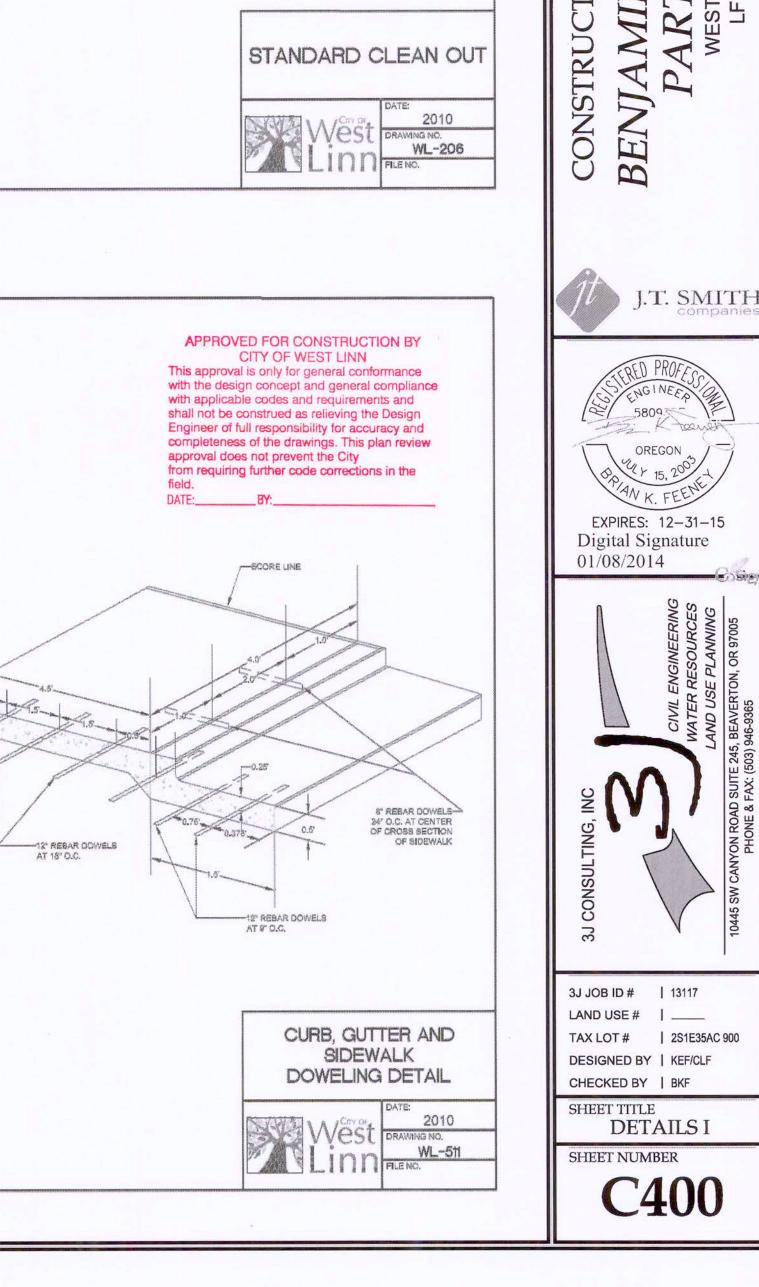
12 X 18

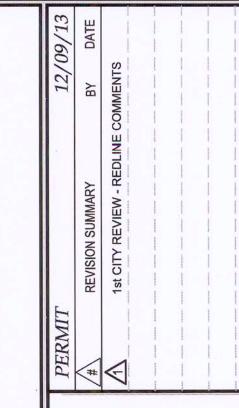



INSTALL "V-LOC" ANCHOR PER MANUFACTURES RECOMMENDATION

### "NO PARKING" SIGN AND TYPICAL INSTALLATION DETAIL

NOT TO SCALE

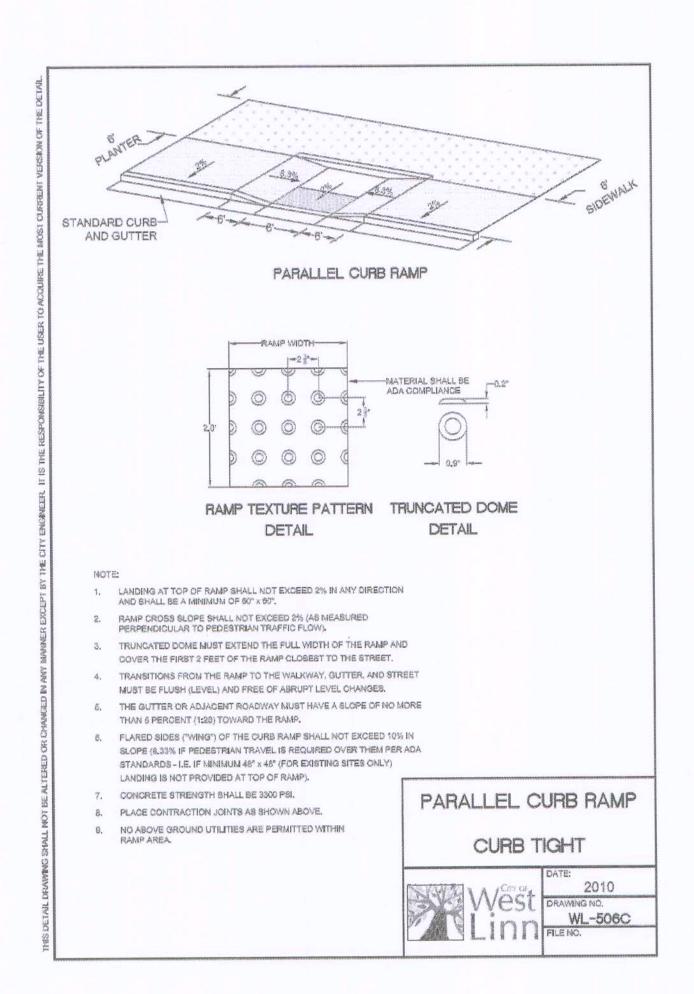

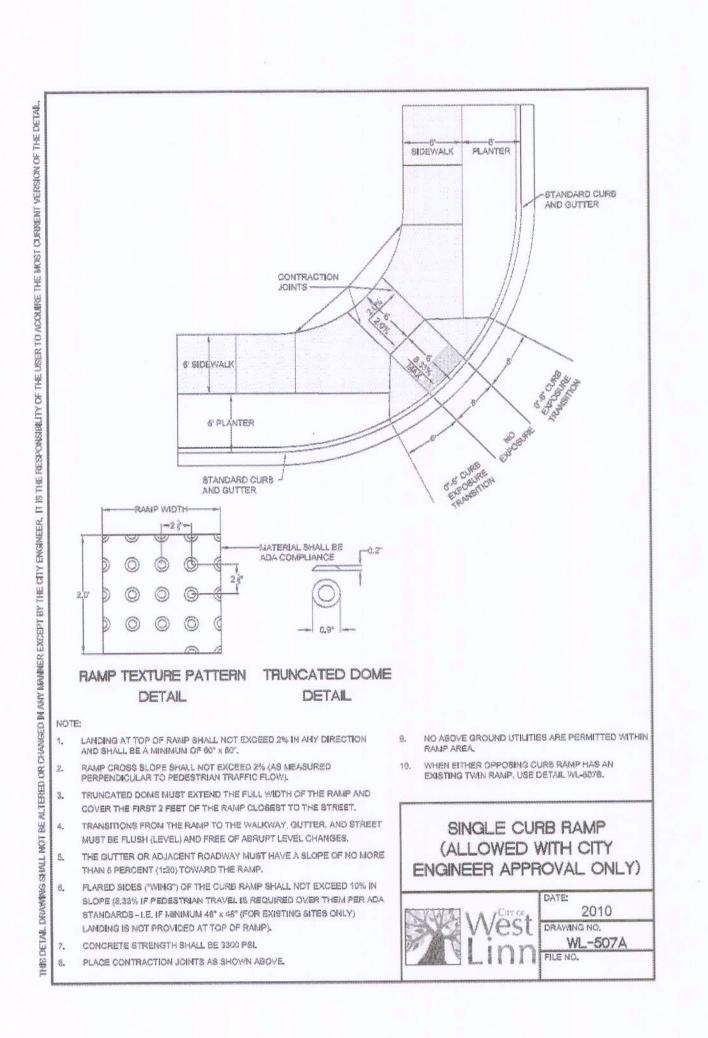

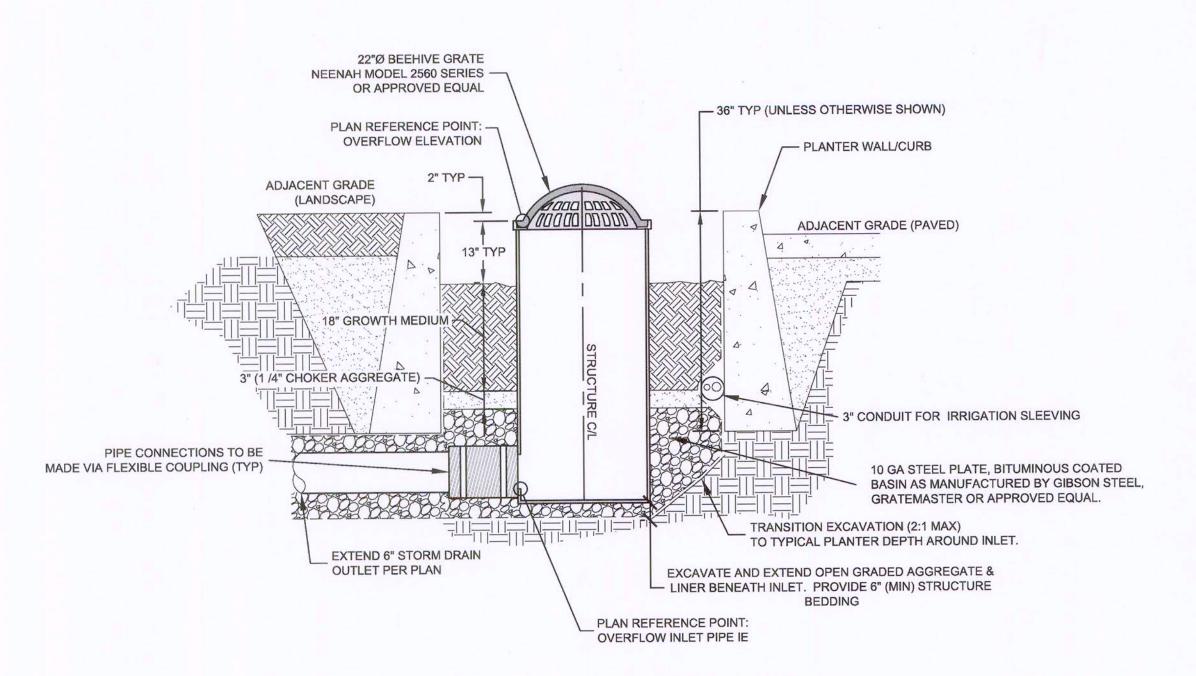


NOT TO SCALE

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THE NATIVE SOIL IN THE TOP 18 INCHES OF ALL STORM WATER PLANTERS SHALL SE AMENDED WITH A MIX OF ONE PART IMPORTED DRIGANIC COMPOST AND ONE PART GRAVELLY SAND, SUCH THAT THERE ARE EQUAL PARTS COMPOST, SAND AND NATIVE SOIL. THIS WILL REQUIRE THE STORMWATER PLANTER AREA TO BE OVER EXCAVATED BY APPROXIMATELY 12 INCHES PRIOR TO ADDING SAND AND COMPOST, THE SPECIFICATIONS INCLUDED HERRIN SHALL BE USED FOR THIS PURPOSE AND INCLUDED ON THE PERMIT PLANS. THE MIX SHALL BE THOROUGHLY TILLED TOGETHER ON-SITE, AND SHALL BE CAPABLE OF INFILTRATING WATER WITHOUT PROLONGED PONDING ON THE SURFACE. IF SUCH PONDING DOCURS, ORGANIC DOMPOST AND SAND MUST BE ADDED AND RE-TILLED UNTIL INFILTRATION PERFORMANCE IS ENHANCED. A 2-INCH LAYER OF SHREDDED BARK MULCH (NOT BARK DUST OR BARK CHIPS) SHALL SE USED OVER THE AMENDED SOIL AND SETWEEN THE PLANTINGS TO COMPLETELY COVER THE SOIL AND PREVENT BROSION OR WEED INTRUSION. ORGANIC COMPOST SHALL HAVE THE FOLLOWING PROPERTIES: 100% SHALL PASS A INCH SCREEN. PH SETWEEN 5.5 AND 7.0. CARBON NITROGEN RATIO SETWEEN 20:1 AND 35:1 (35:1 CN RATIO RECOMMENDED FOR NATIVE PLANTS.) ORGANIC MATTER CONTENT BETWEEN 46 AND 50 PERCENT. ORGANIC COMPOST MAY CONSIST OF THE FOLLOWING: MUSHROOM COMPOST - THE USED BEDDING MATERIAL FROM COMMERCIAL MUSHROOM PRODUCTION. COMPOSTED YARD DEBRIS - COMMERCIALLY MANUFACTURED MATERIAL, MADE FROM DEAD PLANT MATERIAL SUCH AS GRASS CLIPPINGS, WEEDS, GREEN AND DEAD DRY LEAVES, GARDEN AND VEGETABLE MATERIAL, AND GROUND BRANCHES OF TREES AND SHRUBS. FURNISH A PRODUCT THAT IS COMPOSTED UNDER CONTROLLED AEROBIC DECOMPOSITION, WITH THE INTERNAL TEMPERATURE REACHING 57°C (135°F) FOR 15 DAYS, WITHOUT EXCEEDING 68°C (155°F). ENSURE THAT IT CONTAINS A MAXIMUM PEAT MOSS - HORTICULTURAL GRADE, NATURAL PEAT HOSS IN AIR-DRY CONDITION, FREE FROM WOODY SUBSTANCES, IN BALES OR BAGS LABELED FOR CONTENT AND VOLUME. ONLY PEAT MOSS USED IN COMBINATION WITH ONE OF THE ABOVE COMPOSTS IS ACCEPTABLE. GRAVELLY SAND SHALL BE FREE OF ORGANIC MATERIAL, CONTAMINANTS, AND HAZARDOUS MATERIALS, AND SHALL CONFORM TO THE PERCENT PASSING U.S. SIEVE SIZE MIX COMPOST, SAND AND NATIVE SOIL TO A HONOGENEOUS CONSISTENCY. DO NOT MIX COMPOST, SAND, AND NATIVE SOIL IN THE STORE STOCK PILES OF ORGANIC SOIL MIX IN A MANNER THAT PREVENTS IT FROM BECOMING WET FROM RAIN, STORM WATER RUNDED, OR OTHER SOURCES OF WATER, OR CONTAMINATED BY FINE BOIL OR OTHER UNDESIRABLE MATERIALS. ALL STOCKPILES OF MIXED SOIL MATERIAL SHALL SE PROTECTED AND COVERED. PLACE AMENDED SOIL MIX IN RAIN GARDENS AND STORMWATER PLANTERS IN LIFTS NOT EXCEEDING 6 INCHES IN LOOSE THICKNESS. AFTER ALL LIFTS HAVE BEEN PLACED, GRADE BOIL TO FINISH GRADES AS SPECIFIED ON THE PLANS. DO NOT OVER COMPACT SOIL MIX WITH MECHANICAL EQUIPMENT AFTER PLACEMENT. SHREDDED BARK MULCH (NOT BARK DUST OF BARK CHIPS) SHALL BE USED IN A 2-INCH LAYER MINIMUM OVER THE AMENDED SOIL MIX AND BETWEEN THE PLANTINGS TO COMPLETELY COVER THE SOIL AND PREVENT EROSION OR WEED INTRUSION. IMPLIFIATION TESTING
WET THE BURFACE OF THE RAIN GARDEN OR STORMWATER PLANTER WITH A SPRINKLER OR HOSE UNTIL SATURATED. SMALL RAIN
GARDENS AND PLANTERS (<100 SQUARE IN SURFACE) AREA CAN SE TESTED FULL-SCALE. WHILE LARGE RAIN GARDENS AND
PLANTERS CAN LITLIZE ISOLATED FALLING HEAD TEST (MINIMUM 2 PER 100 SQUARE FEET OF AREA). FILL THE TESTING AREA TO A
DEPTH OF 4-INCHES AND TRACK THE TIME IT TAKES TO COMPLETELY DRAW DOWN. REPEAT TEST 3 TIMES. IF THE WATER IN ANY OF THE TEST FAILS TO DRAW DOWN IN LESS THAN AN HOUR. ADD COMPOST AND GRAVELY SAND TO THE MIX AND RE-TILL. REPEAT THIS PROCEDURE UNTIL. SOIL AMENDMENT AND FAVORABLE TEST RESULTS ARE ACHIEVED. MULCH SPECIFICATION

MAINTENANCE AGREEMENT SHALL BE REQUIRED AND BE RECORDED WITH THE CI

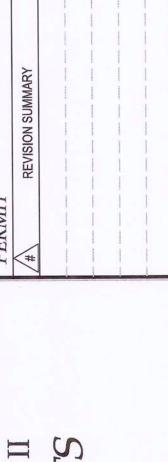

CONSTRUCTION DETAILS

BENJAMIN HEIGHT


PARTITION

WEST LINN OR





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3J JOB ID # | 13117 LAND USE # | \_\_\_\_ TAX LOT # | 2S1E35AC 900
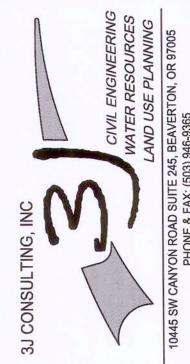
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CHECKED BY | BKF

SHEET TITLE
DETAILS II