



**Lake Oswego and Tigard Water Treatment Plant**  
FINAL - JANUARY 2012

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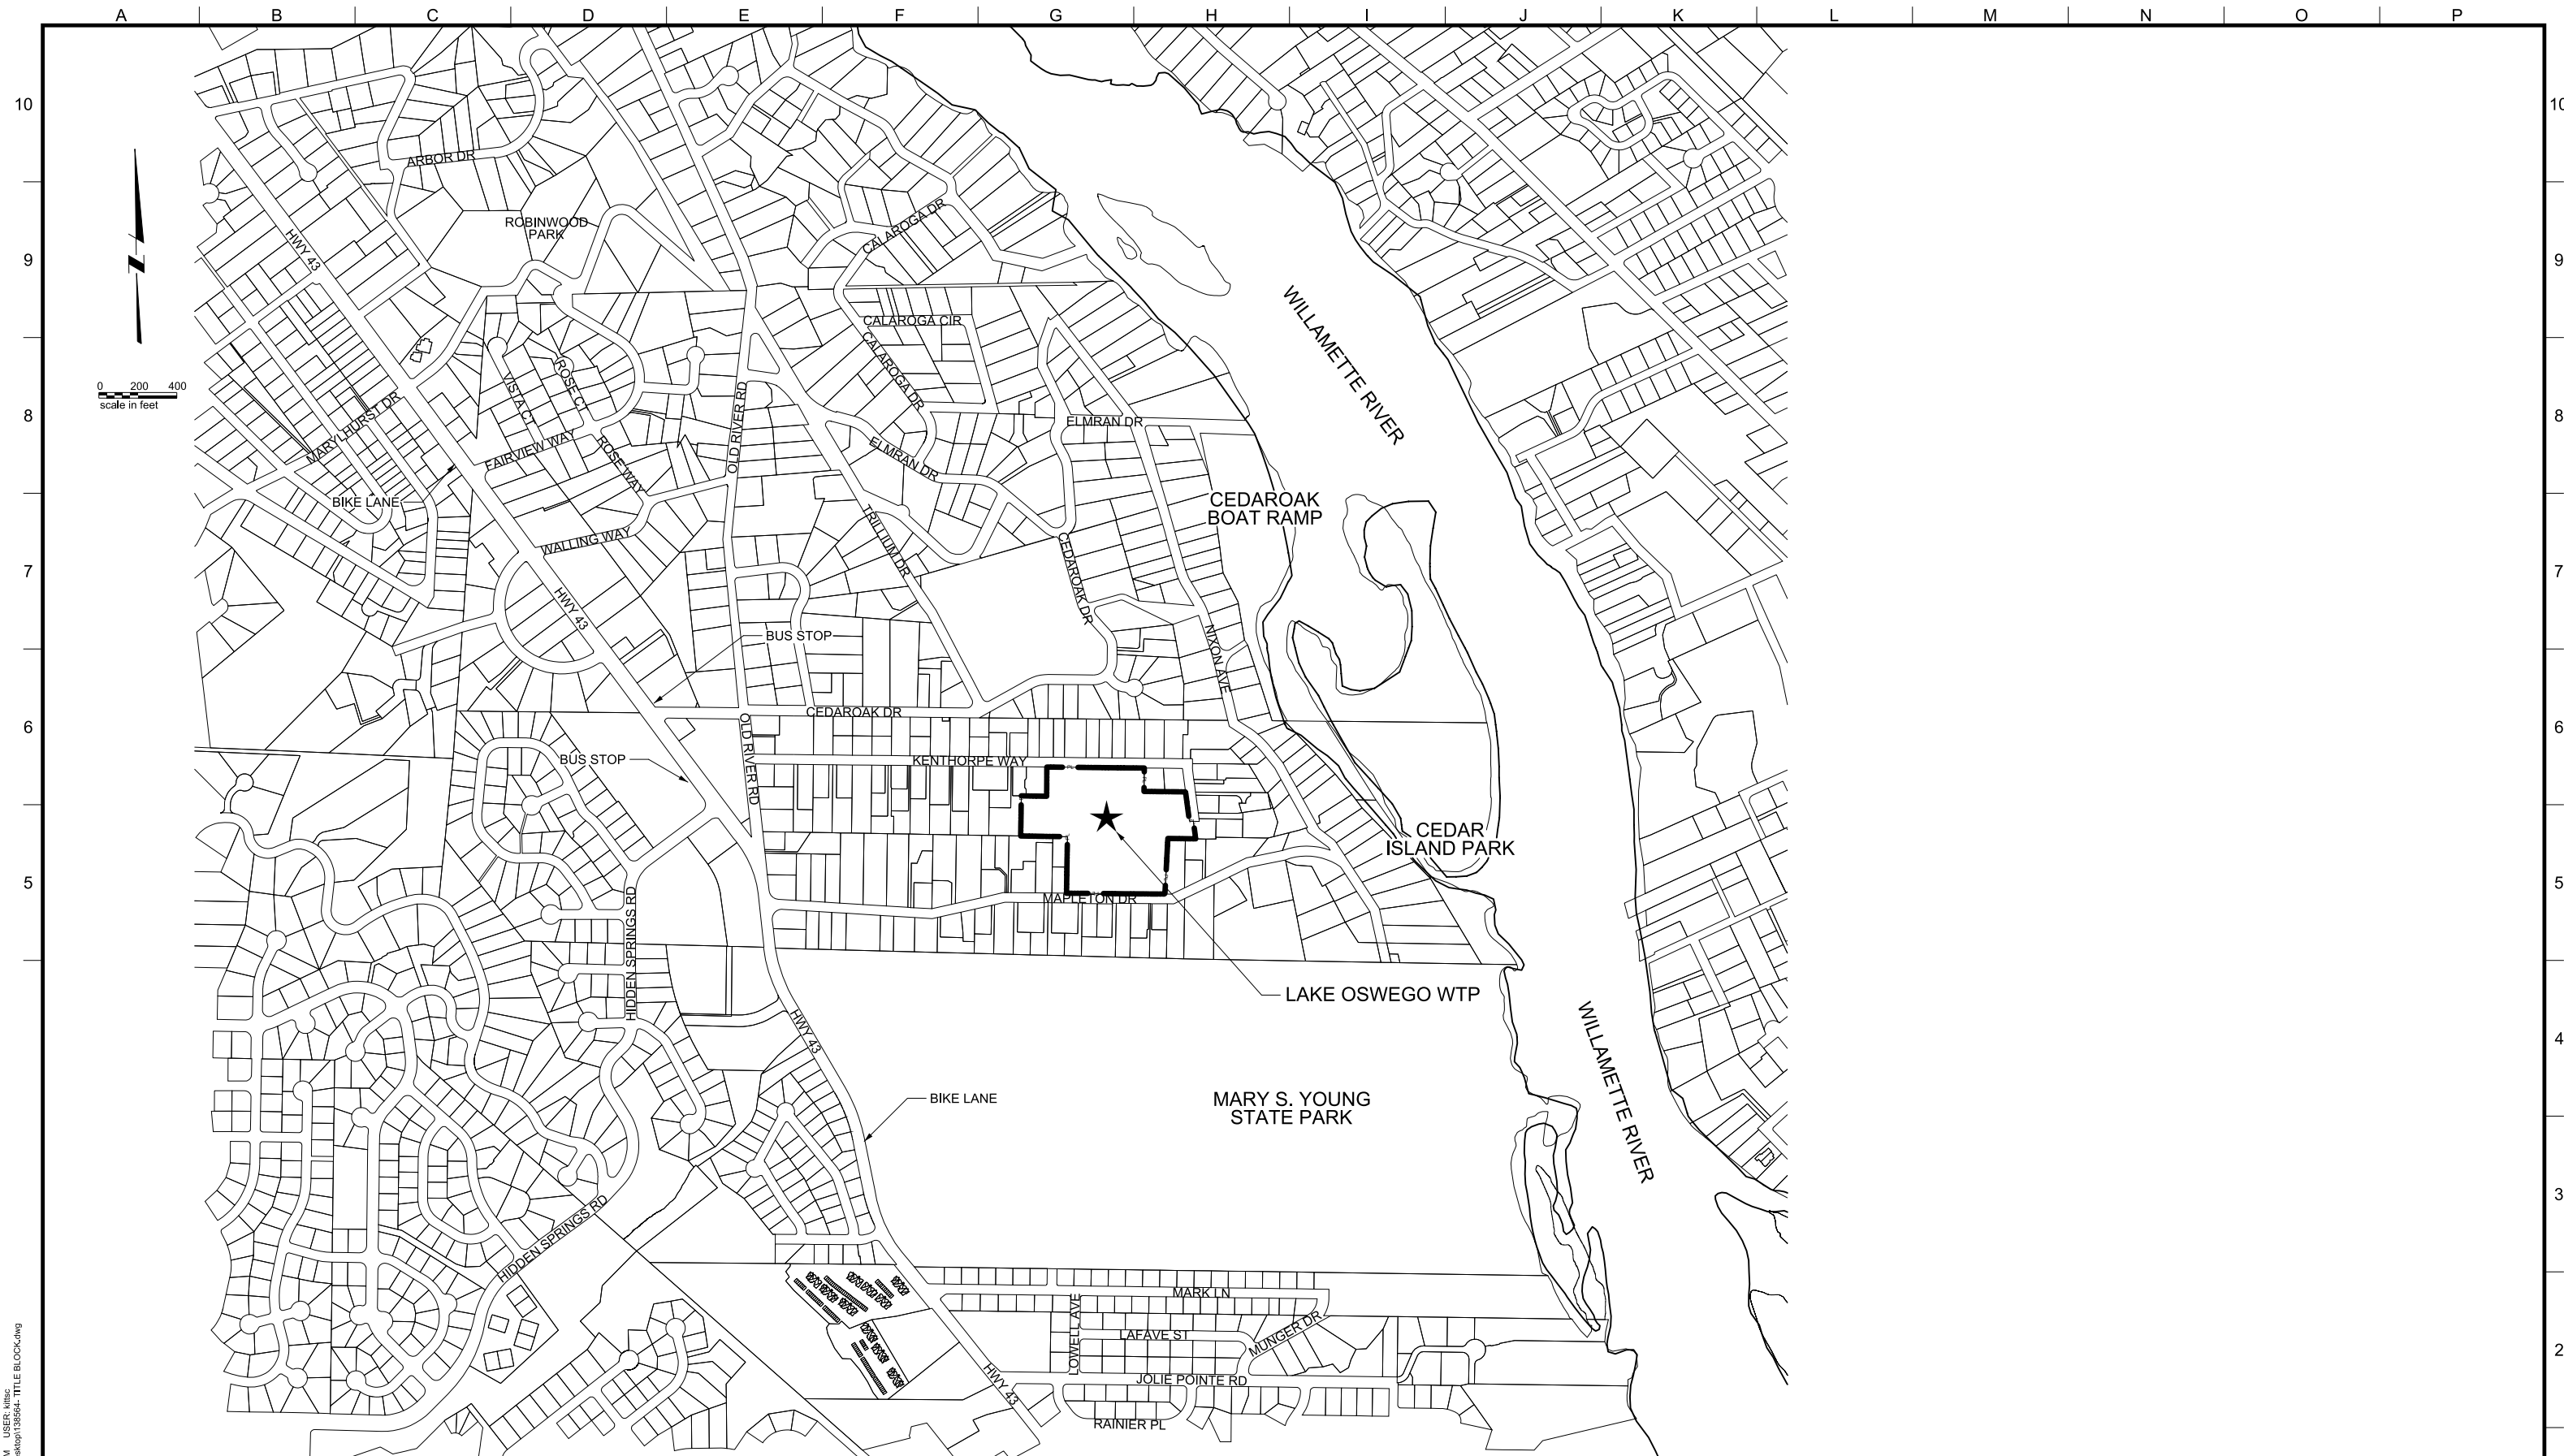
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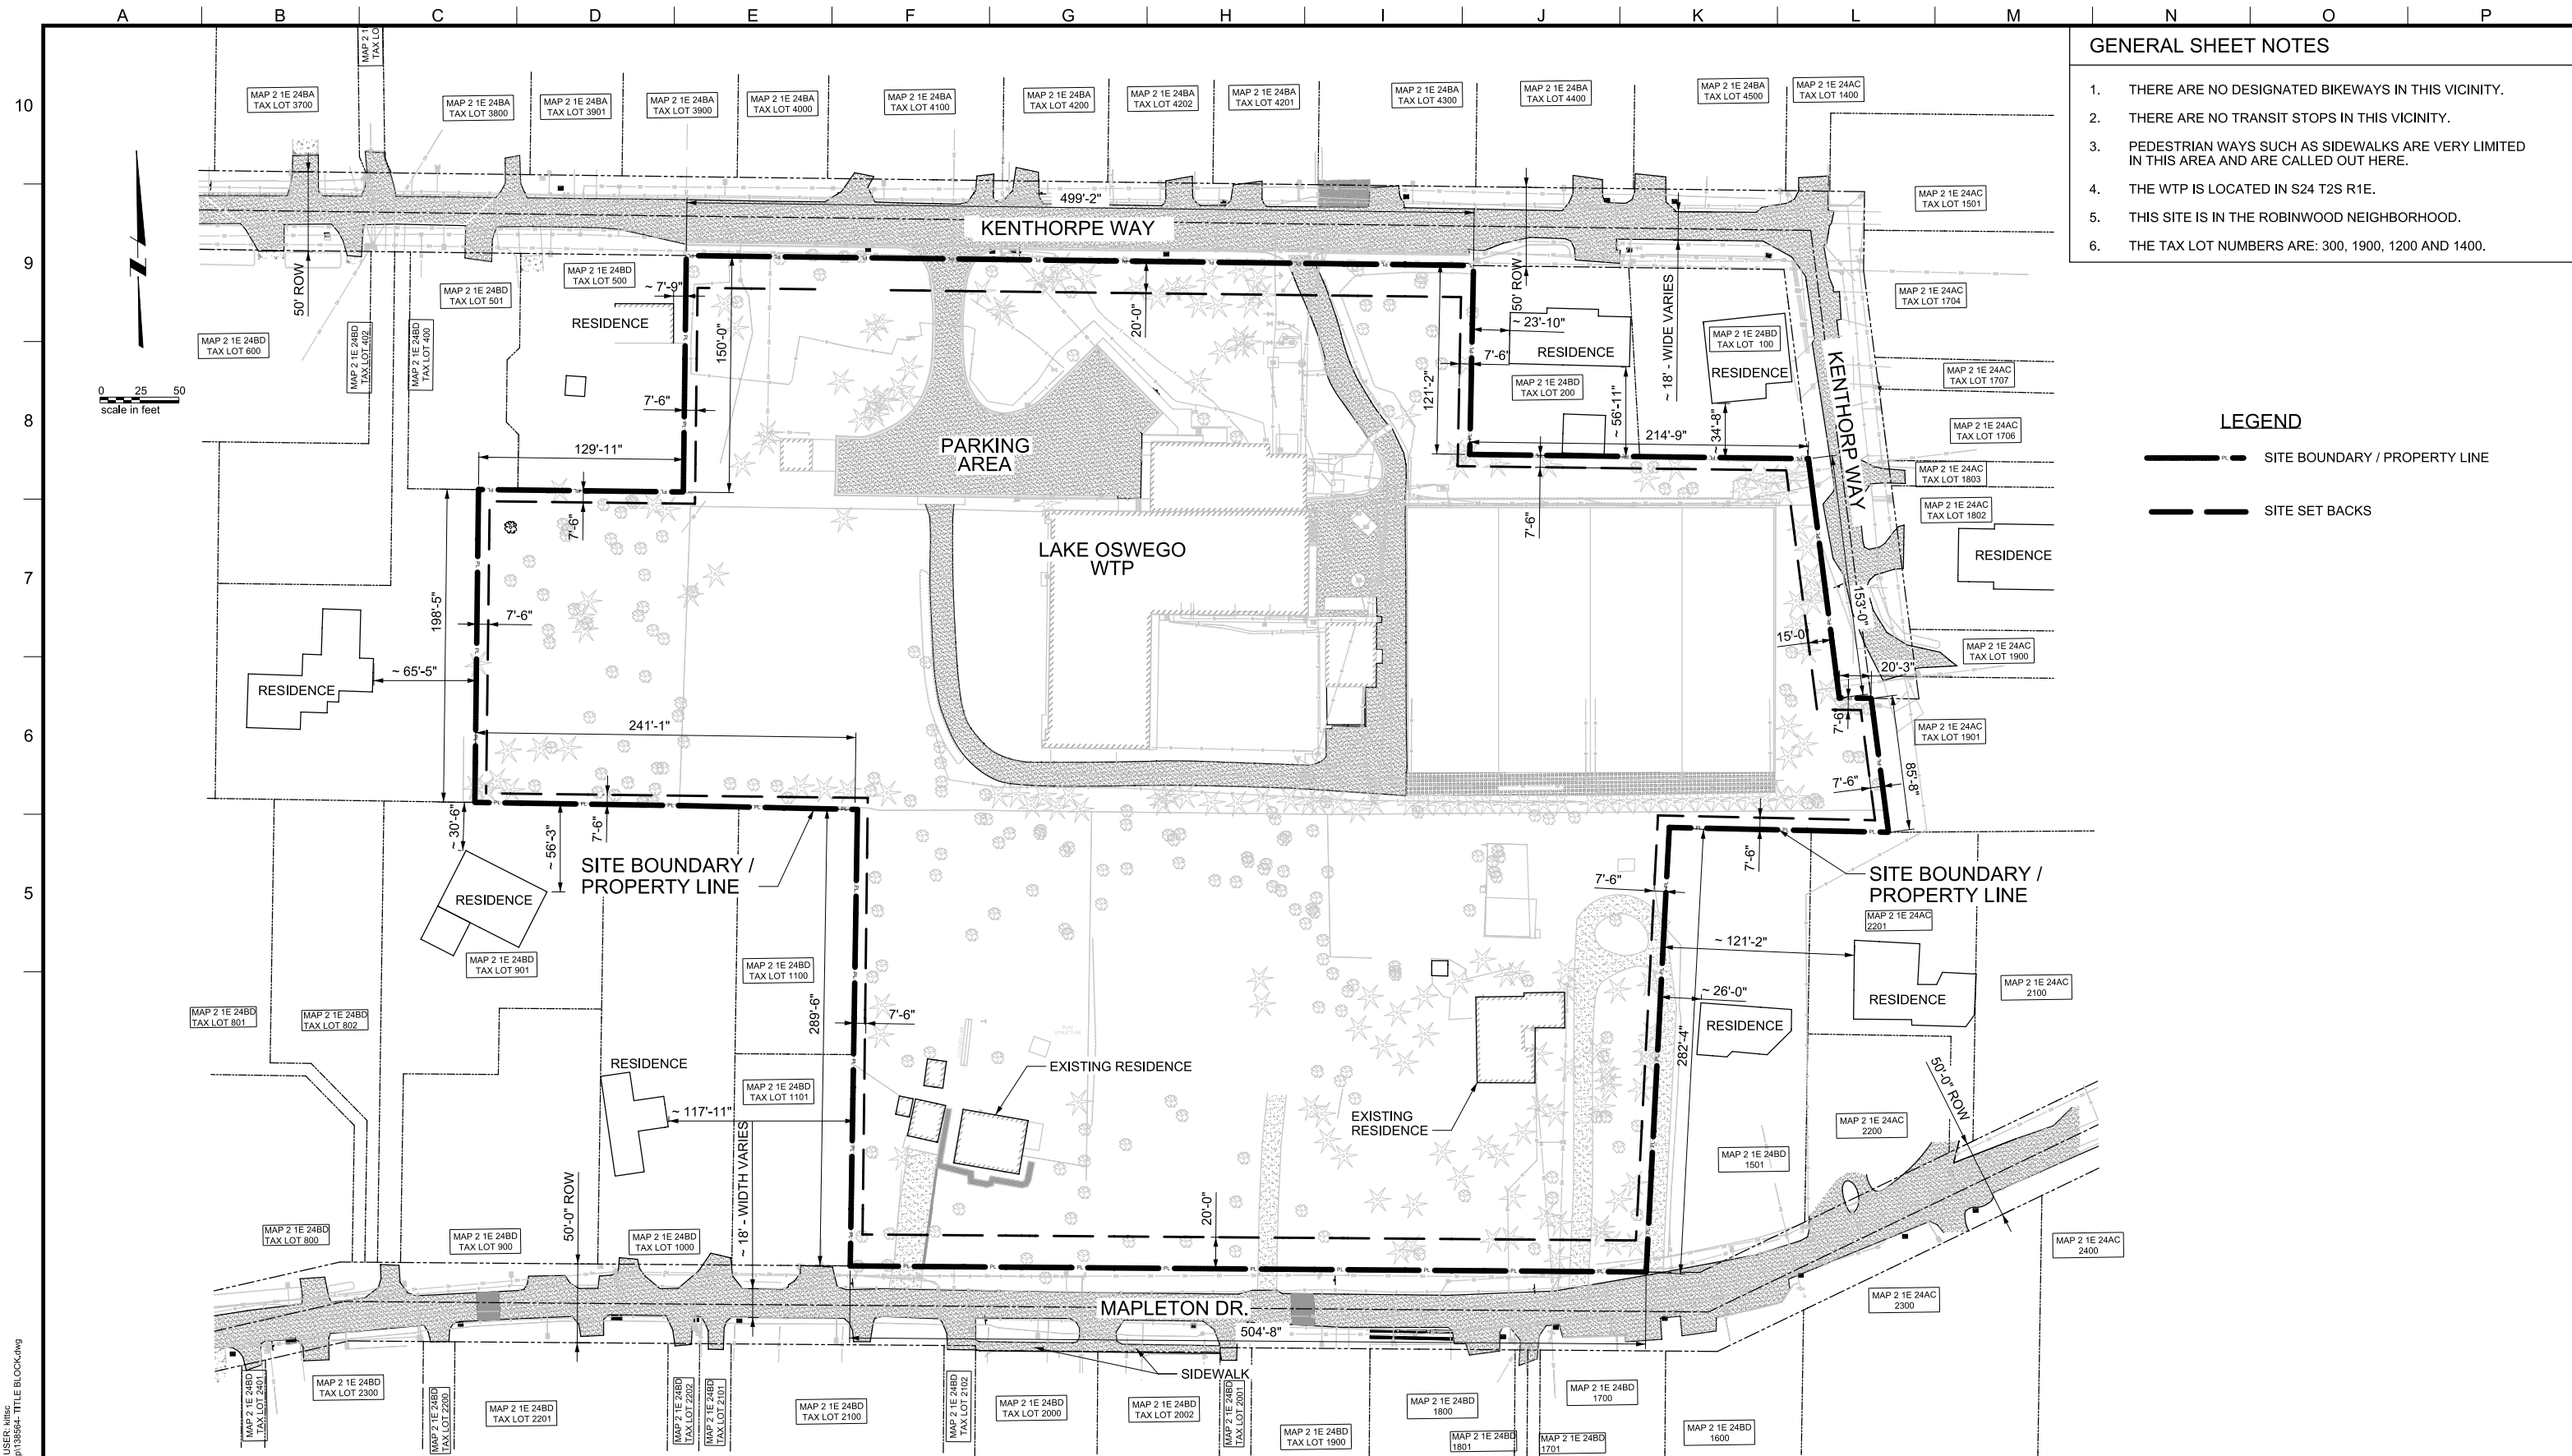
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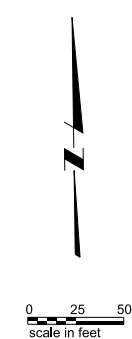


LAKE OSWEGO AND TIGARD WATER TREATMENT PLANT  
DESIGN REVIEW & CONDITIONAL USE  
**SITE ANALYSIS**  
NEIGHBORHOOD VICINITY MAP

FILENAME	
PROJECT NUMBER	1
SCALE	1" = 50'
DRAWING/FIGURE NUMBER	1.0
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- GENERAL SHEET NOTES**
1. THERE ARE NO DESIGNATED BIKEWAYS IN THIS VICINITY.
  2. THERE ARE NO TRANSIT STOPS IN THIS VICINITY.
  3. PEDESTRIAN WAYS SUCH AS SIDEWALKS ARE VERY LIMITED IN THIS AREA AND ARE CALLED OUT HERE.
  4. THE WTP IS LOCATED IN S24 T2S R1E.
  5. THIS SITE IS IN THE ROBINWOOD NEIGHBORHOOD.
  6. THE TAX LOT NUMBERS ARE: 300, 1900, 1200 AND 1400.



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LAKE OSWEGO AND TIGARD WATER TREATMENT PLANT  
 DESIGN REVIEW & CONDITIONAL USE

**SITE ANALYSIS  
 VICINITY MAP**

FILENAME	
PROJECT NUMBER	1
SCALE	1" = 50'
DRAWING/FIGURE NUMBER	1.1
#### OF	



- ### GENERAL SHEET NOTES
1. SITE BOUNDARY IS WITHIN THE ROBINWOOD NEIGHBORHOOD ASSOCIATION.
  2. GROSS SITE AREA IS 9.24 ACRES.
  3. THE ENTIRE SITE SLOPE IS LESS THAN 15% GRADE.
  4. THE EXISTING SITE CONTAINS NO POTENTIAL NATURAL HAZARDS.
  5. THE EXISTING SITE CONTAINS NO RESOURCE AREAS.
  6. THE EXISTING SITE CONTAINS NO SIGNIFICANT FEATURES.
  7. THE EXISTING SITE CONTAINS NO STREAMS OR STREAM CORRIDORS.
  8. THERE ARE NO HERITAGE TREES ON SITE.
  9. THERE ARE NO GOAL 5 RESOURCES ON THIS SITE.
  10. THERE ARE NO TYPE II LANDS ON THE EXISTING SITE.
  11. HARDSCAPE HATCHES NOT SHOWN FOR CLARITY, SEE FIGURES 2.1 - 2.4.
  12. TREE SIZES AND NUMBER ARE NOT SHOWN ON OVERVIEW FOR CLARITY. SEE FIGURES 2.5 - 2.12 FOR INFORMATION ON EXISTING TREES AND TREES TO BE REMOVED.
  13. DRIPLINE PLUS 10-FT TOTAL AREA = 72,700 SQ-FT AND IS 18% OF ALL NON-TYPE I AND TYPE II LANDS.
  14. EXISTING STRUCTURE AND PARKING DIMENSIONS ARE SHOWN ON 2.1 - 2.4.
  15. LOCATIONS OF EXISTING STRUCTURES OFF-SITE ARE APPROXIMATE.
  16. ALL TREES SHOWN ARE 6-INCH OR GREATER AT 5-FT DBH.

- ### LEGEND
- SITE BOUNDARY / PROPERTY LINE
  - KEY PLAN BOUNDARY
  - EXISTING PAVEMENT
  - EXISTING GRAVEL
  - EXISTING NATURAL PERVIOUS GROUND
  - EXISTING CONSTRUCTED PERVIOUS SURFACE
  - UNDERGROUND ELECTRICAL
  - GAS
  - OVERHEAD POWER
  - STORM WATER UTILITY
  - SANITARY SEWER
  - UNDERGROUND COMMUNICATION
  - UNDERGROUND WATER UTILITY
  - MISCELLANEOUS BORING
  - FLOW ARROW
  - DECIDUOUS TREE
  - CONIFEROUS TREE
  - TREE OF SIGNIFICANCE
  - UNREGULATED TREE REMOVAL
  - REGULATED TREE REMOVAL
  - TREES TO BE SAVED
  - 142' CONTOUR LINE
  - 2'-6" DIMENSION LINE

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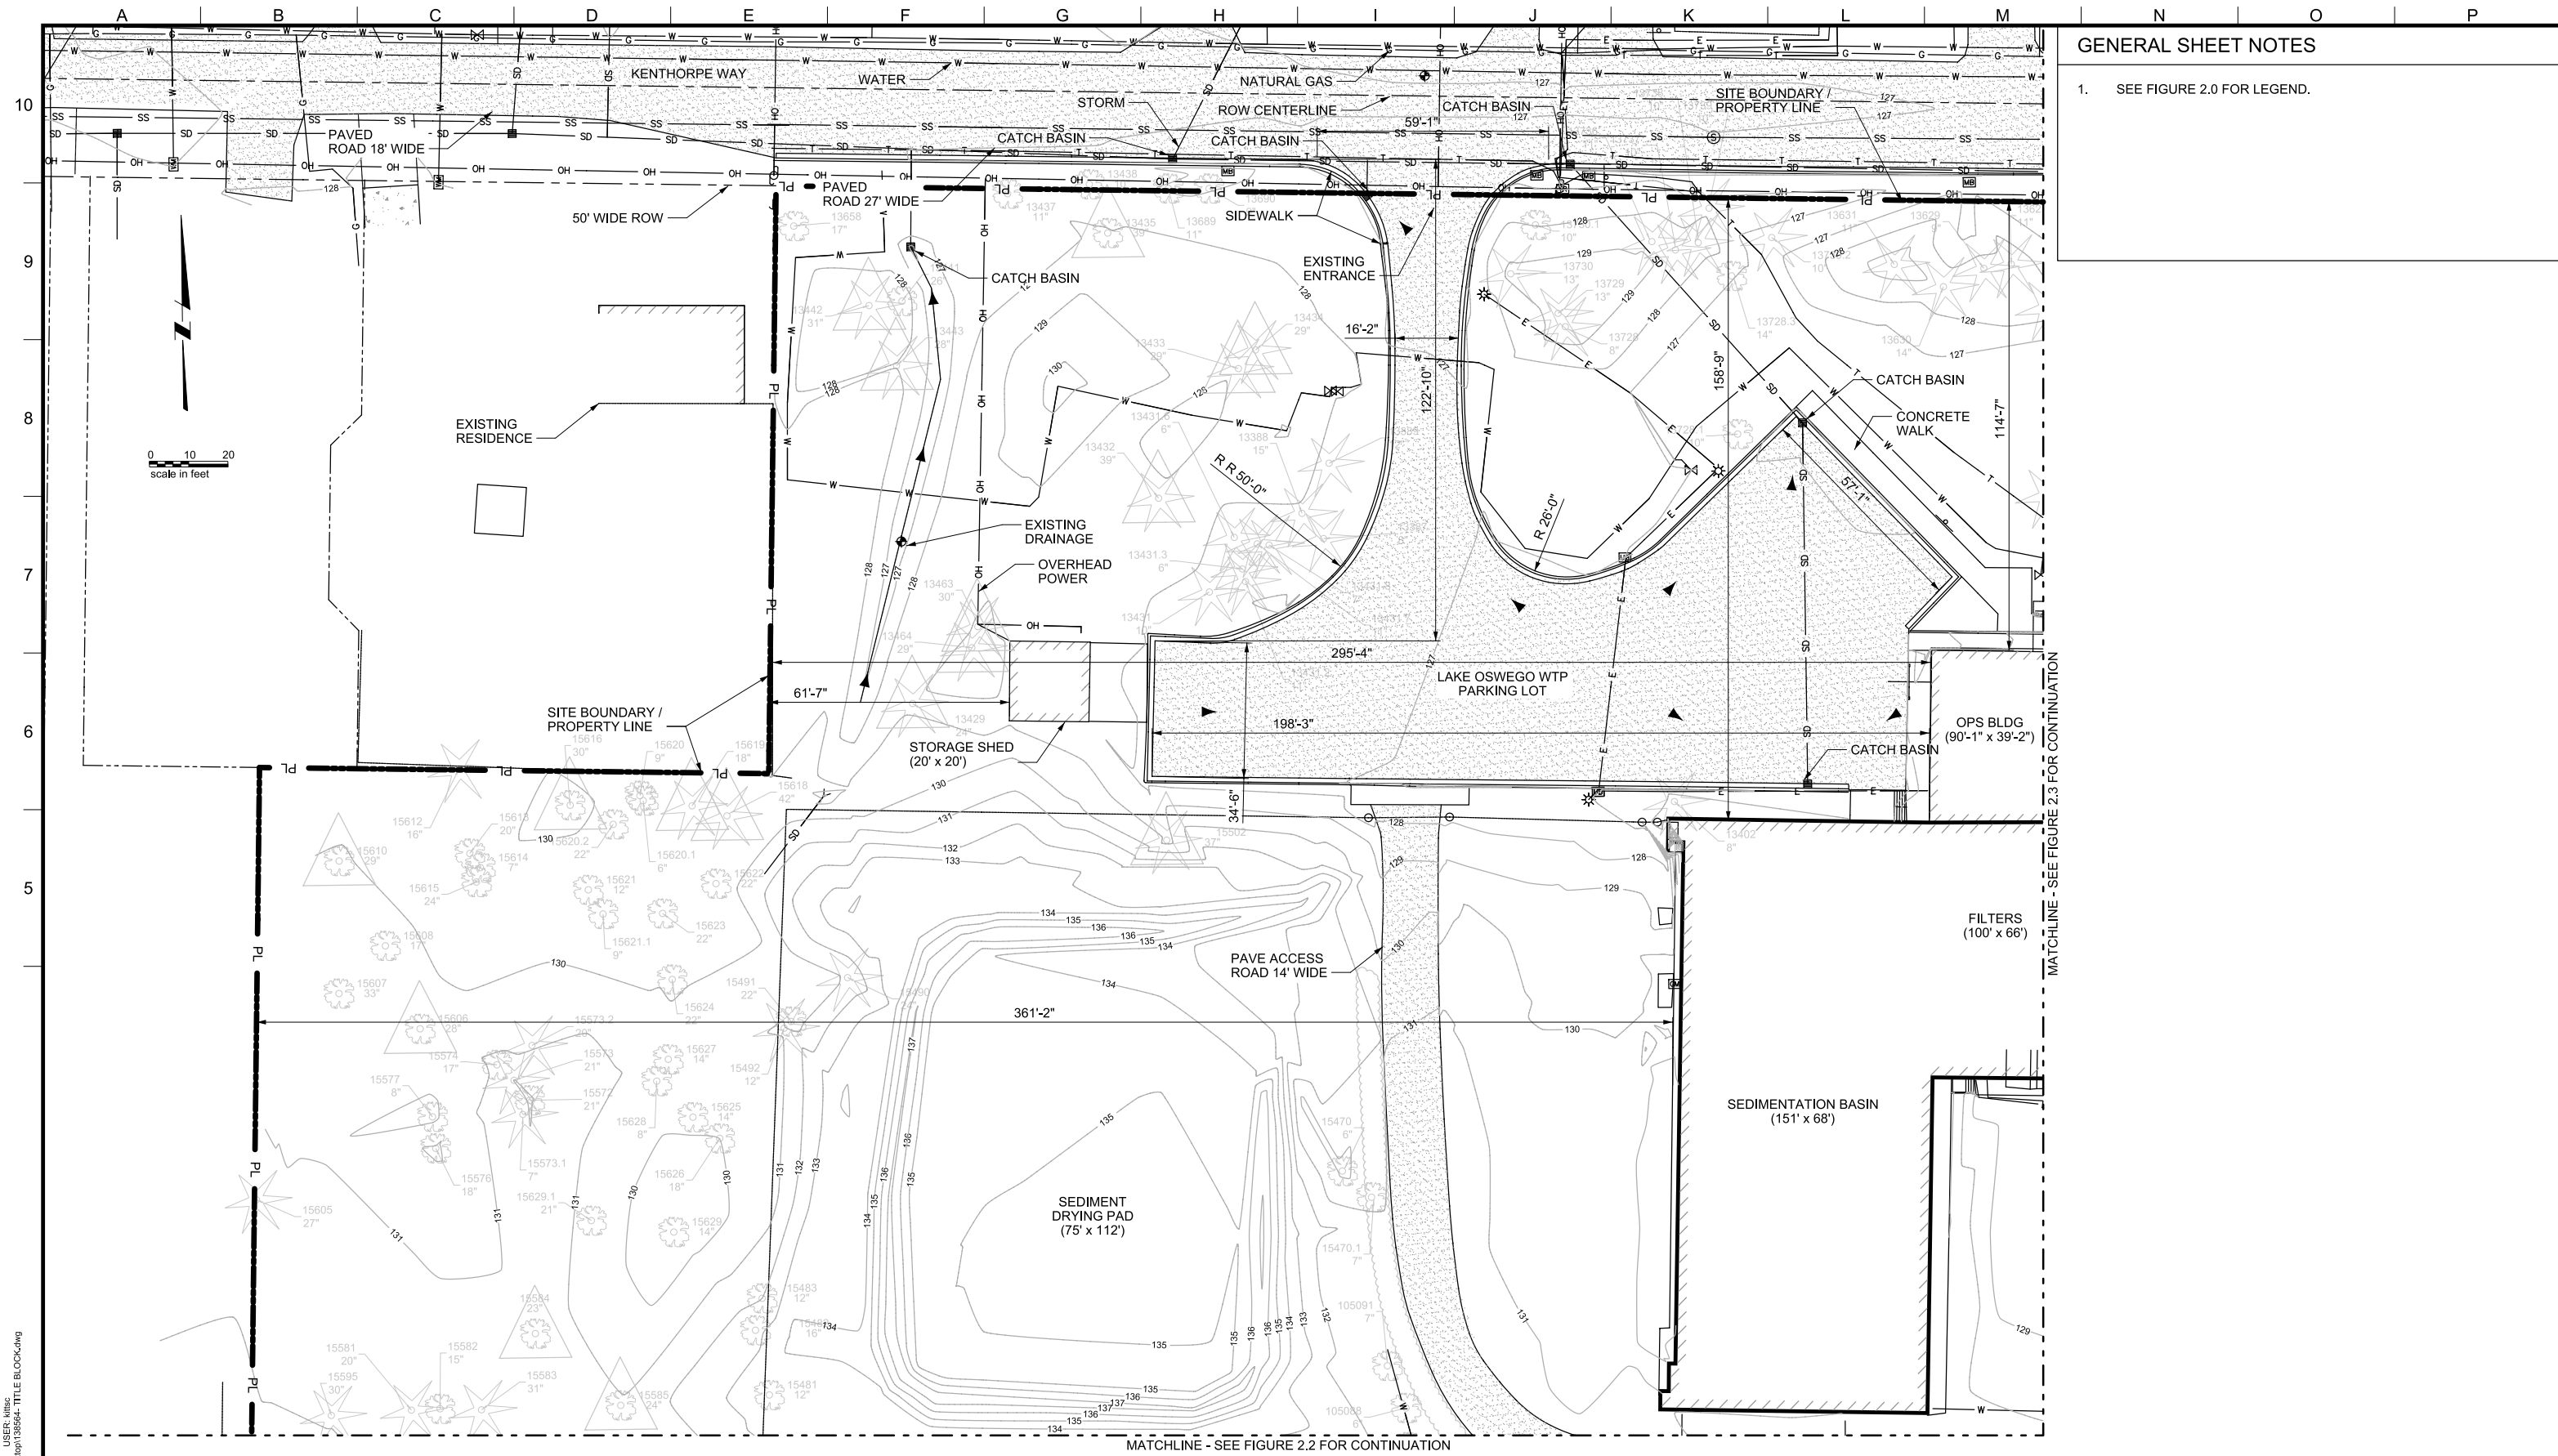
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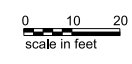
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 DESIGN REVIEW AND CONDITIONAL USE  
**SITE ANALYSIS - EXISTING SITE OVERVIEW**

FILENAME	
PROJECT NUMBER	1
SCALE	1" = 50'
DRAWING/FIGURE NUMBER	2.0
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**GENERAL SHEET NOTES**

1. SEE FIGURE 2.0 FOR LEGEND.



MATCHLINE - SEE FIGURE 2.3 FOR CONTINUATION

MATCHLINE - SEE FIGURE 2.2 FOR CONTINUATION

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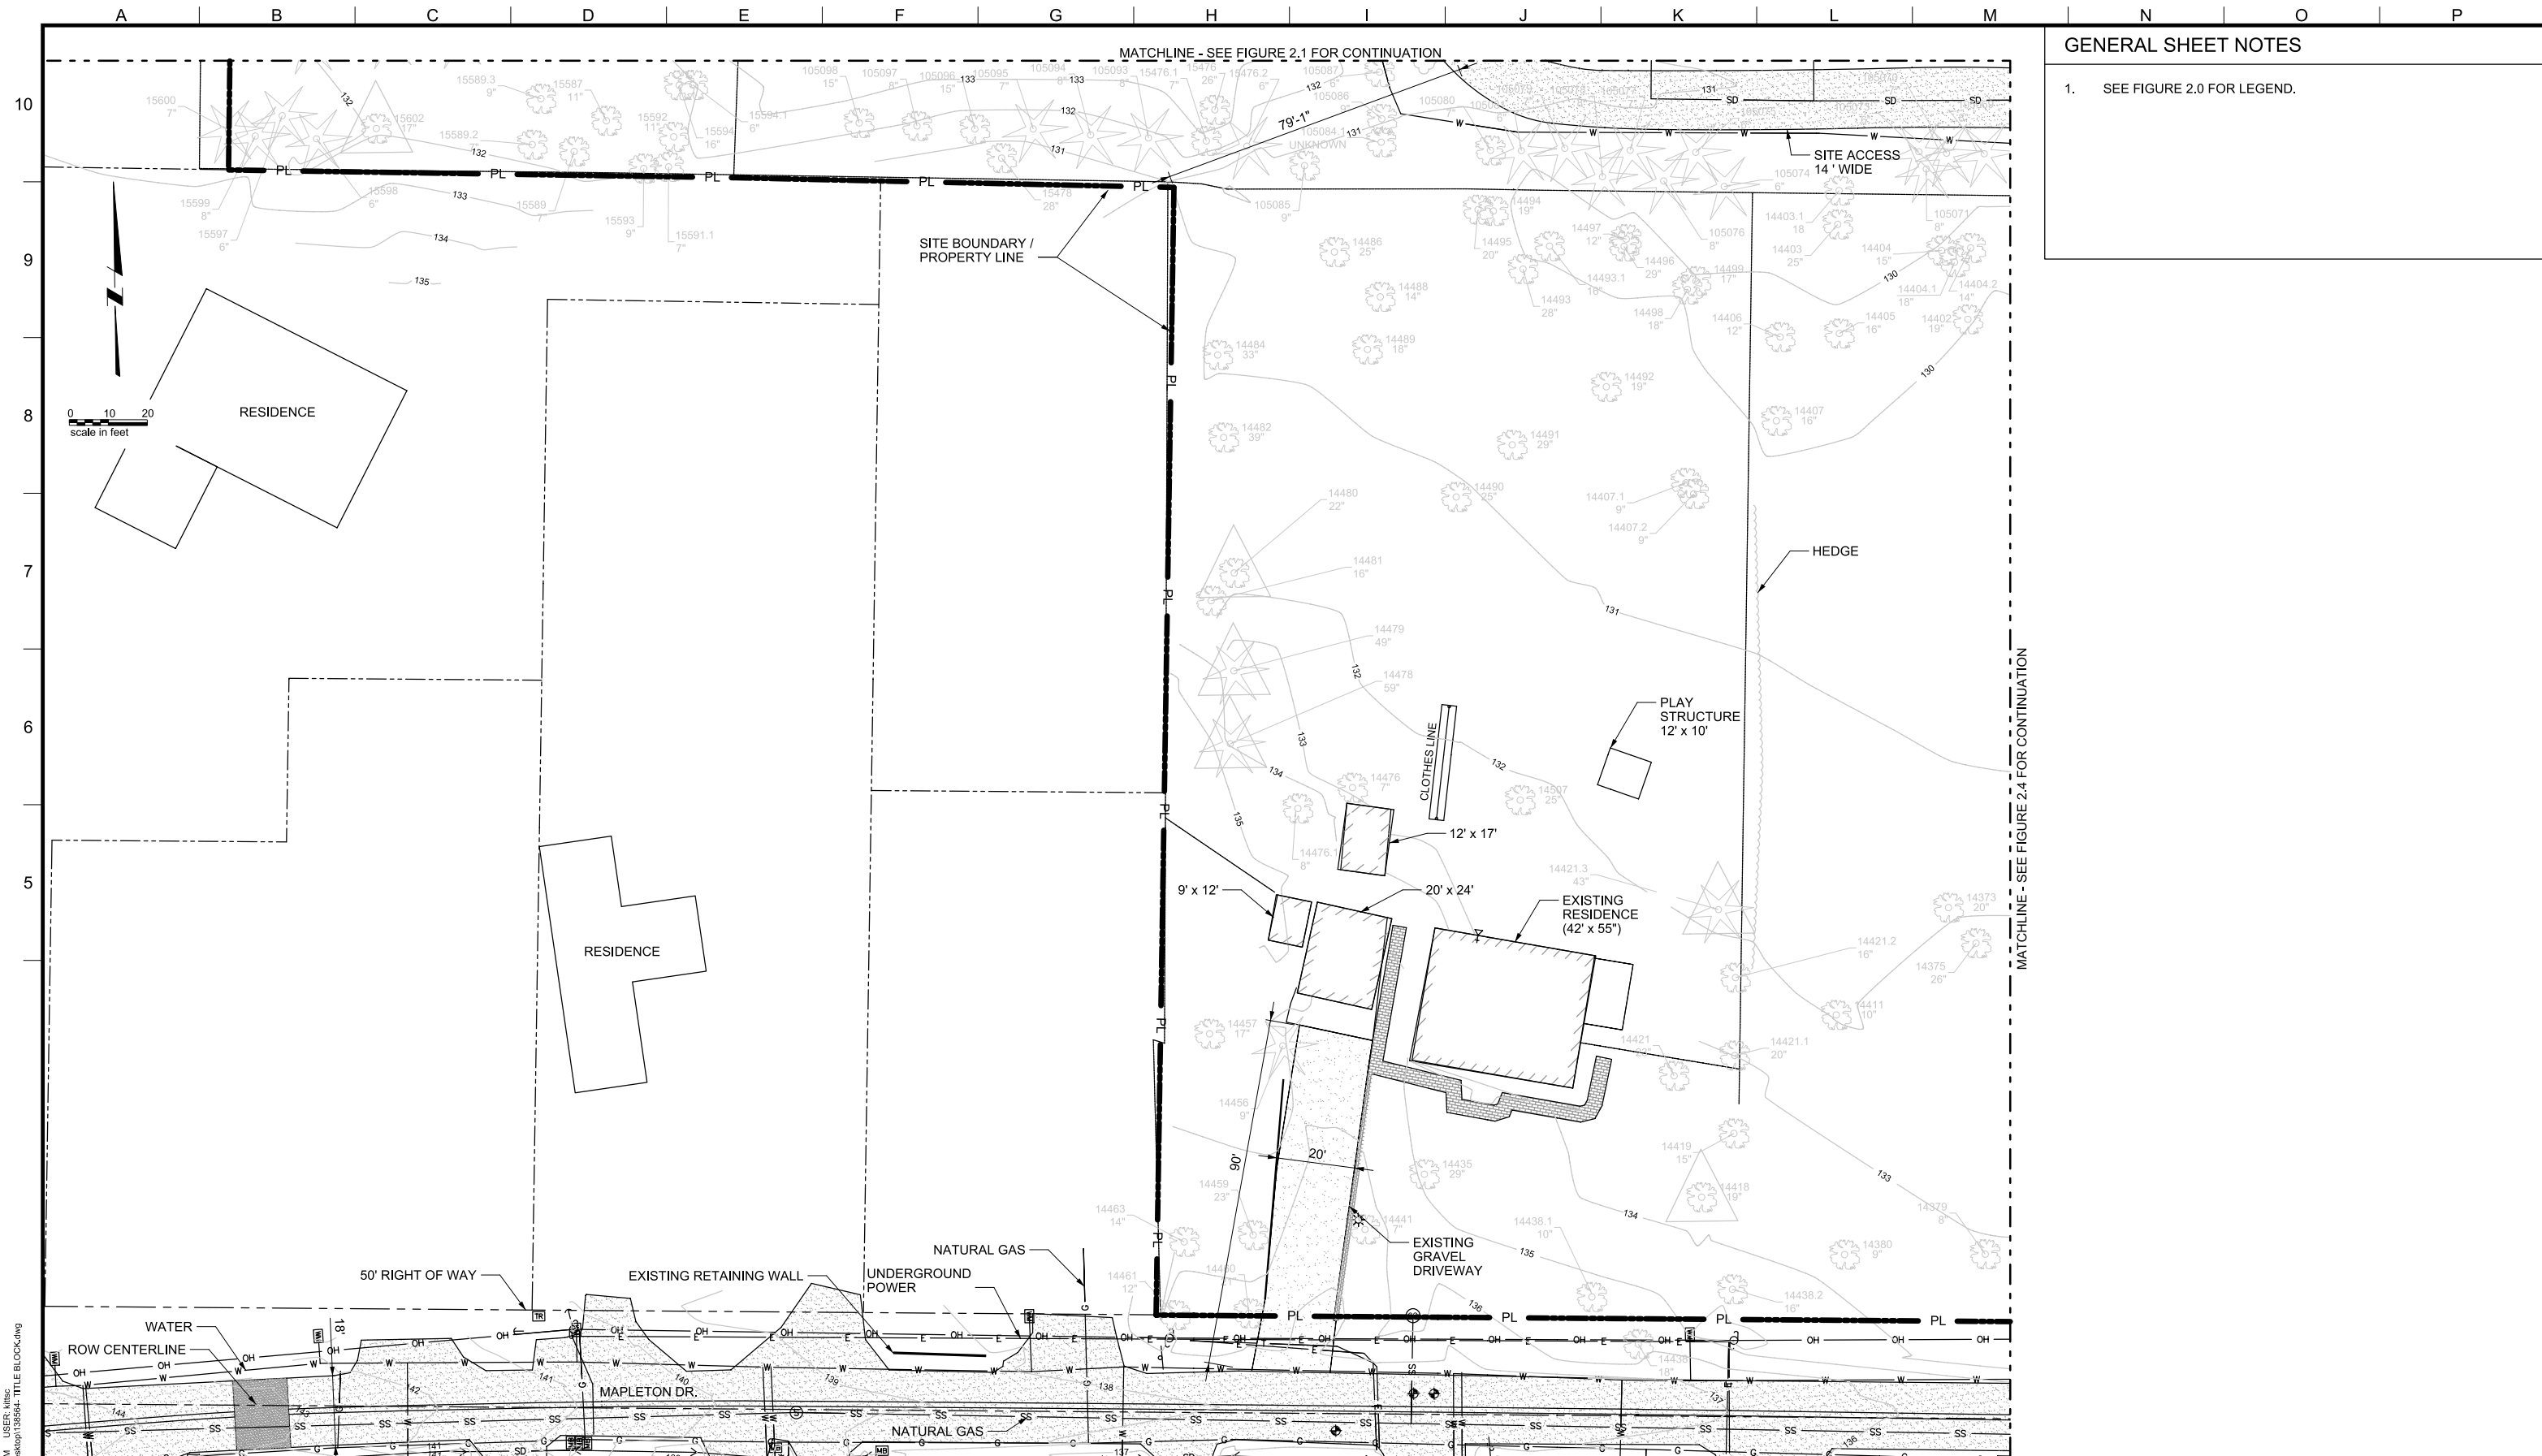
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LAKE OSWEGO AND TIGARD WATER TREATMENT PLANT  
 DESIGN REVIEW AND CONDITIONAL USE  
 SITE ANALYSIS - EXISTING SITE  
 AREA A

FILENAME	
PROJECT NUMBER	
SCALE	1" = 20'
DRAWING/FIGURE NUMBER	2.1
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**GENERAL SHEET NOTES**

1. SEE FIGURE 2.0 FOR LEGEND.

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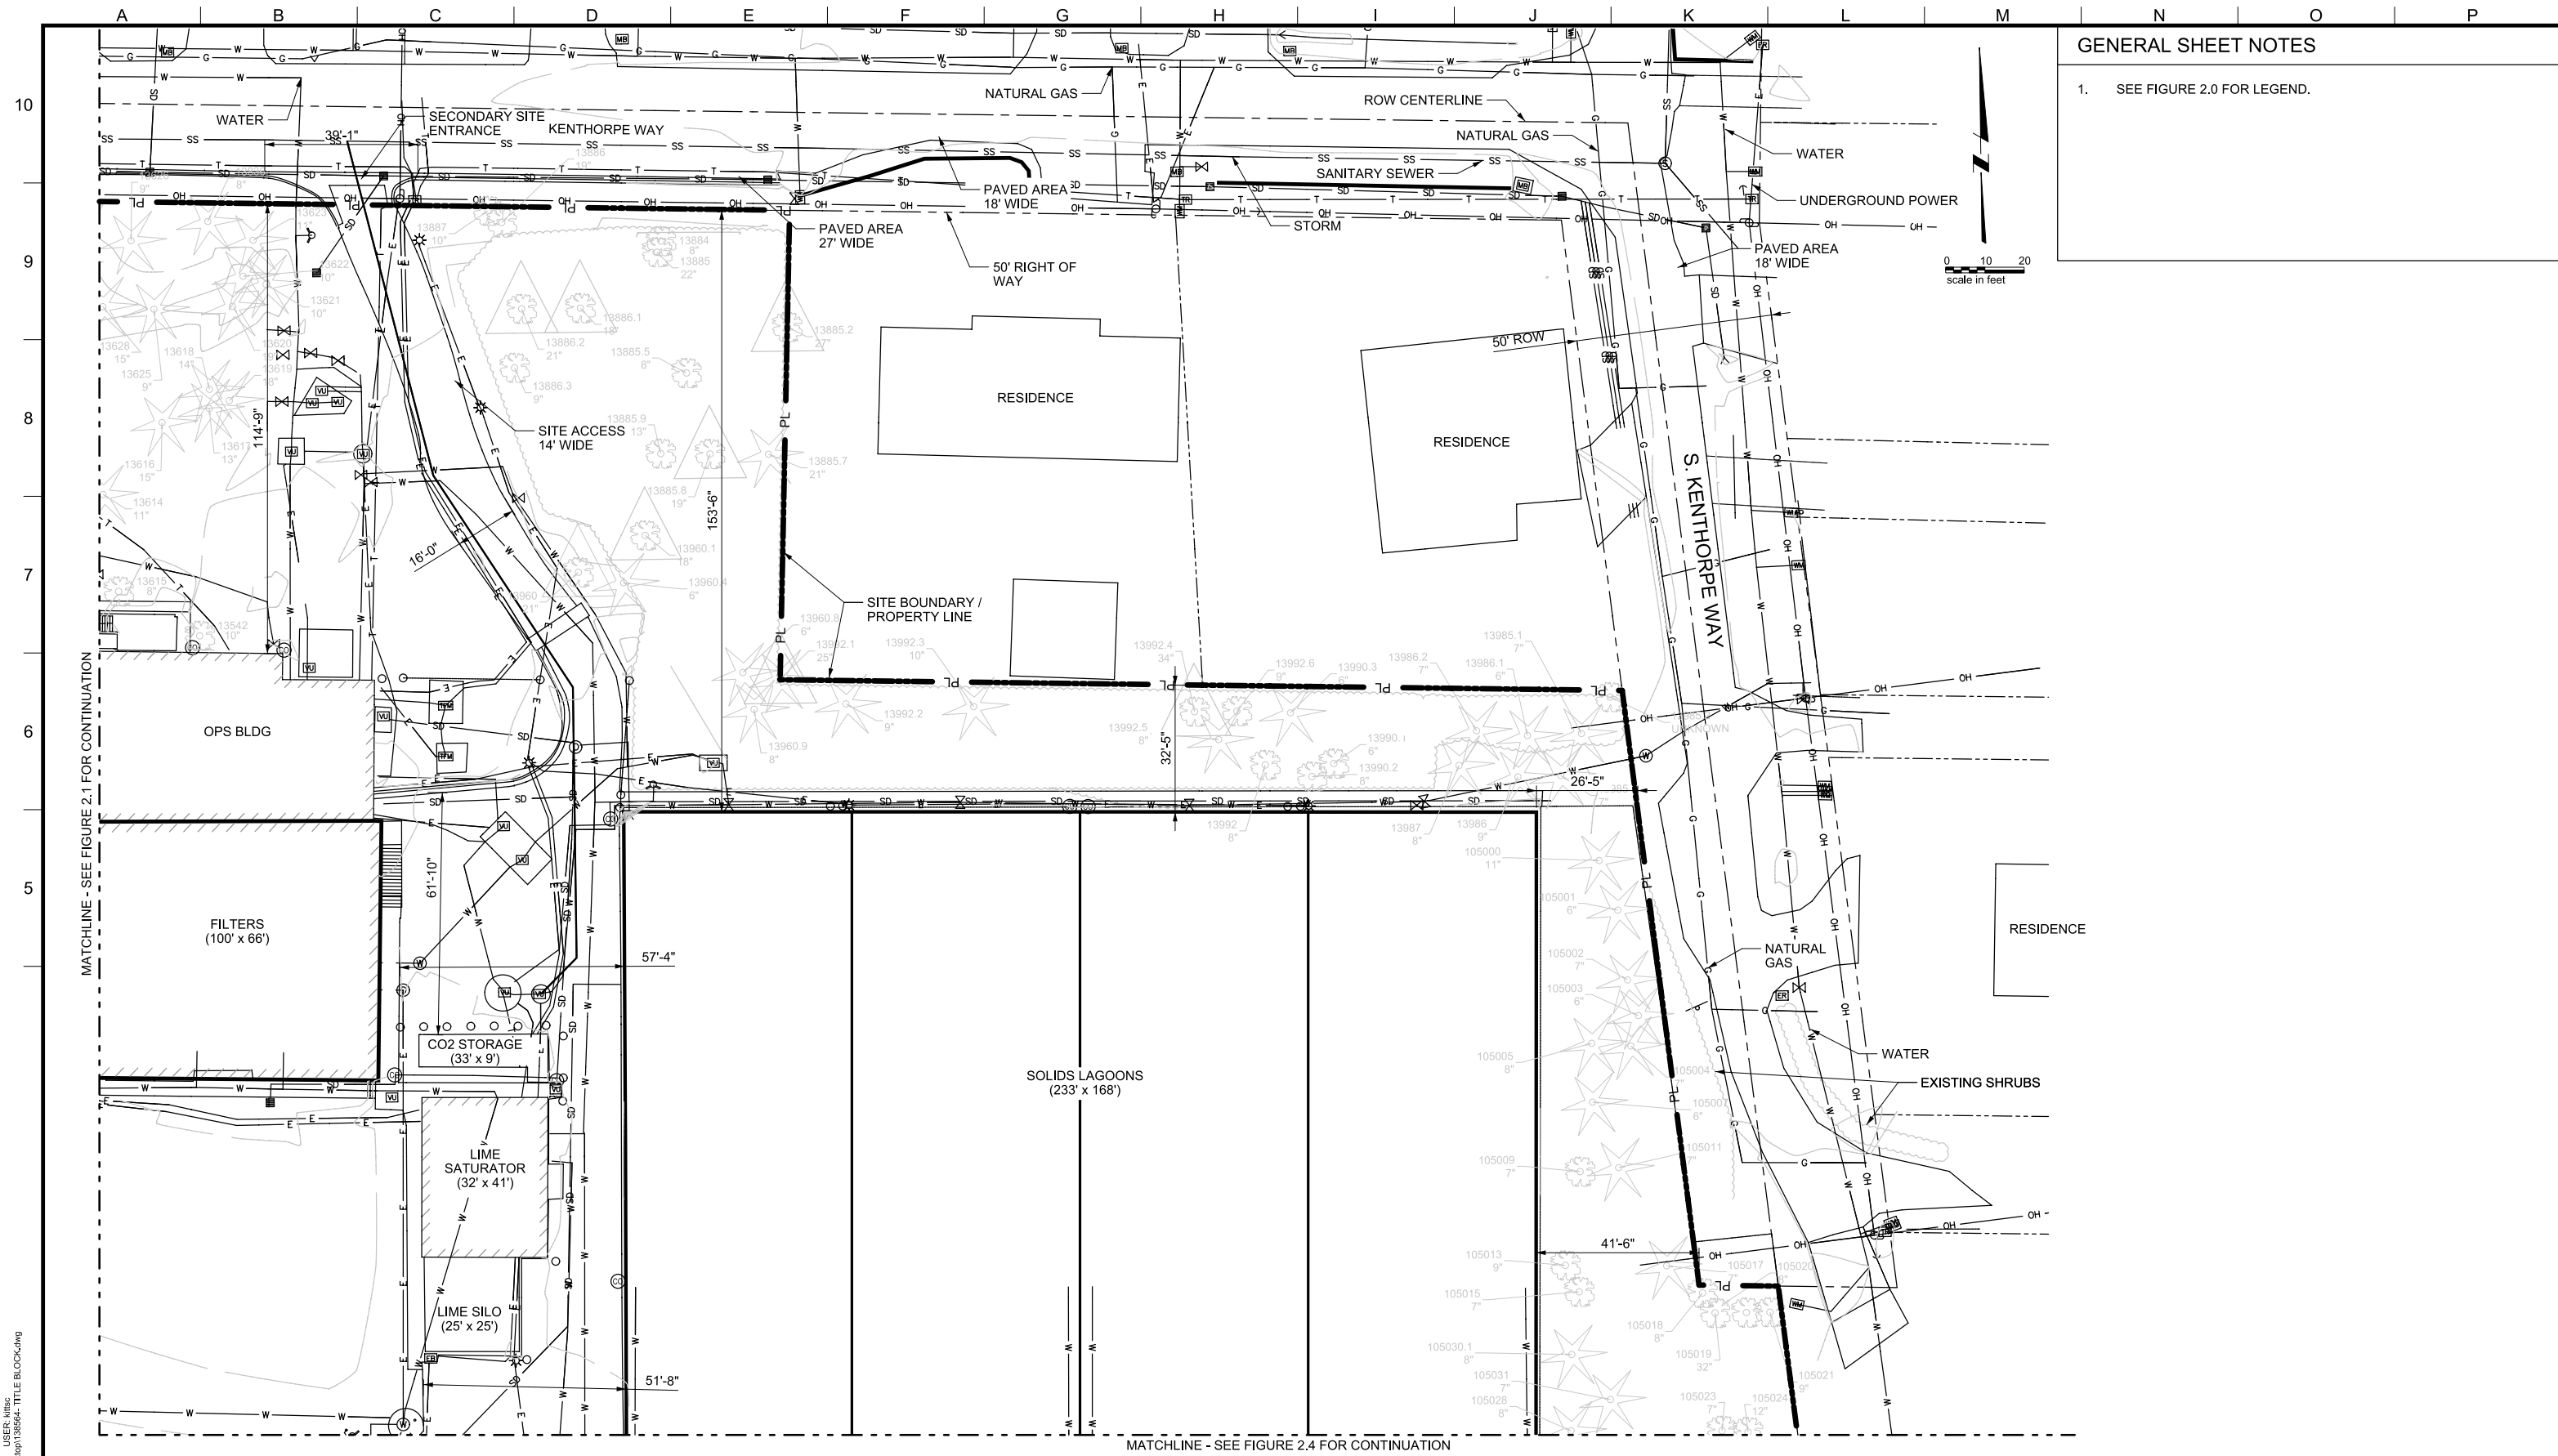
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LAKE OSWEGO AND TIGARD WATER TREATMENT PLANT  
 DESIGN REVIEW AND CONDITIONAL USE  
**SITE ANALYSIS - EXISTING SITE  
 AREA B**

FILENAME	
PROJECT NUMBER	
SCALE	1" = 20'
DRAWING/FIGURE NUMBER	2.2
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**GENERAL SHEET NOTES**

1. SEE FIGURE 2.0 FOR LEGEND.

MATCHLINE - SEE FIGURE 2.1 FOR CONTINUATION

MATCHLINE - SEE FIGURE 2.4 FOR CONTINUATION



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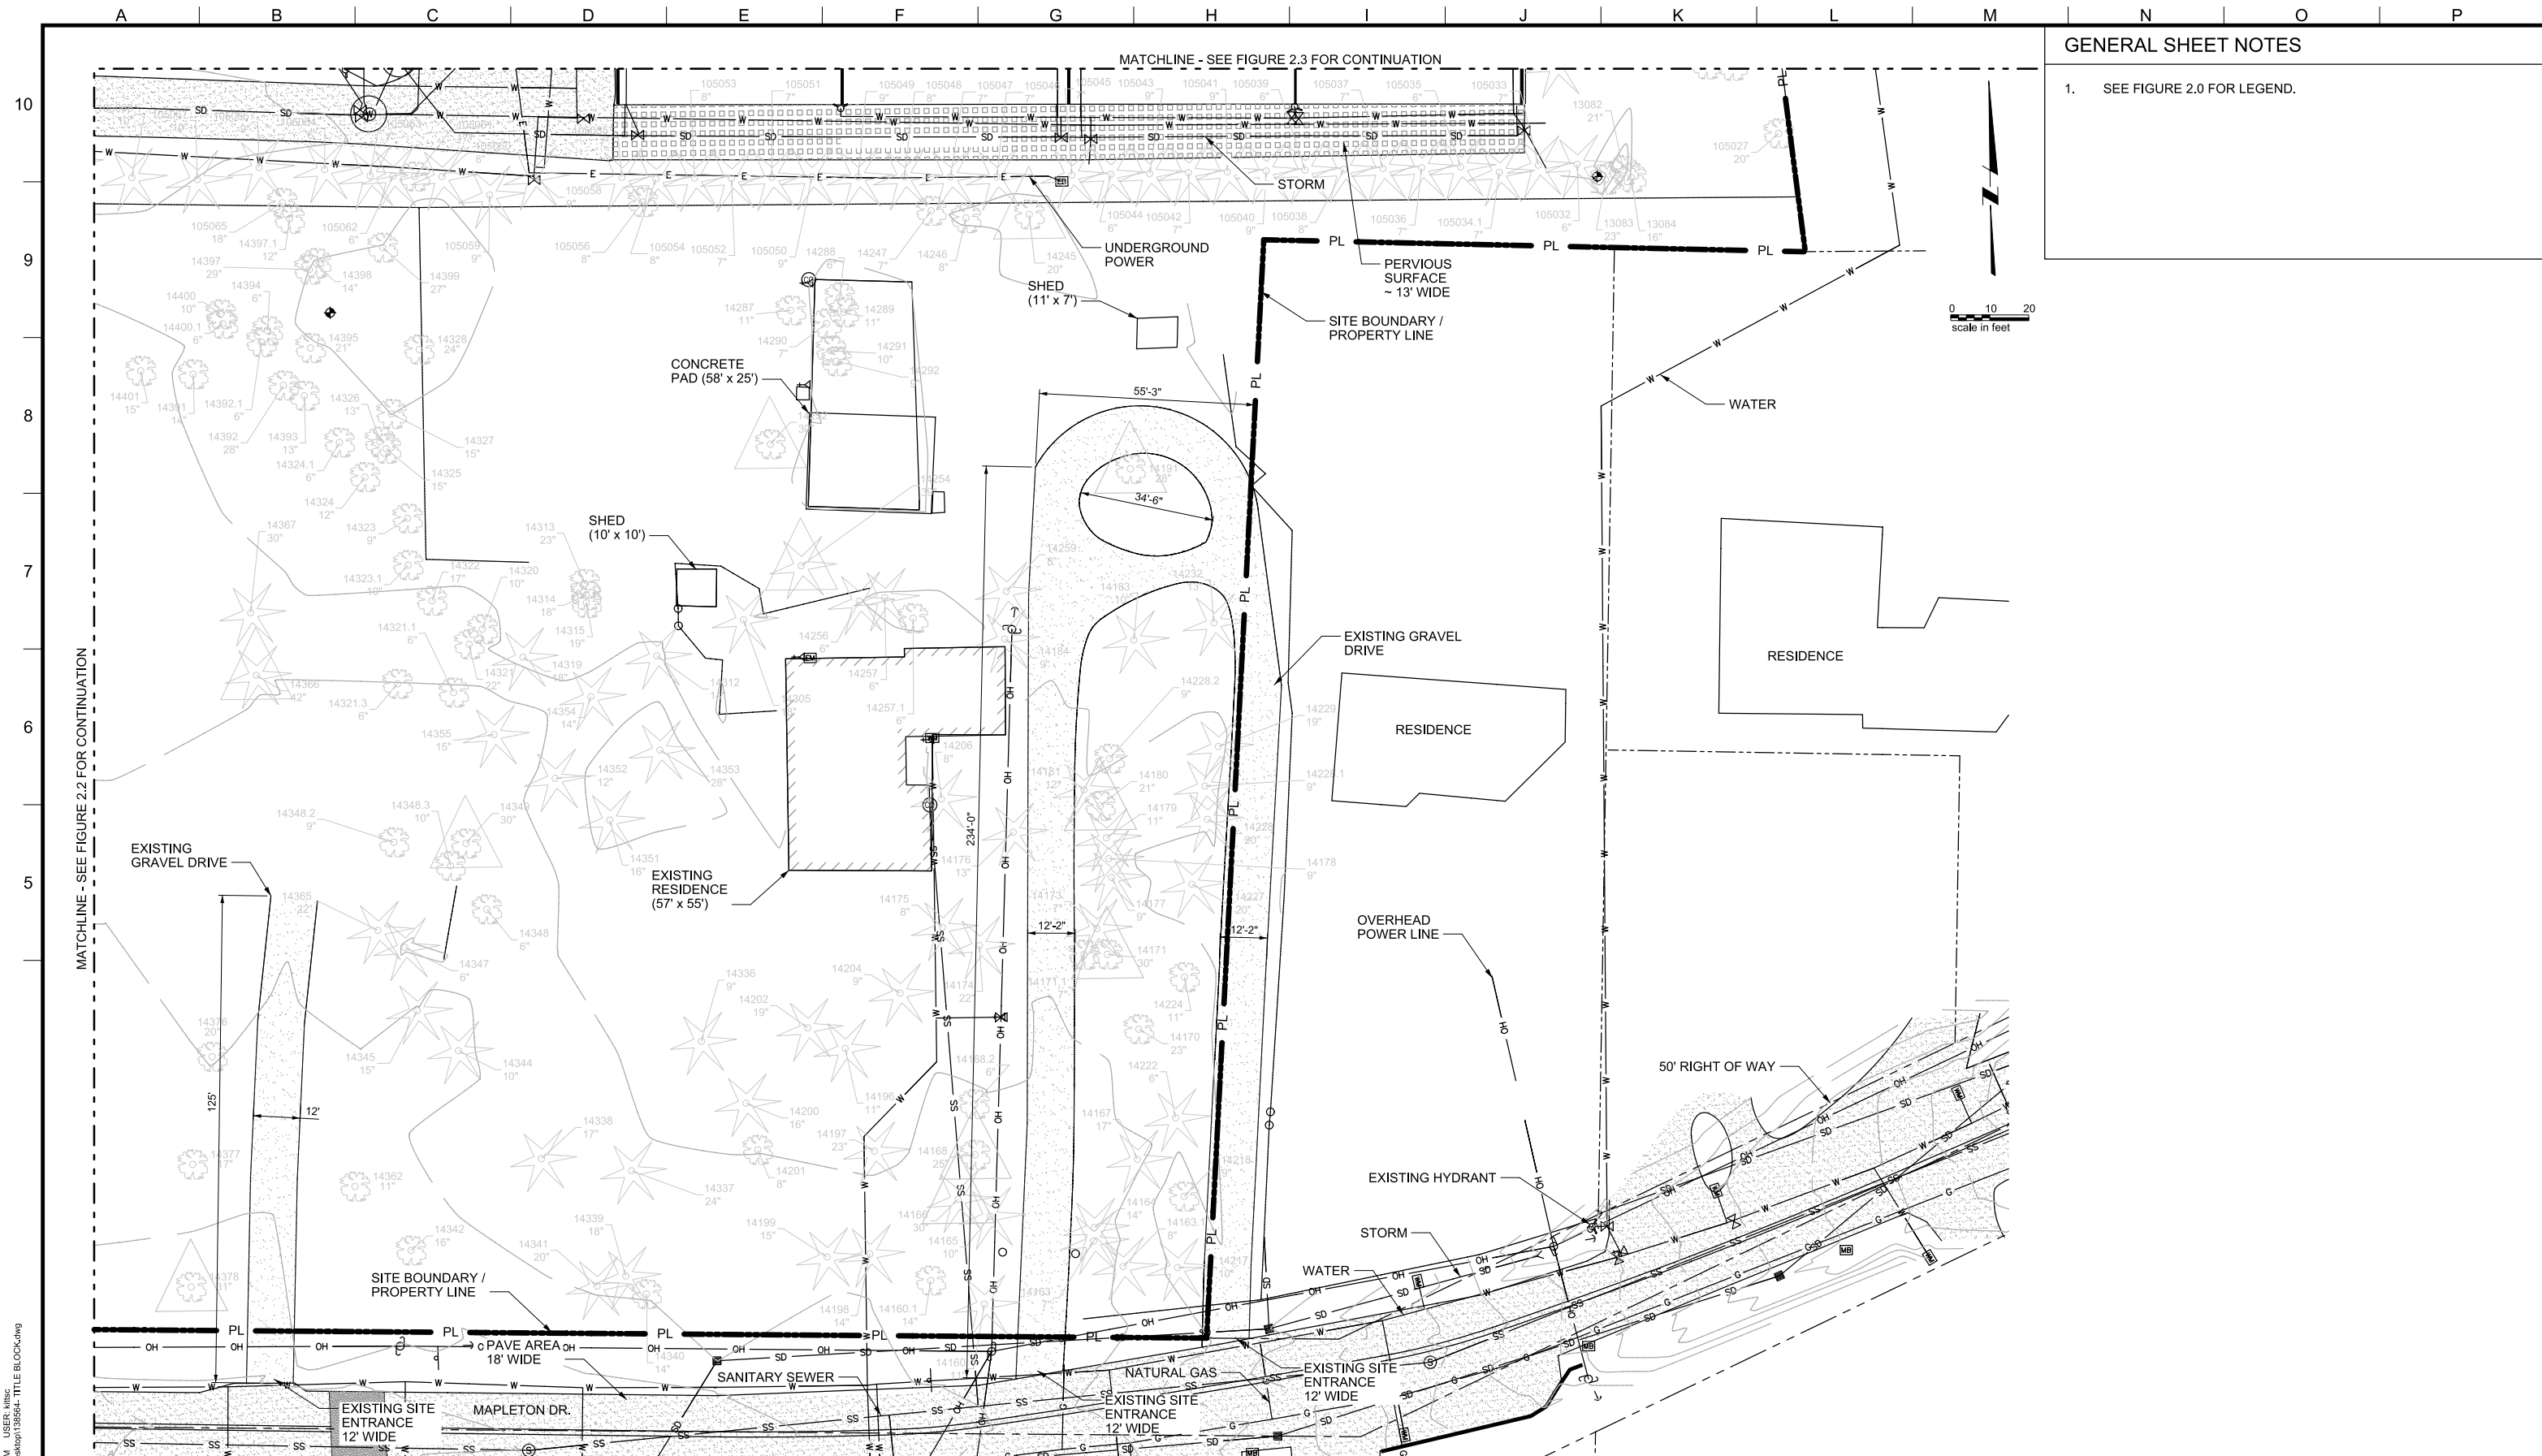
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LAKE OSWEGO AND TIGARD WATER TREATMENT PLANT  
DESIGN REVIEW AND CONDITIONAL USE  
SITE ANALYSIS - EXISTING SITE  
AREA C


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PROJECT NUMBER	
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**GENERAL SHEET NOTES**

1. SEE FIGURE 2.0 FOR LEGEND.



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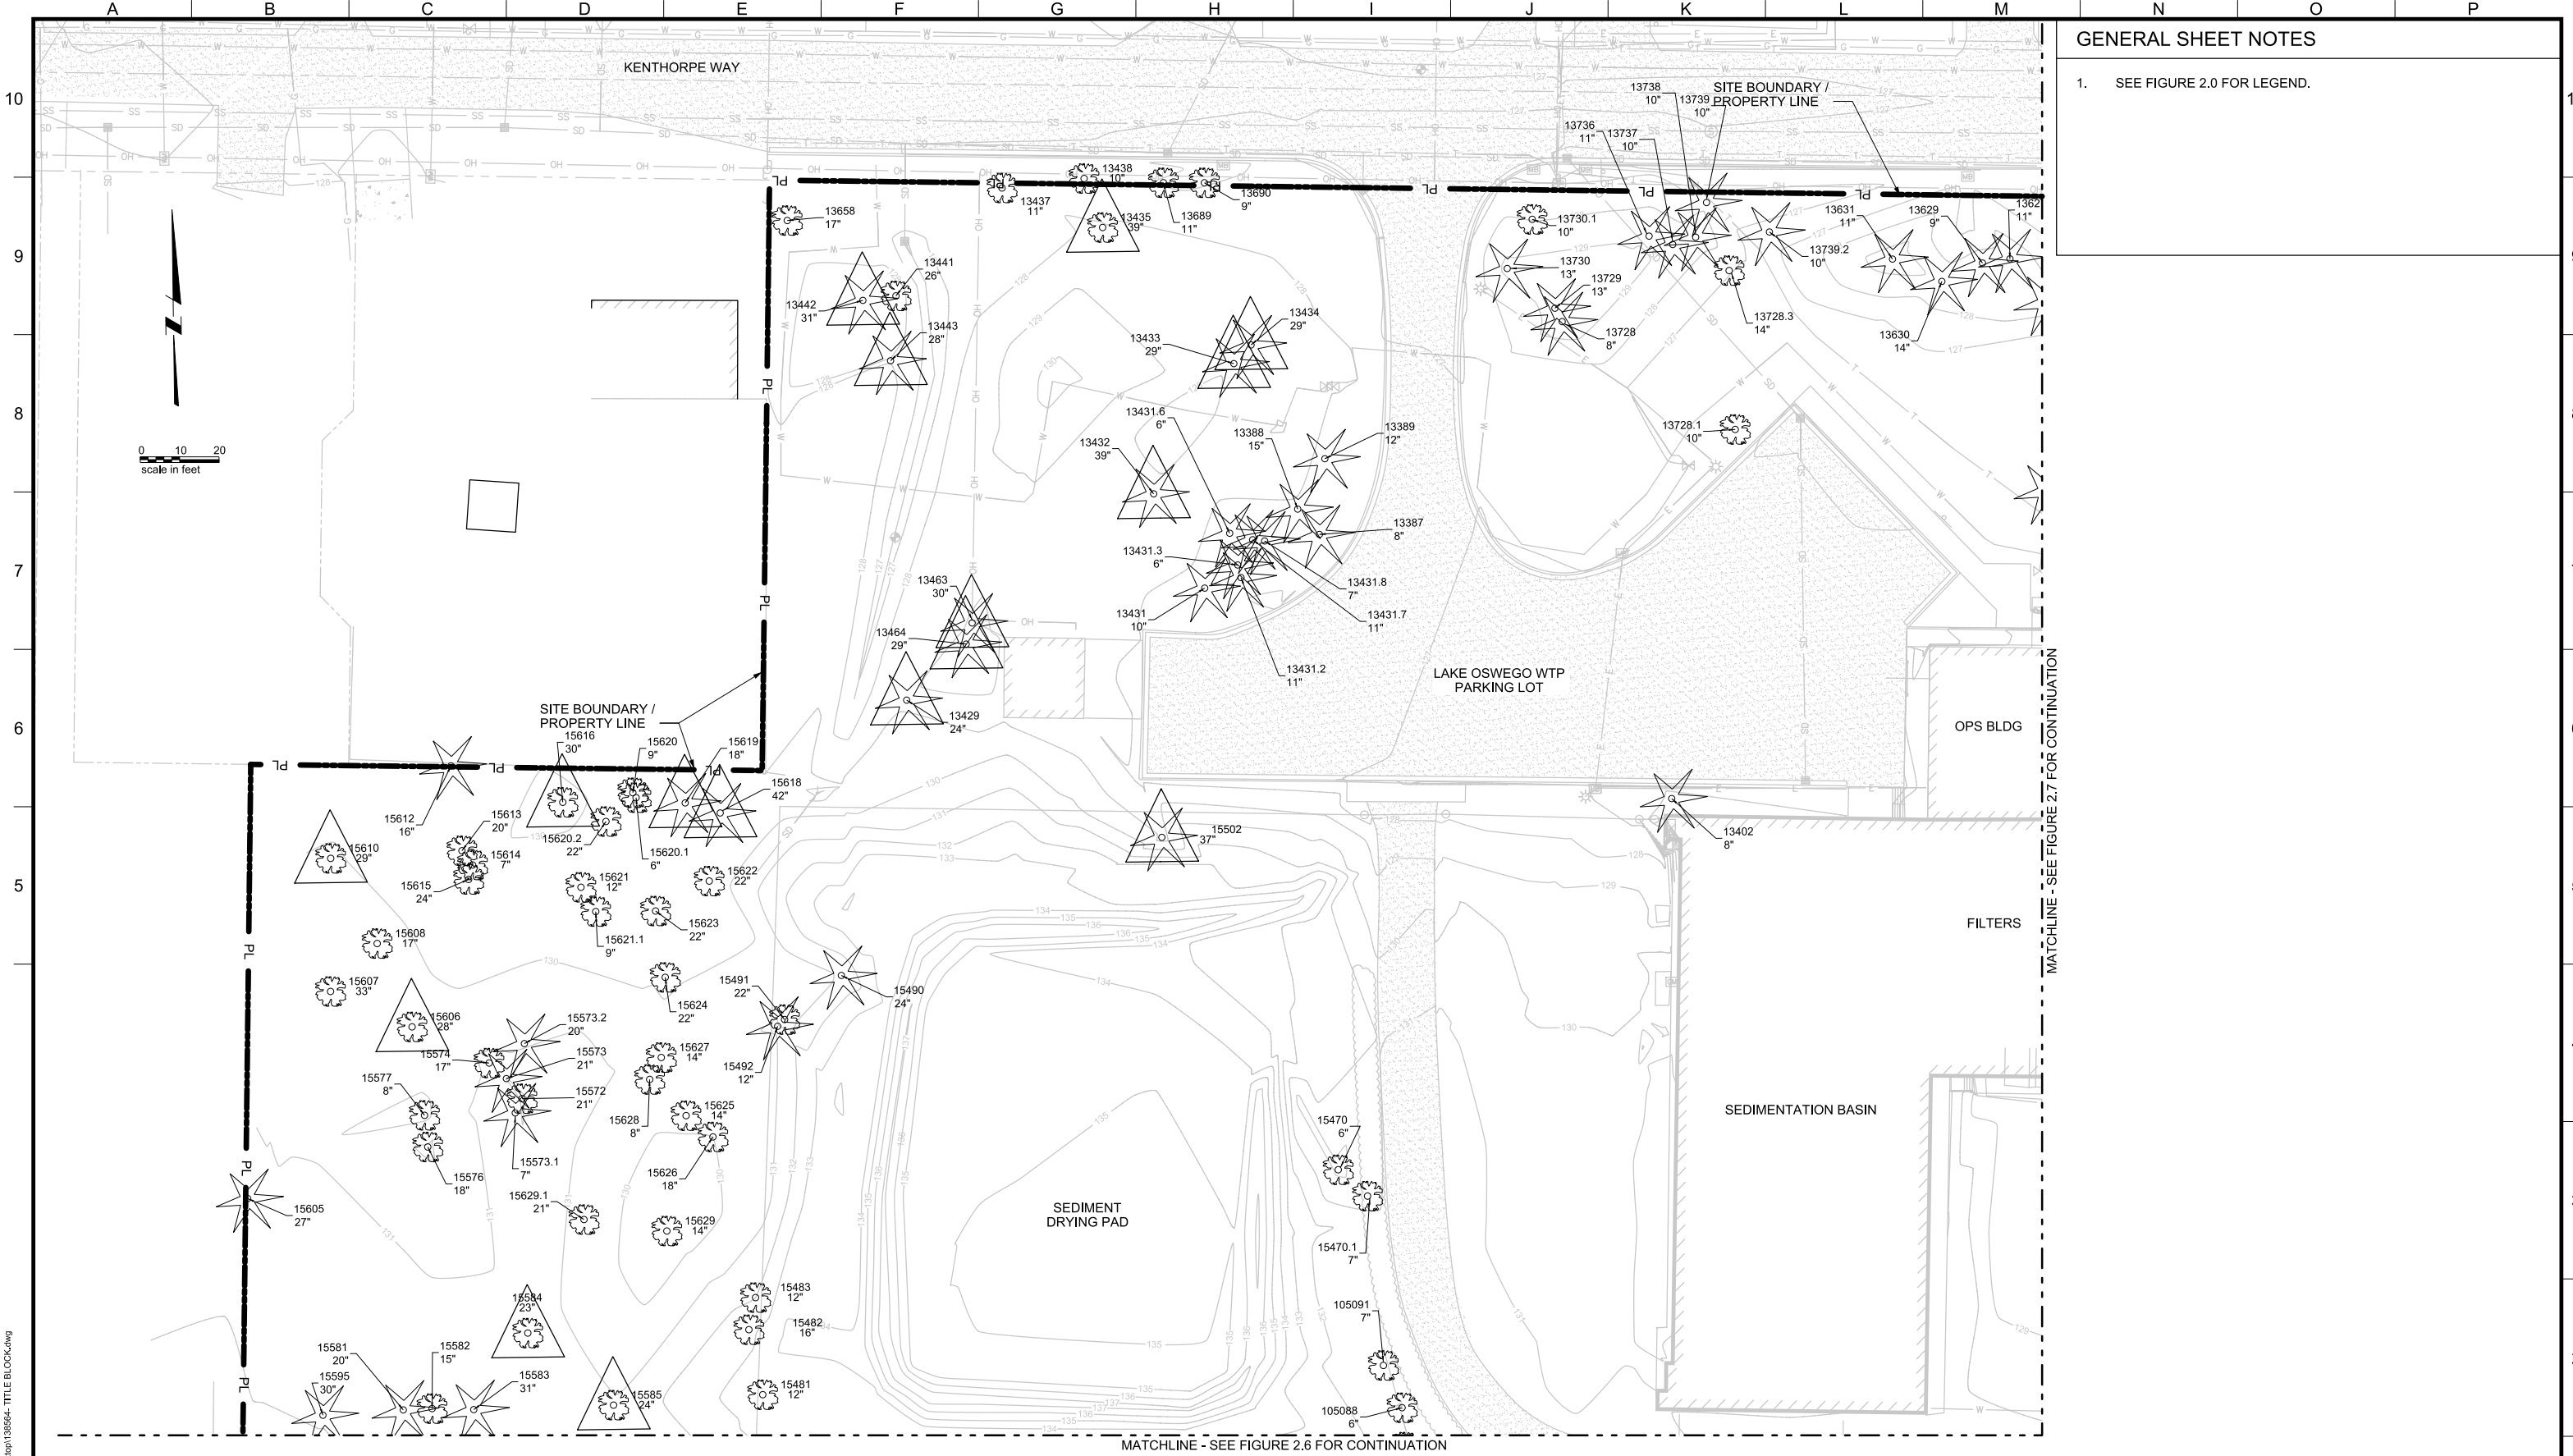
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LAKE OSWEGO AND TIGARD WATER TREATMENT PLANT  
 DESIGN REVIEW AND CONDITIONAL USE  
**SITE ANALYSIS - EXISTING SITE**  
 AREA D


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SCALE	1" = 20'
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**GENERAL SHEET NOTES**

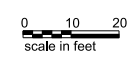1. SEE FIGURE 2.0 FOR LEGEND.



MATCHLINE - SEE FIGURE 2.7 FOR CONTINUATION

MATCHLINE - SEE FIGURE 2.6 FOR CONTINUATION
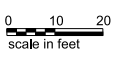
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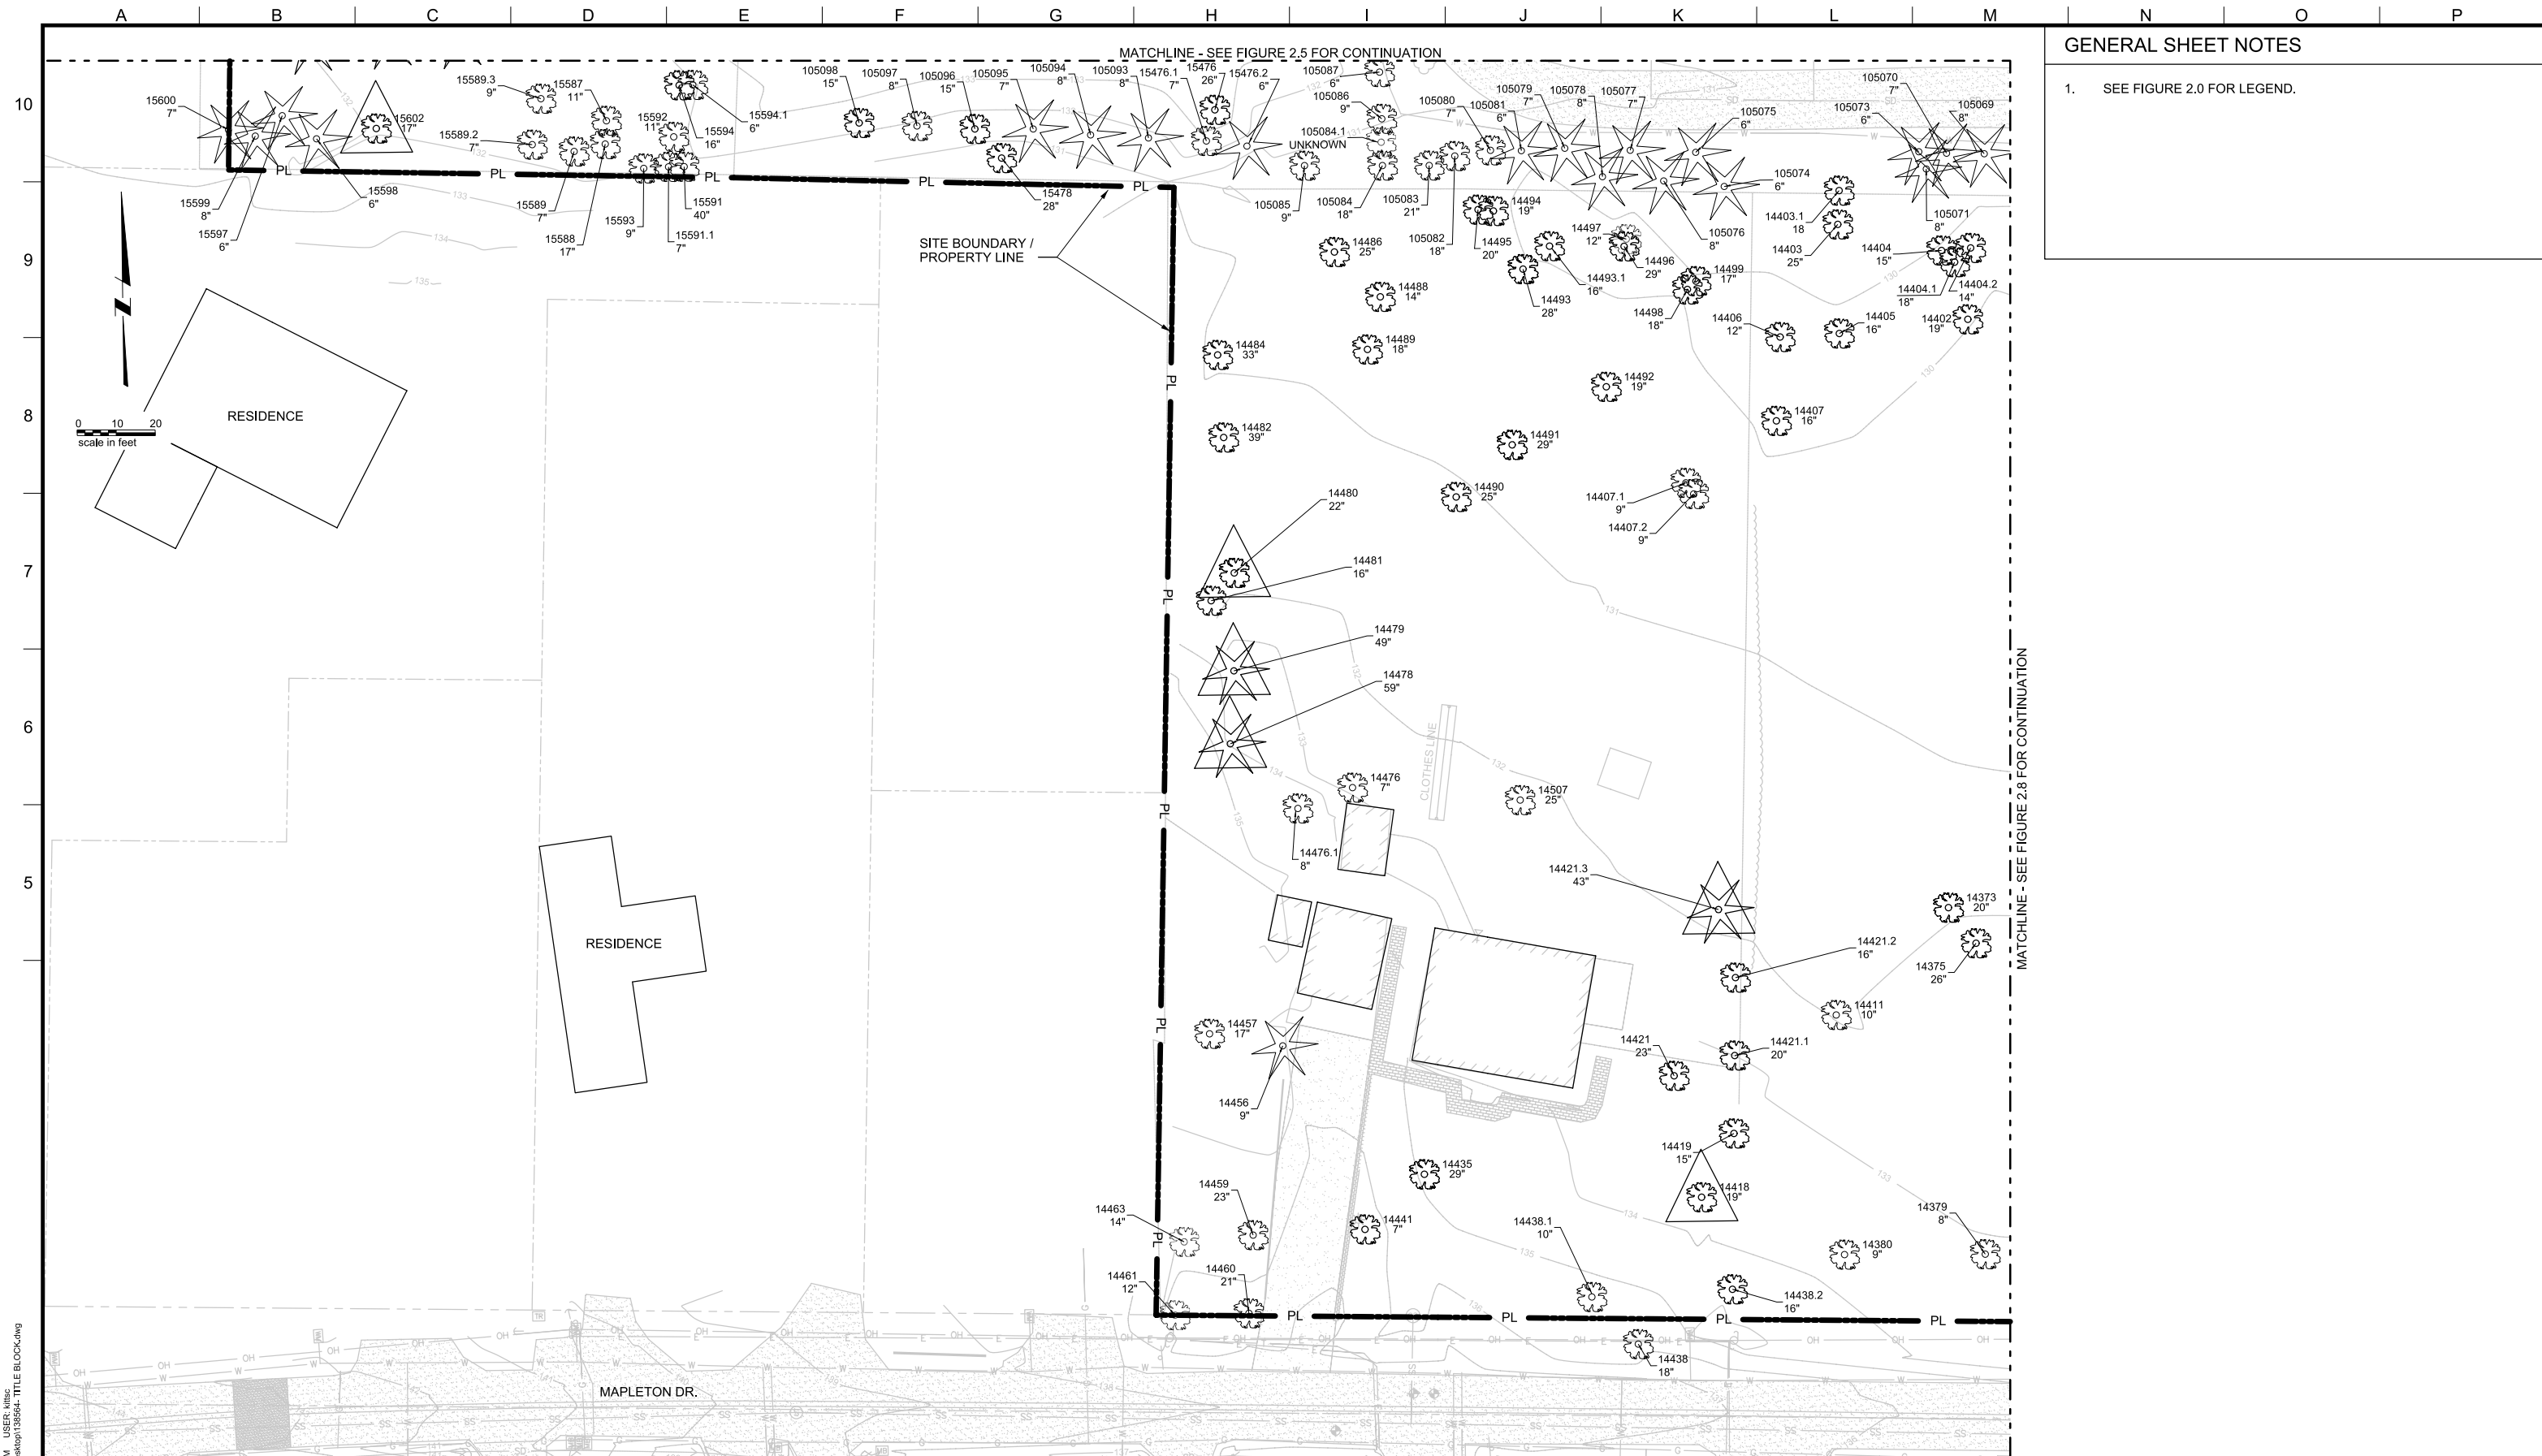
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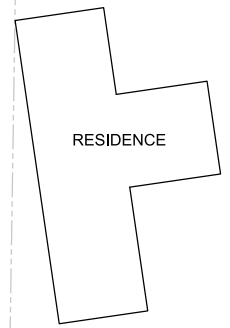
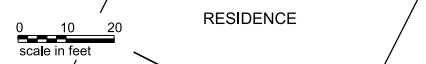
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DESIGN REVIEW AND CONDITIONAL USE  
**SITE ANALYSIS - EXISTING TREES  
AREA A**

FILENAME	
PROJECT NUMBER	
SCALE	1" = 20'
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**GENERAL SHEET NOTES**

1. SEE FIGURE 2.0 FOR LEGEND.



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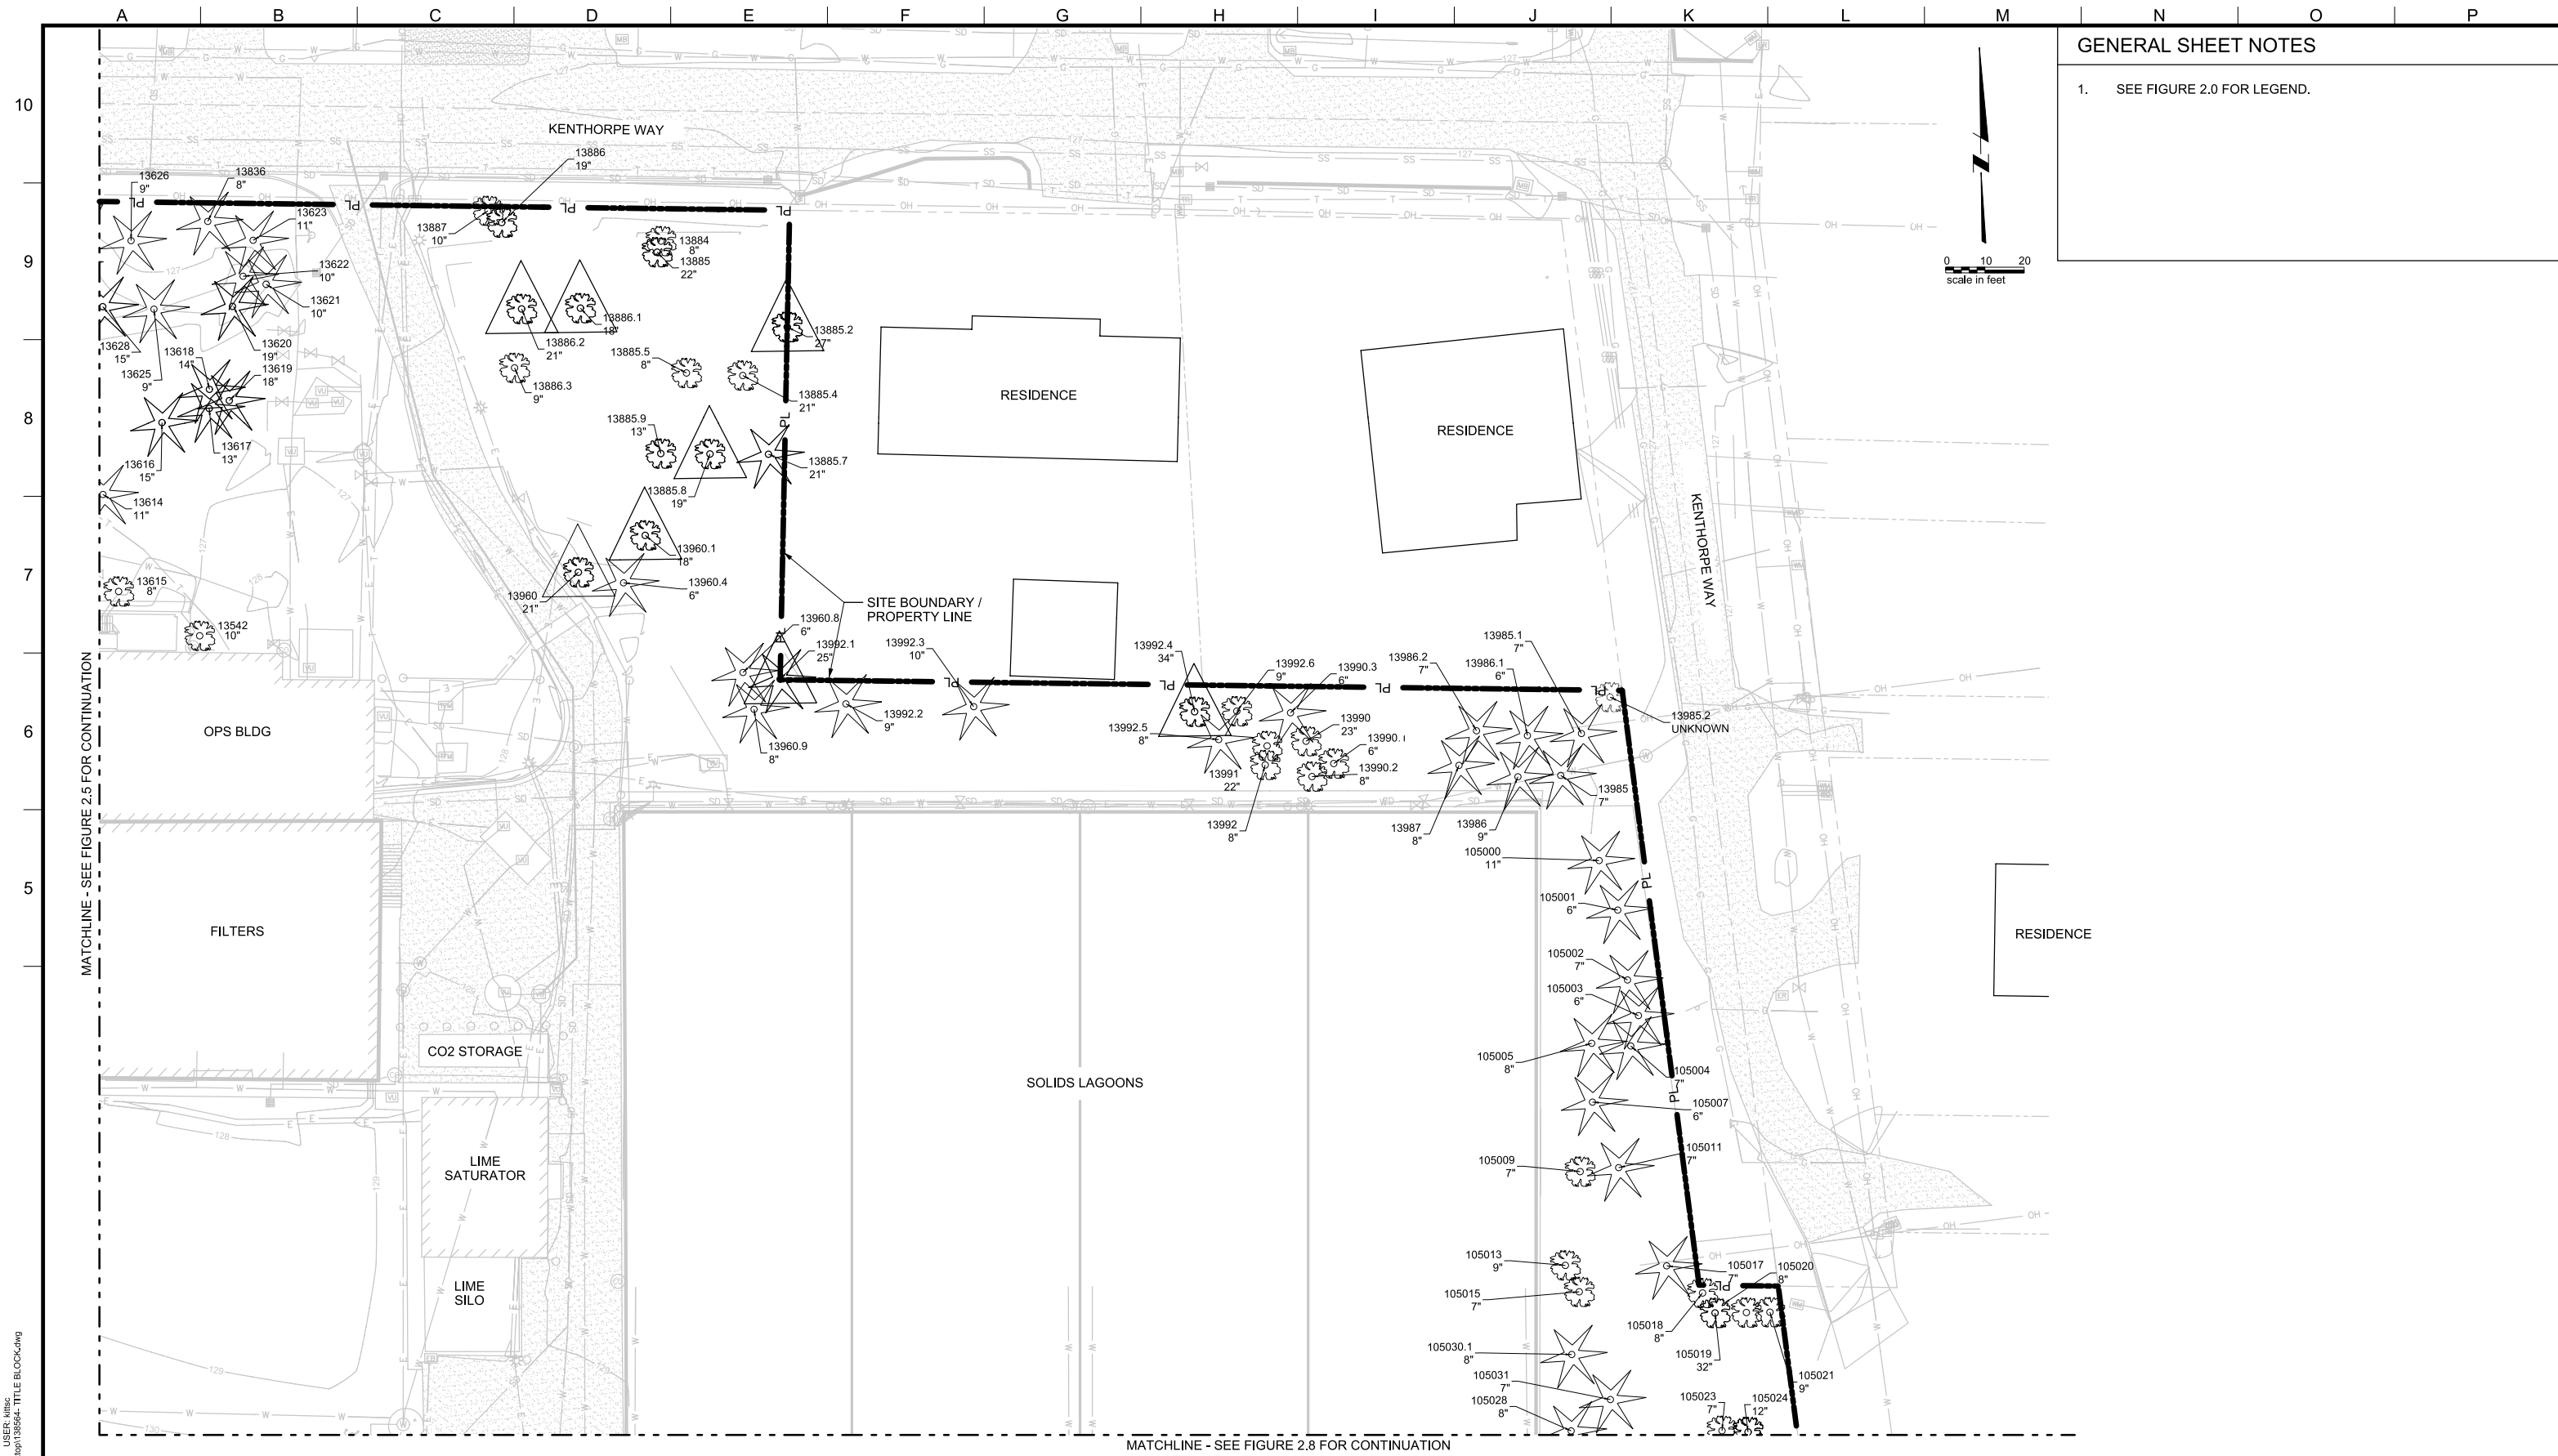
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LAKE OSWEGO AND TIGARD WATER TREATMENT PLANT  
 DESIGN REVIEW AND CONDITIONAL USE  
**SITE ANALYSIS - EXISTING TREES**  
 AREA B

FILENAME	
PROJECT NUMBER	
SCALE	1" = 20'
DRAWING/FIGURE NUMBER	2.6
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**GENERAL SHEET NOTES**

1. SEE FIGURE 2.0 FOR LEGEND.



MATCHLINE - SEE FIGURE 2.5 FOR CONTINUATION

MATCHLINE - SEE FIGURE 2.8 FOR CONTINUATION

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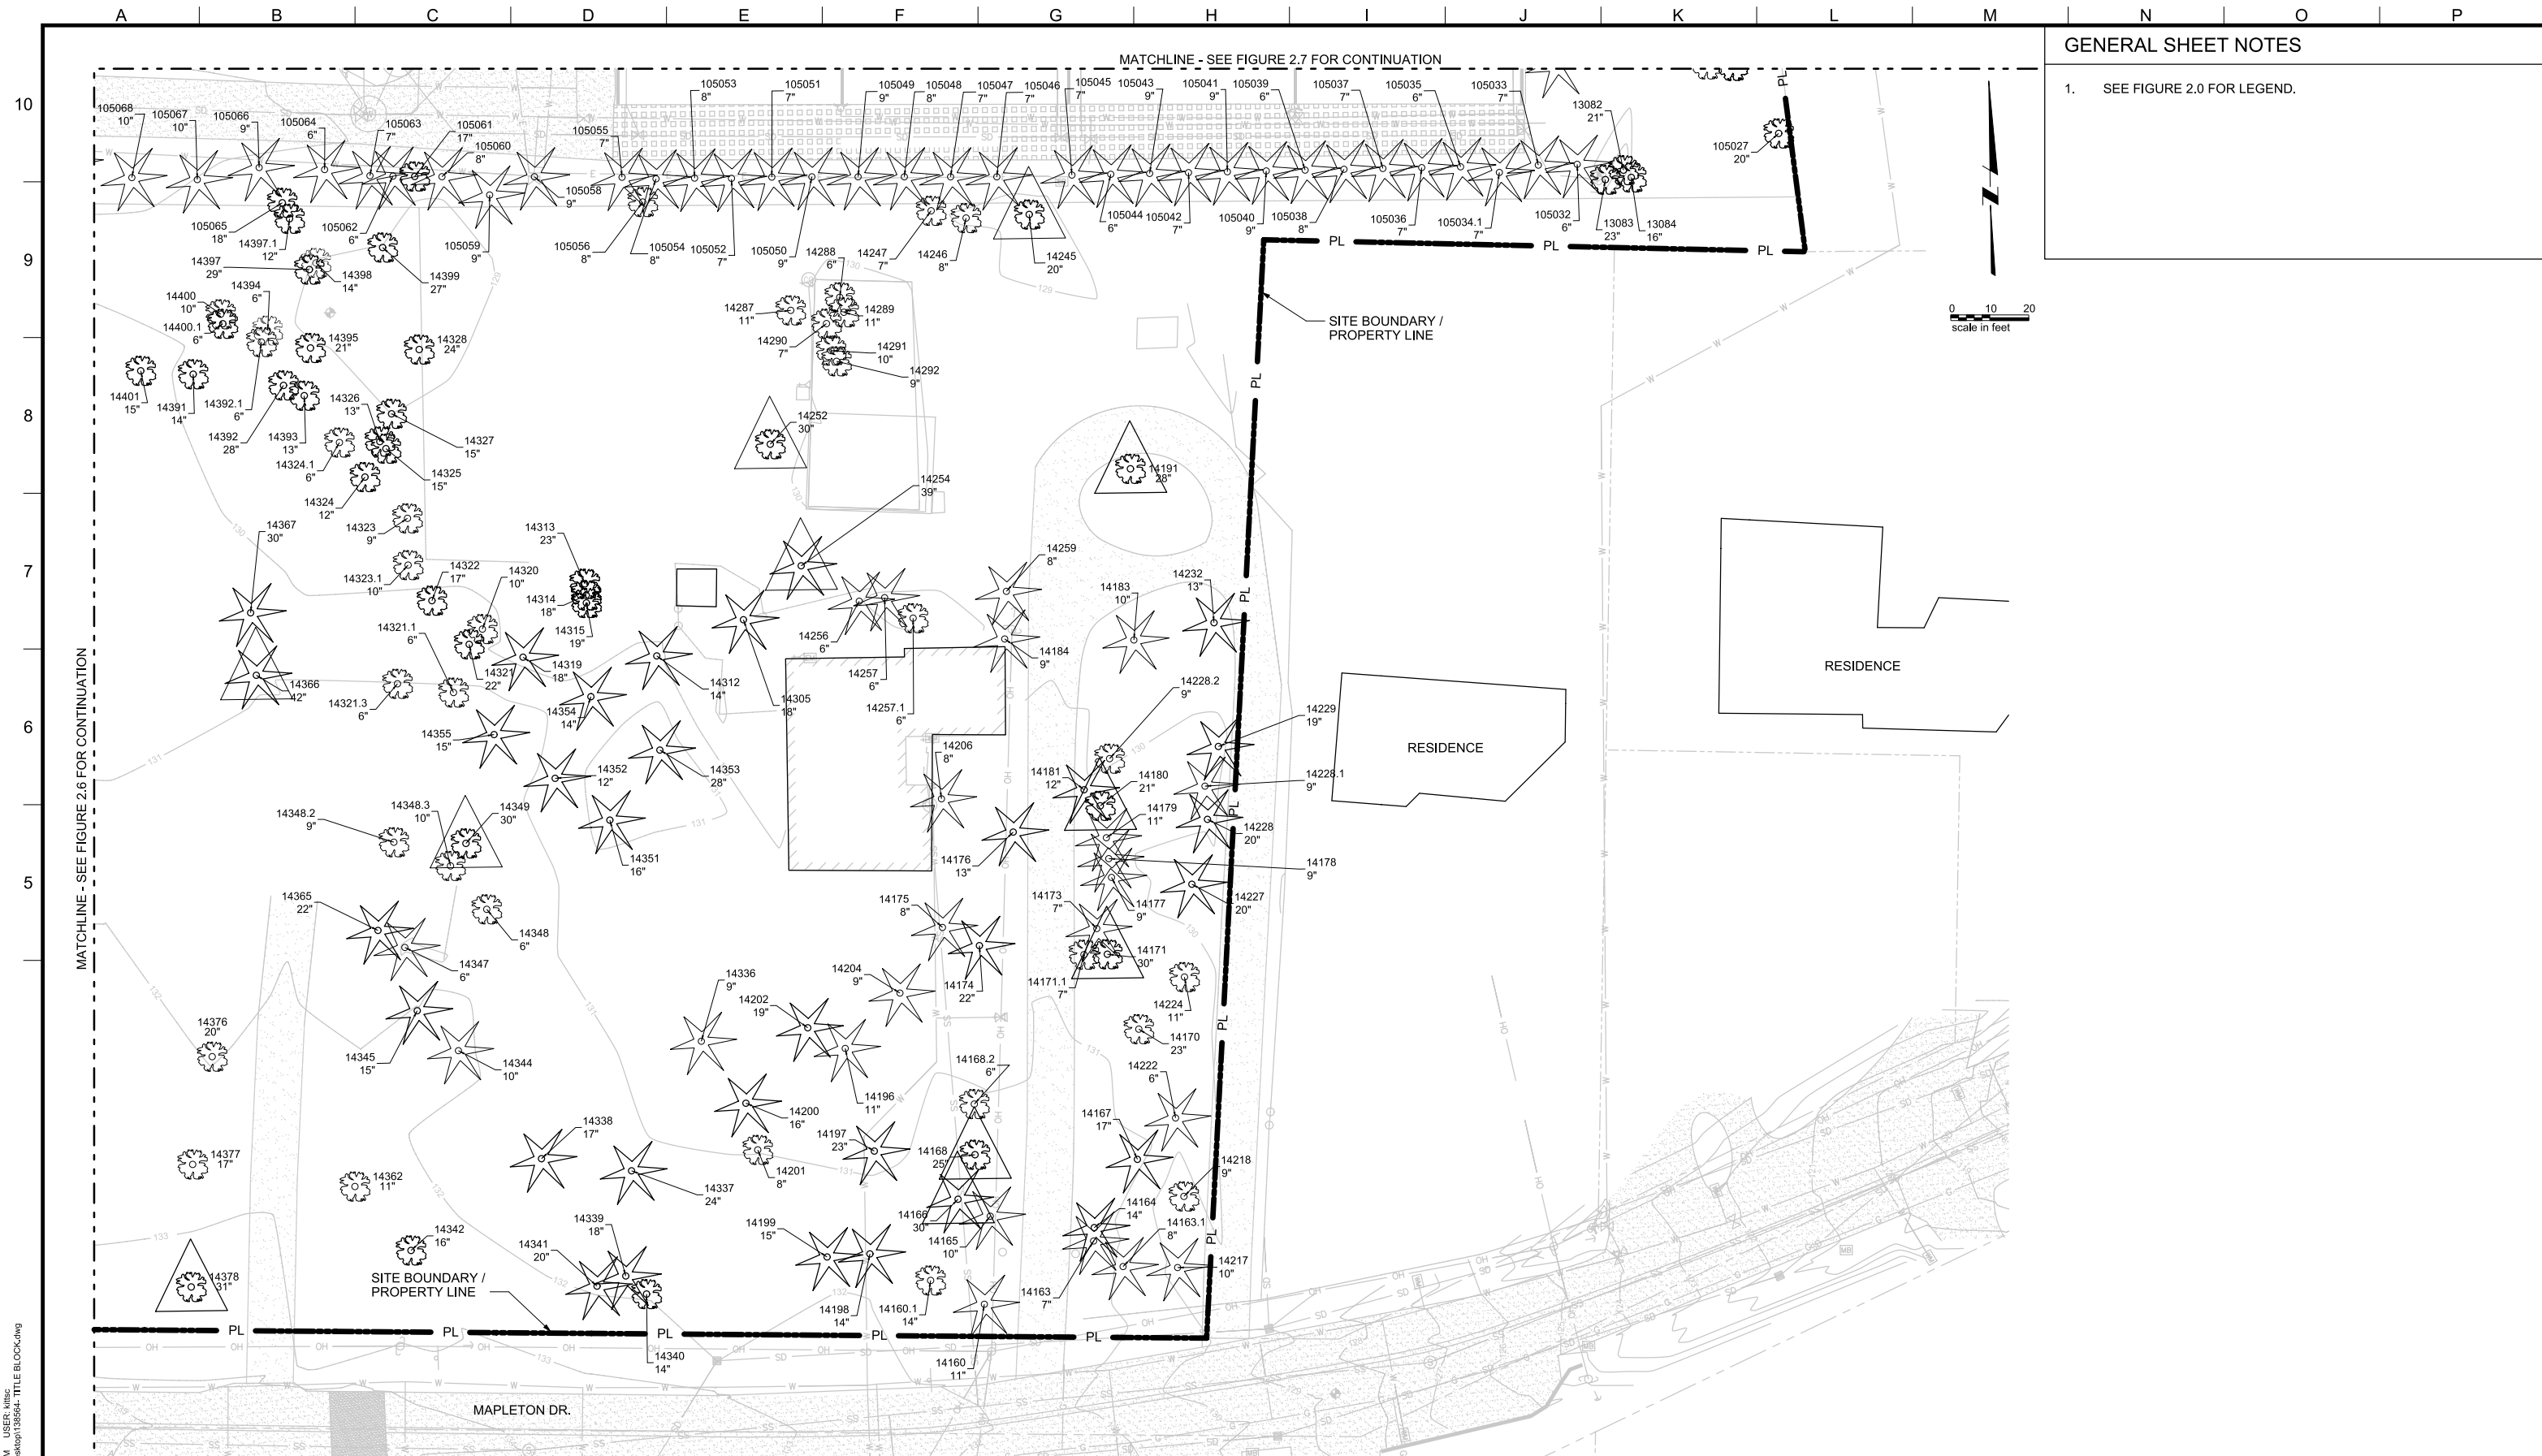
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 SITE ANALYSIS - EXISTING TREES  
 AREA C

FILENAME	
PROJECT NUMBER	
SCALE	1" = 20'
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**GENERAL SHEET NOTES**

1. SEE FIGURE 2.0 FOR LEGEND.

MATCHLINE - SEE FIGURE 2.6 FOR CONTINUATION

MATCHLINE - SEE FIGURE 2.7 FOR CONTINUATION



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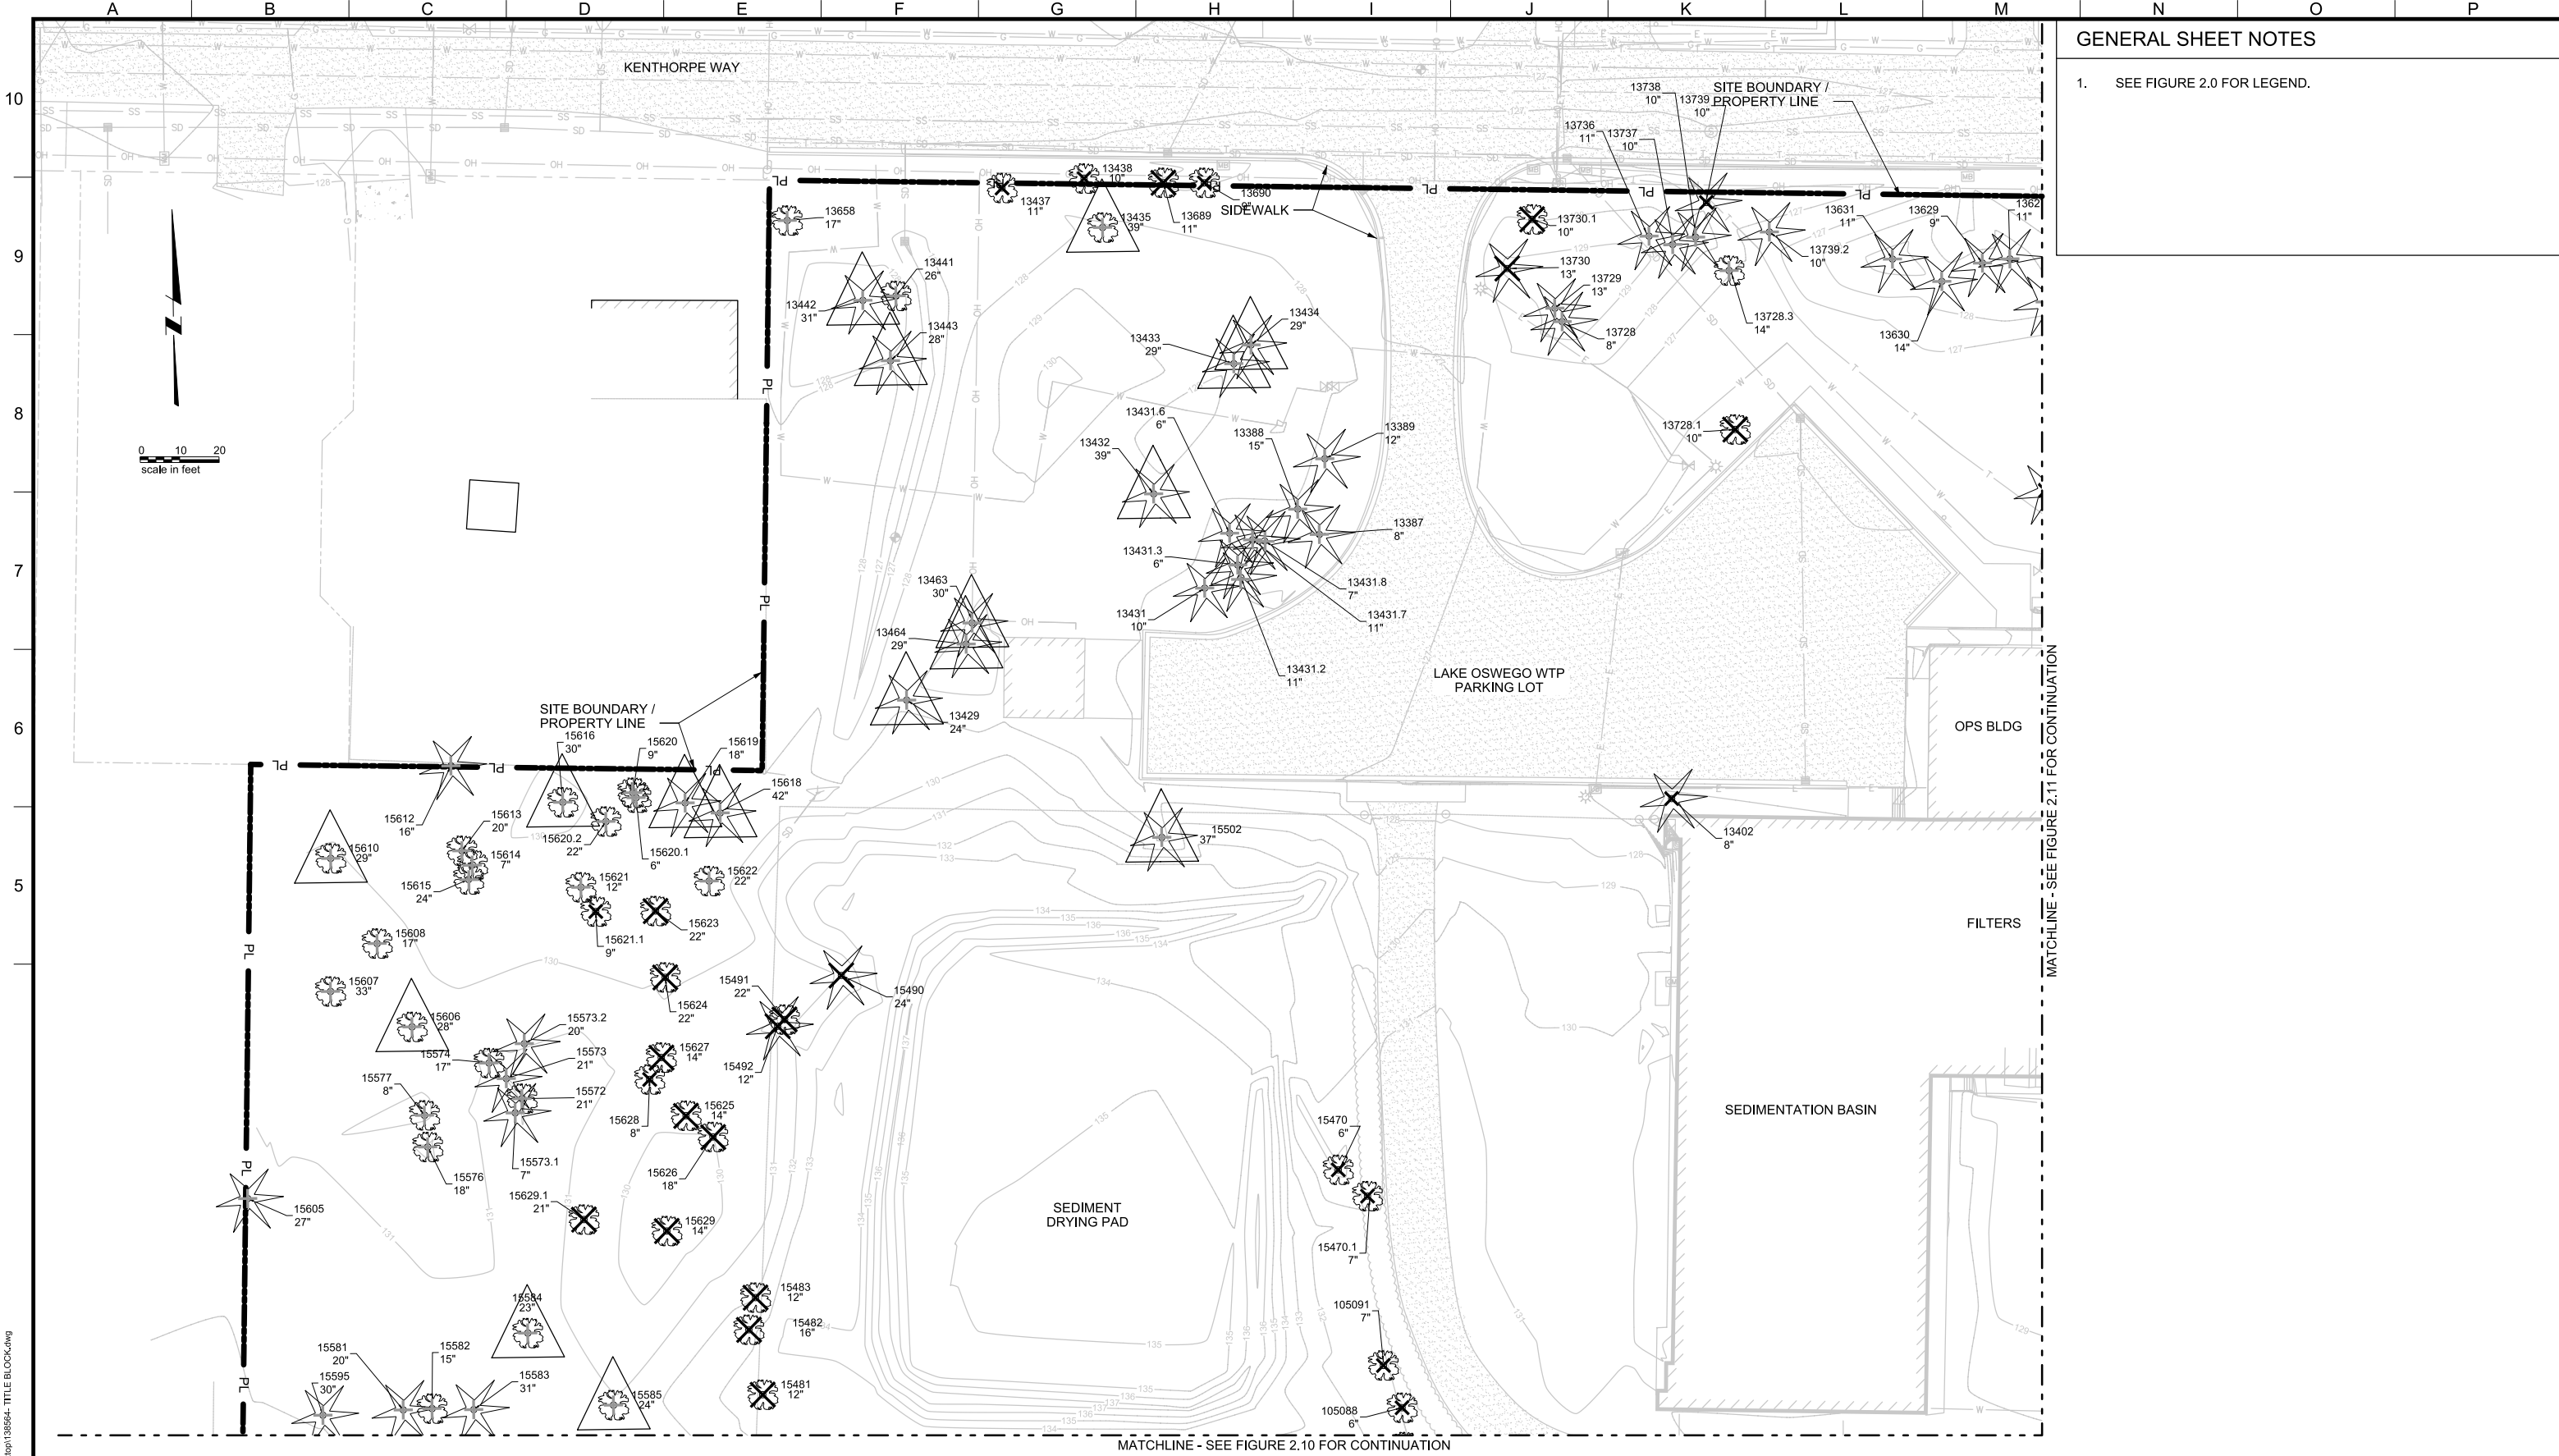
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DESIGN REVIEW AND CONDITIONAL USE  
SITE ANALYSIS - EXISTING TREES  
AREA D

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**GENERAL SHEET NOTES**

- SEE FIGURE 2.0 FOR LEGEND.

MATCHLINE - SEE FIGURE 2.11 FOR CONTINUATION

MATCHLINE - SEE FIGURE 2.10 FOR CONTINUATION



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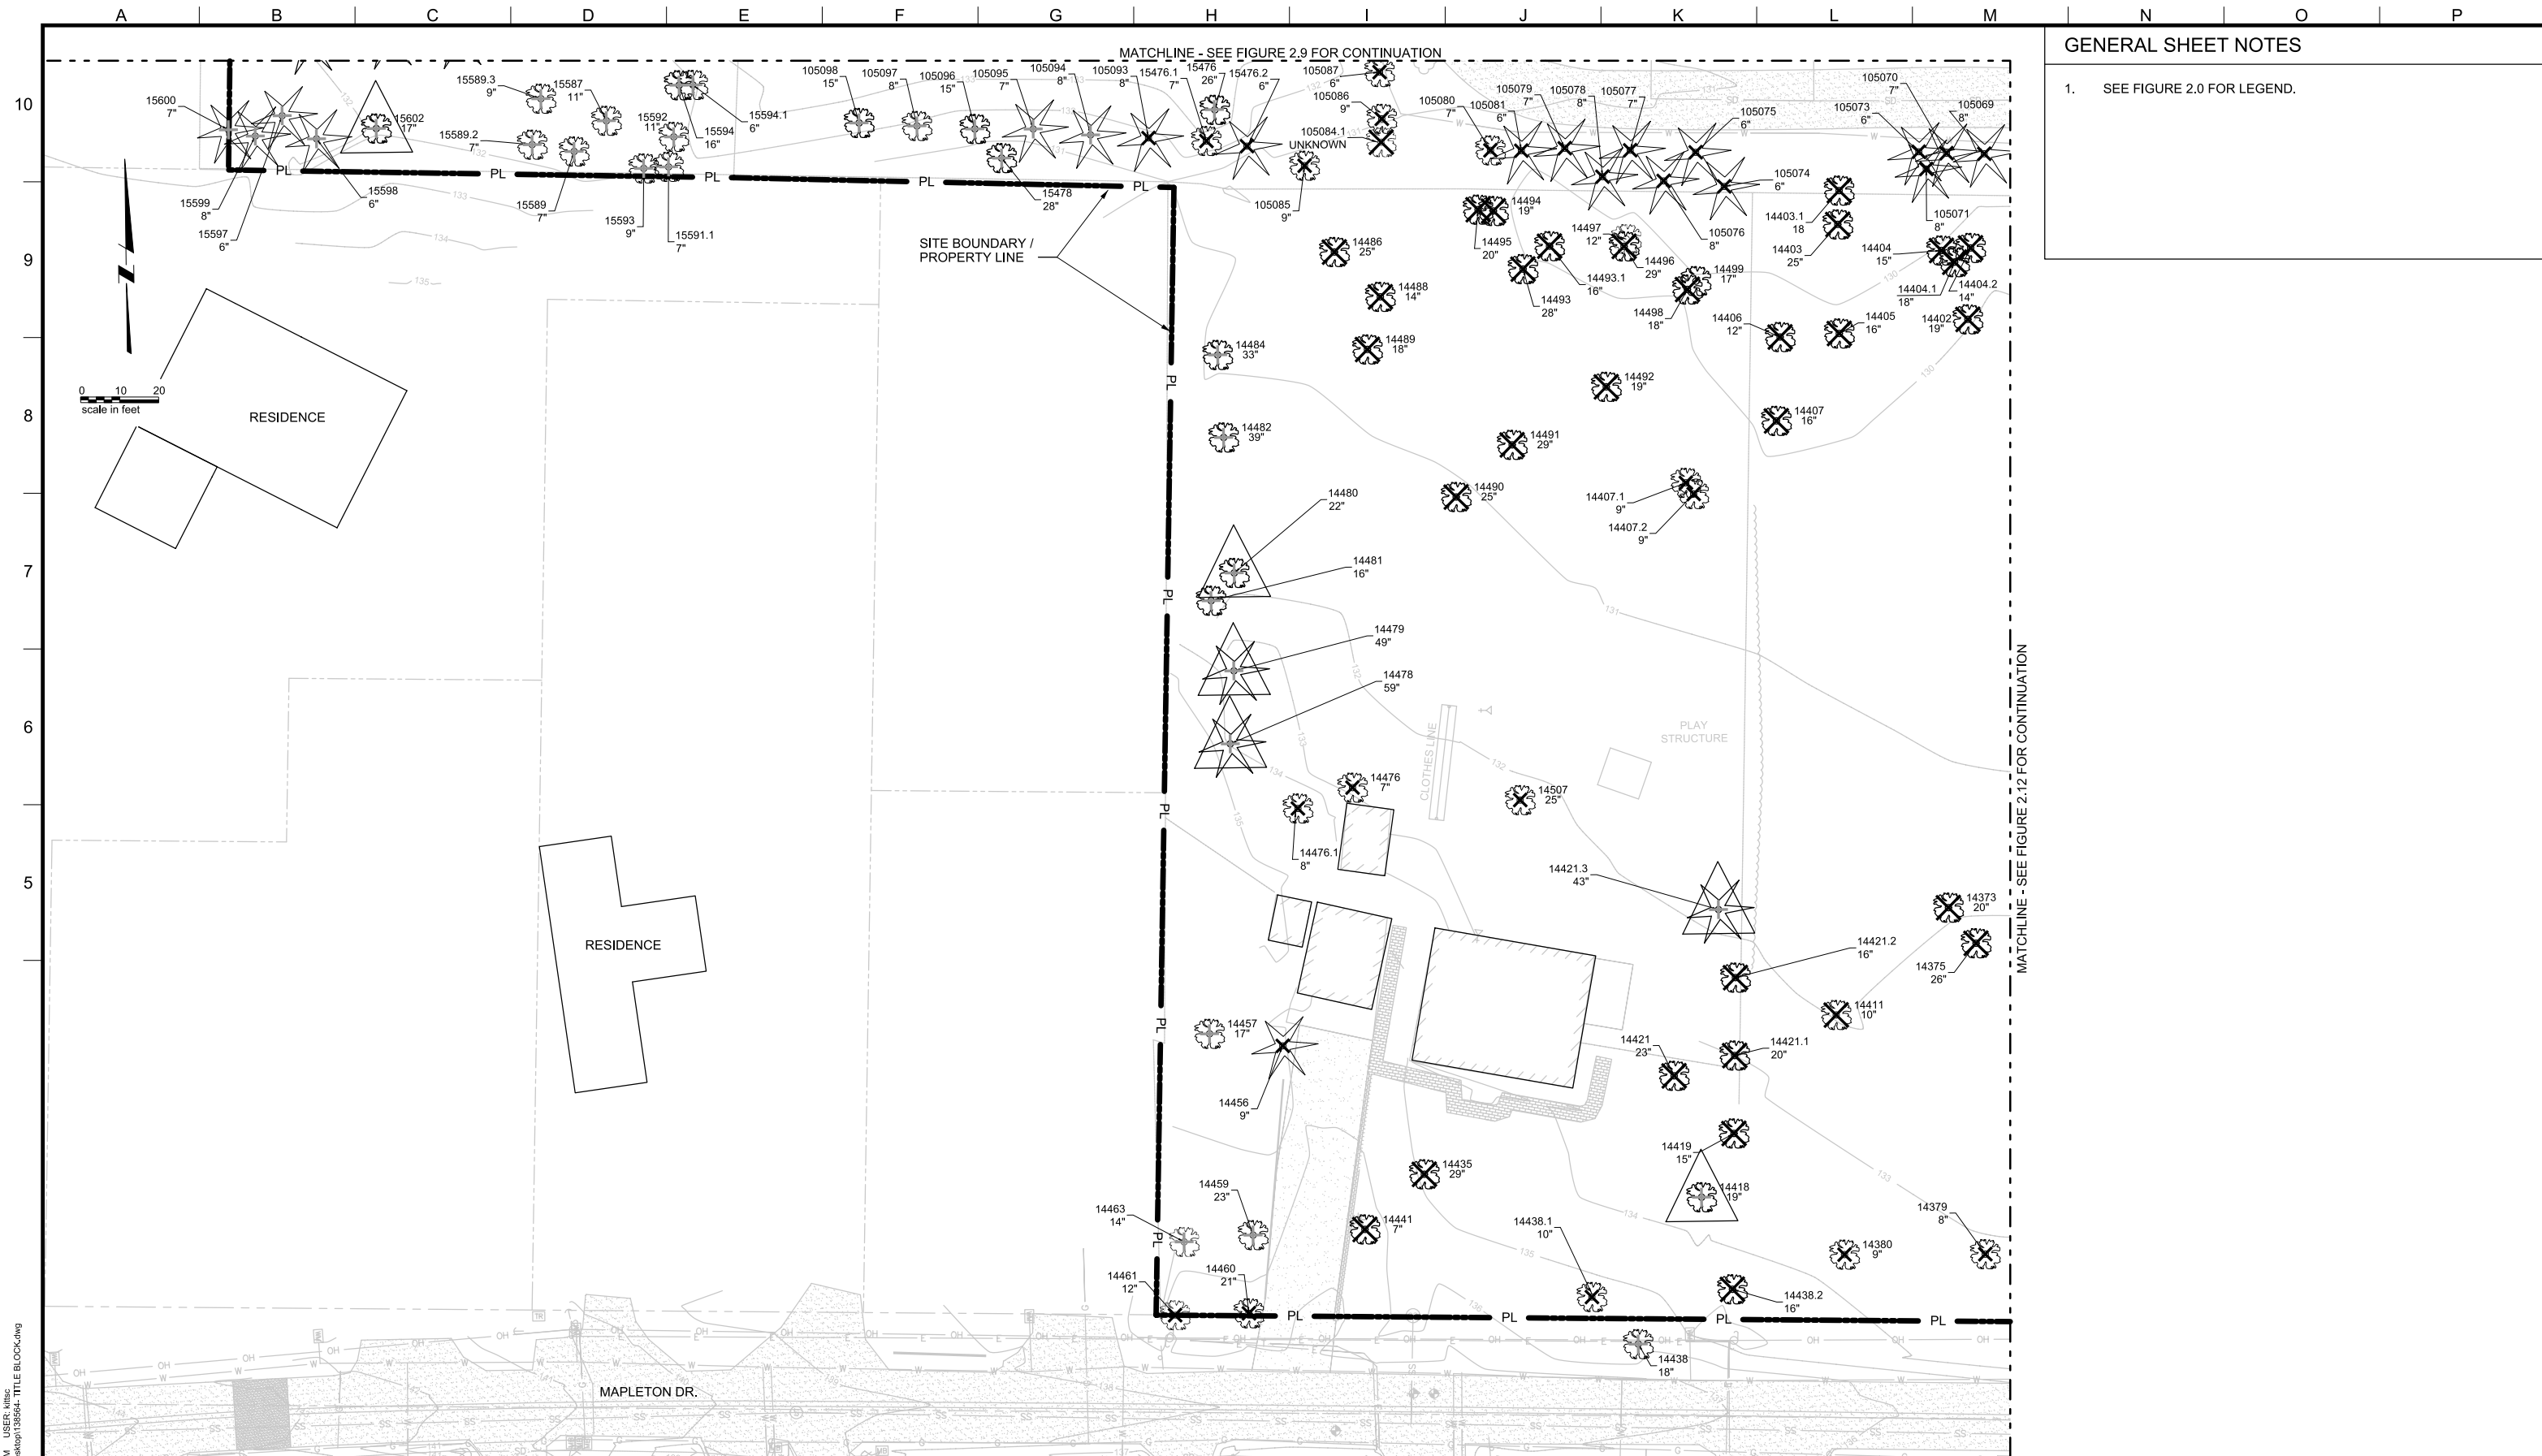
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**SITE ANALYSIS - EXISTING TREE REMOVAL**  
AREA A


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**GENERAL SHEET NOTES**

1. SEE FIGURE 2.0 FOR LEGEND.



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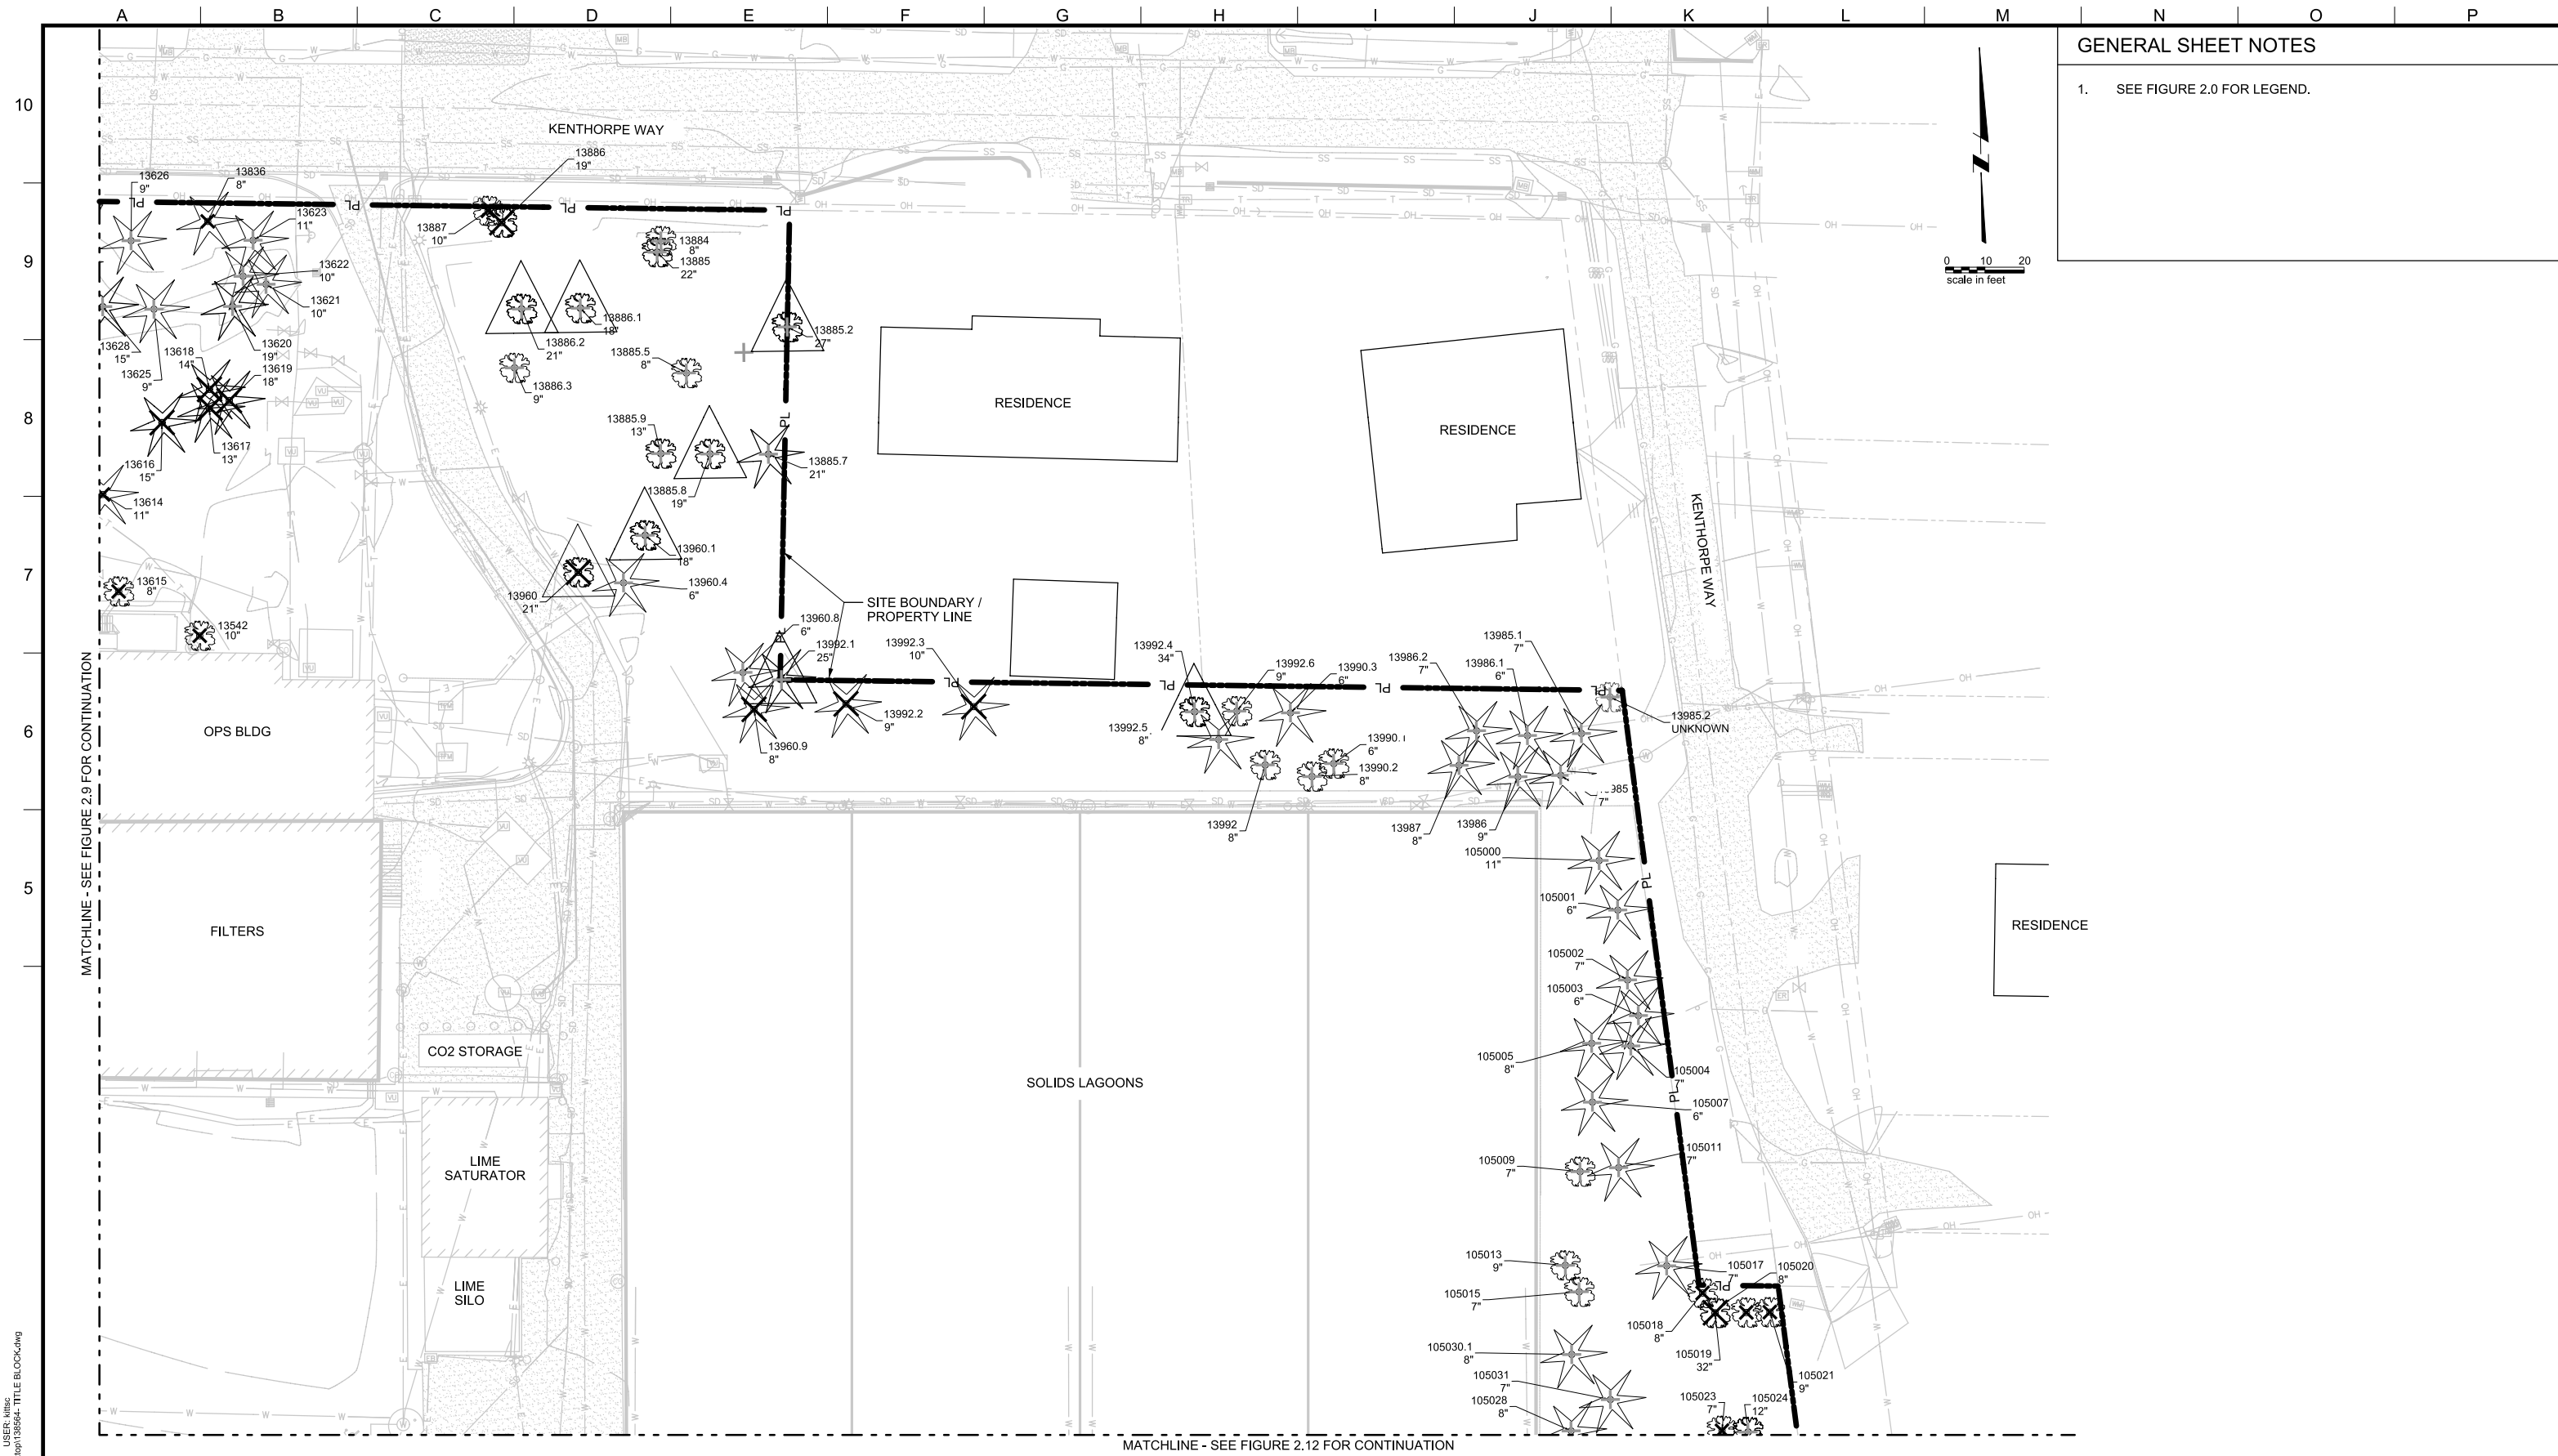
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REV.	DESCRIPTION	BY	DATE	APP.

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LAKE OSWEGO AND TIGARD WATER TREATMENT PLANT  
 DESIGN REVIEW AND CONDITIONAL USE  
**SITE ANALYSIS - EXISTING TREE REMOVAL  
 AREA B**

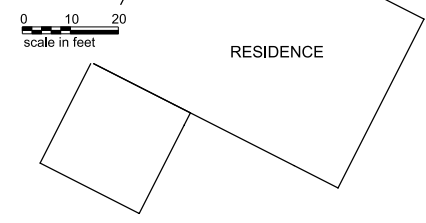FILENAME	
PROJECT NUMBER	
SCALE	1" = 20'
DRAWING/FIGURE NUMBER	2.10
#### OF	



**GENERAL SHEET NOTES**

1. SEE FIGURE 2.0 FOR LEGEND.

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LINE IS 2 INCHES  
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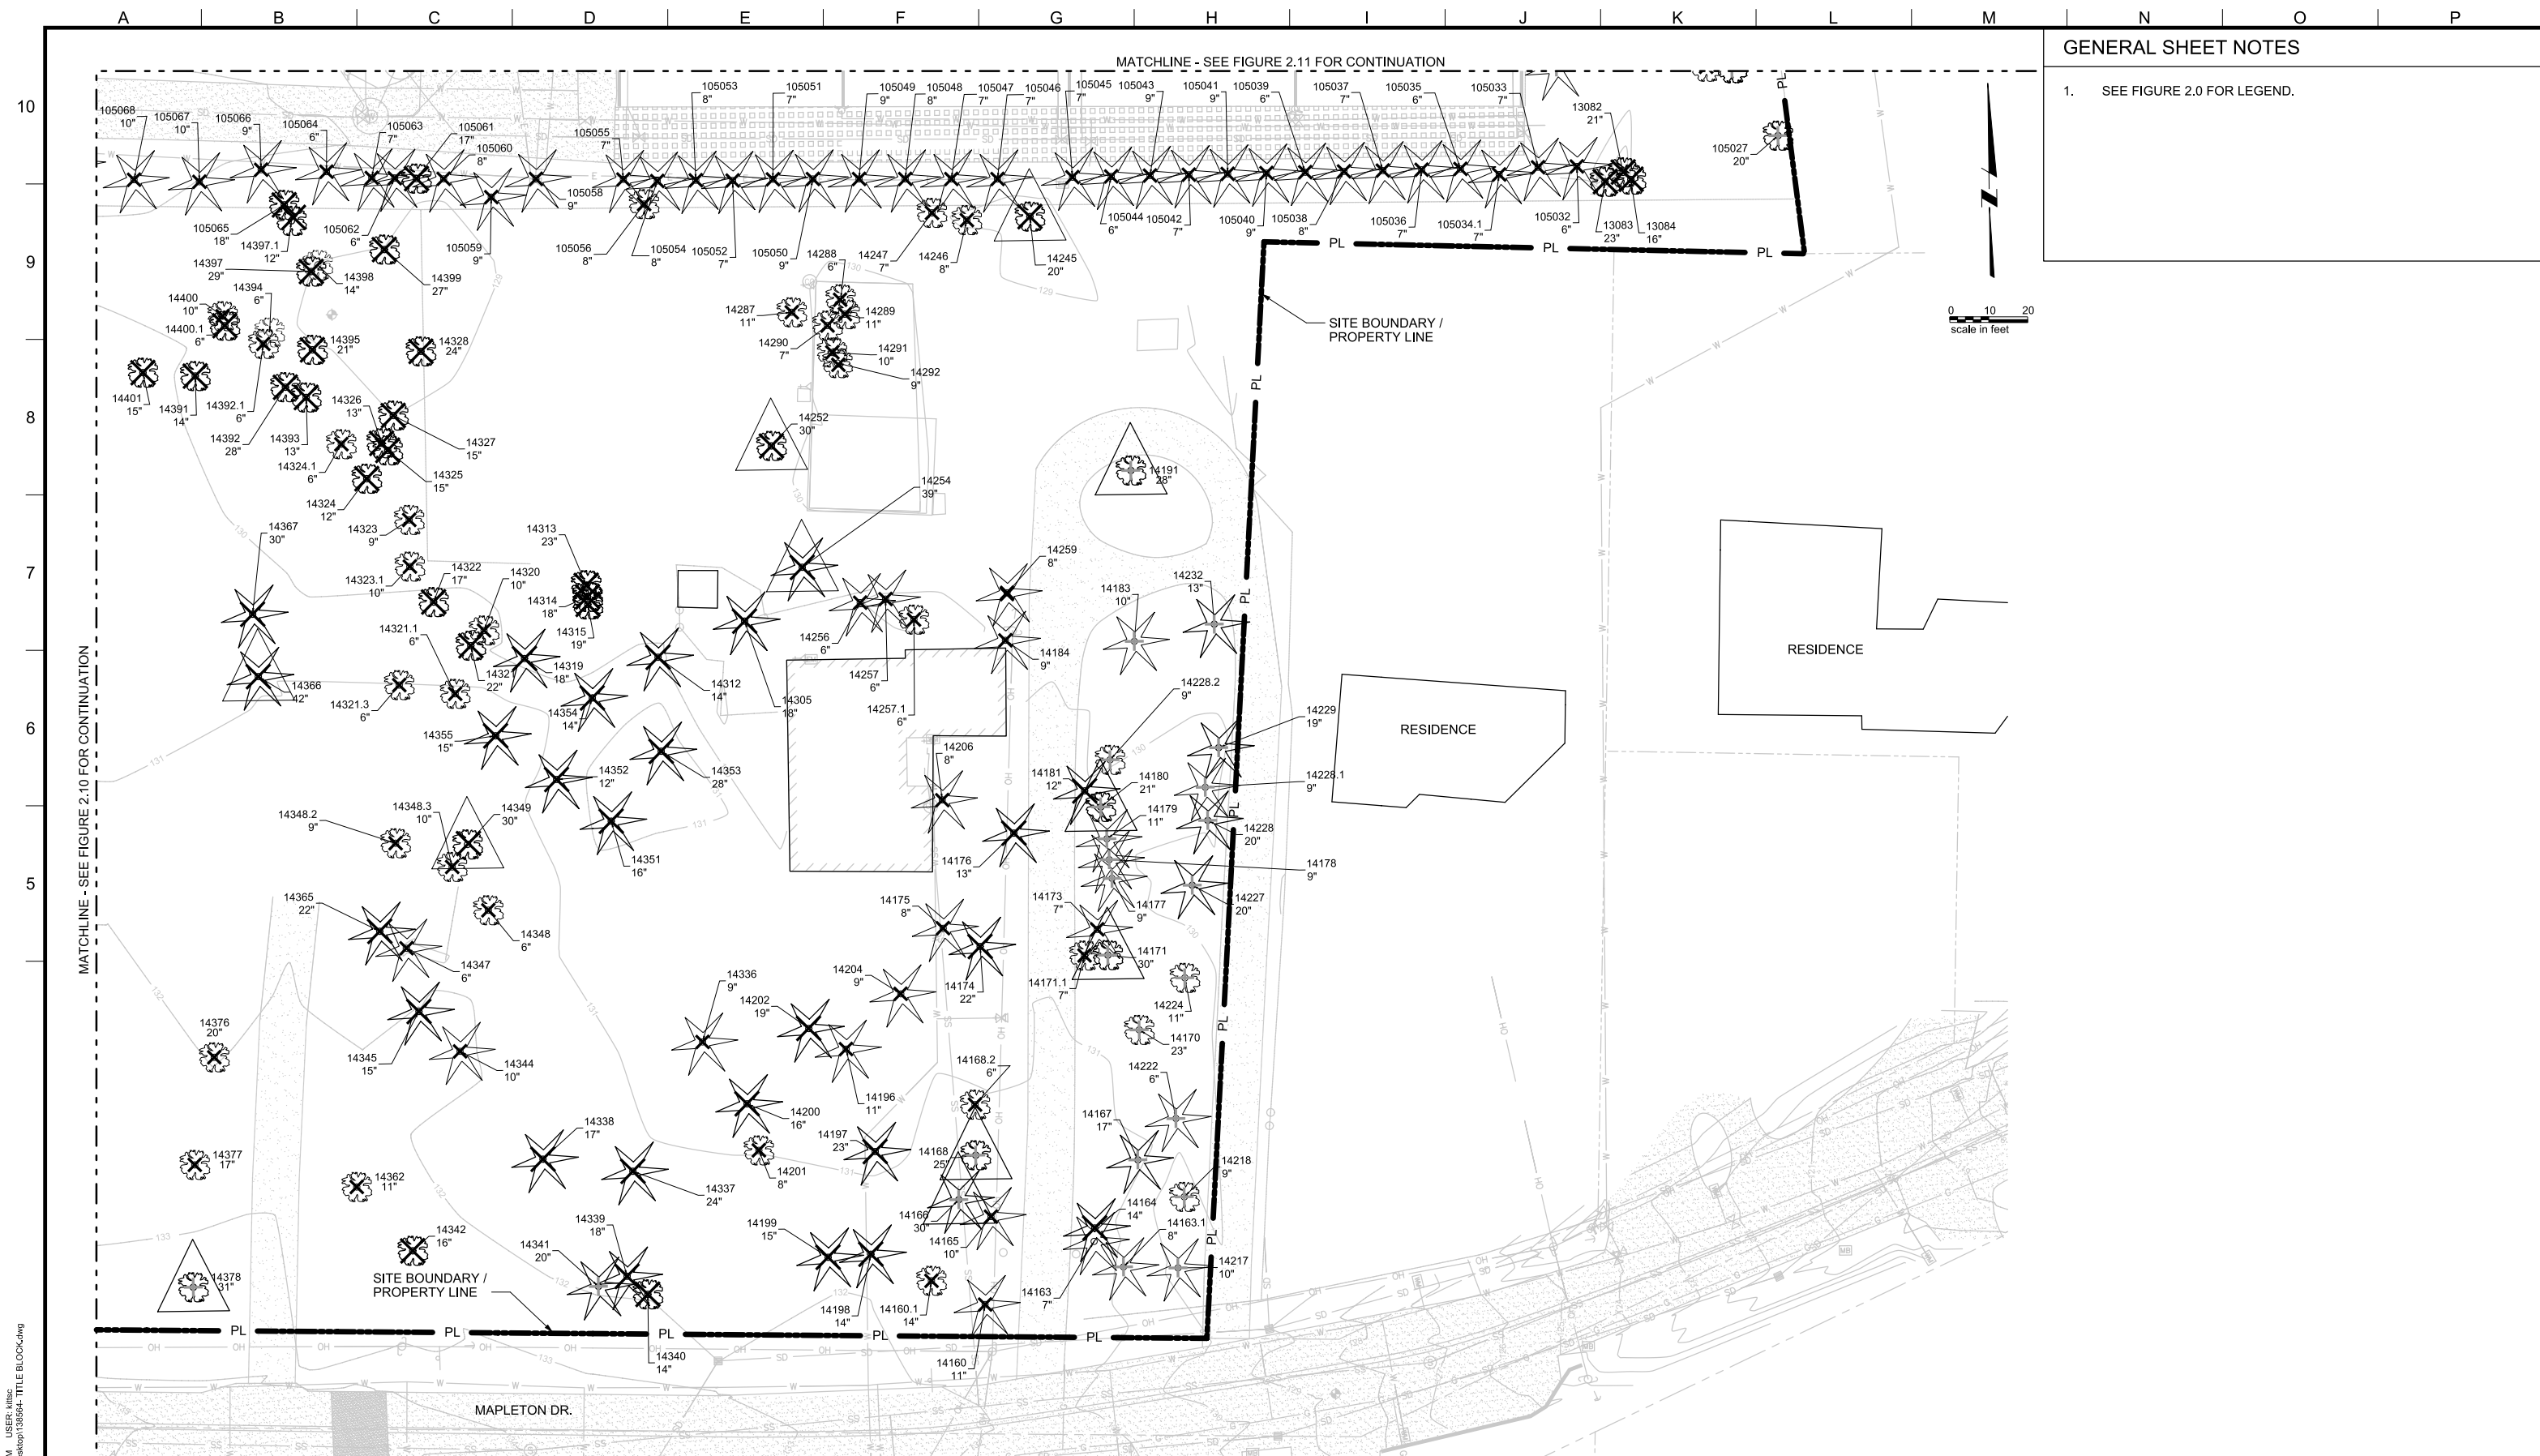
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REV.	DESCRIPTION	BY		APP.

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 380 A AVENUE  
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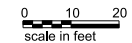
LAKE OSWEGO AND TIGARD WATER TREATMENT PLANT  
 DESIGN REVIEW AND CONDITIONAL USE  
**SITE ANALYSIS - EXISTING TREE REMOVAL  
 AREA C**

FILENAME	
PROJECT NUMBER	
SCALE	1" = 20'
DRAWING/FIGURE NUMBER	2.11
### OF	



**GENERAL SHEET NOTES**

1. SEE FIGURE 2.0 FOR LEGEND.



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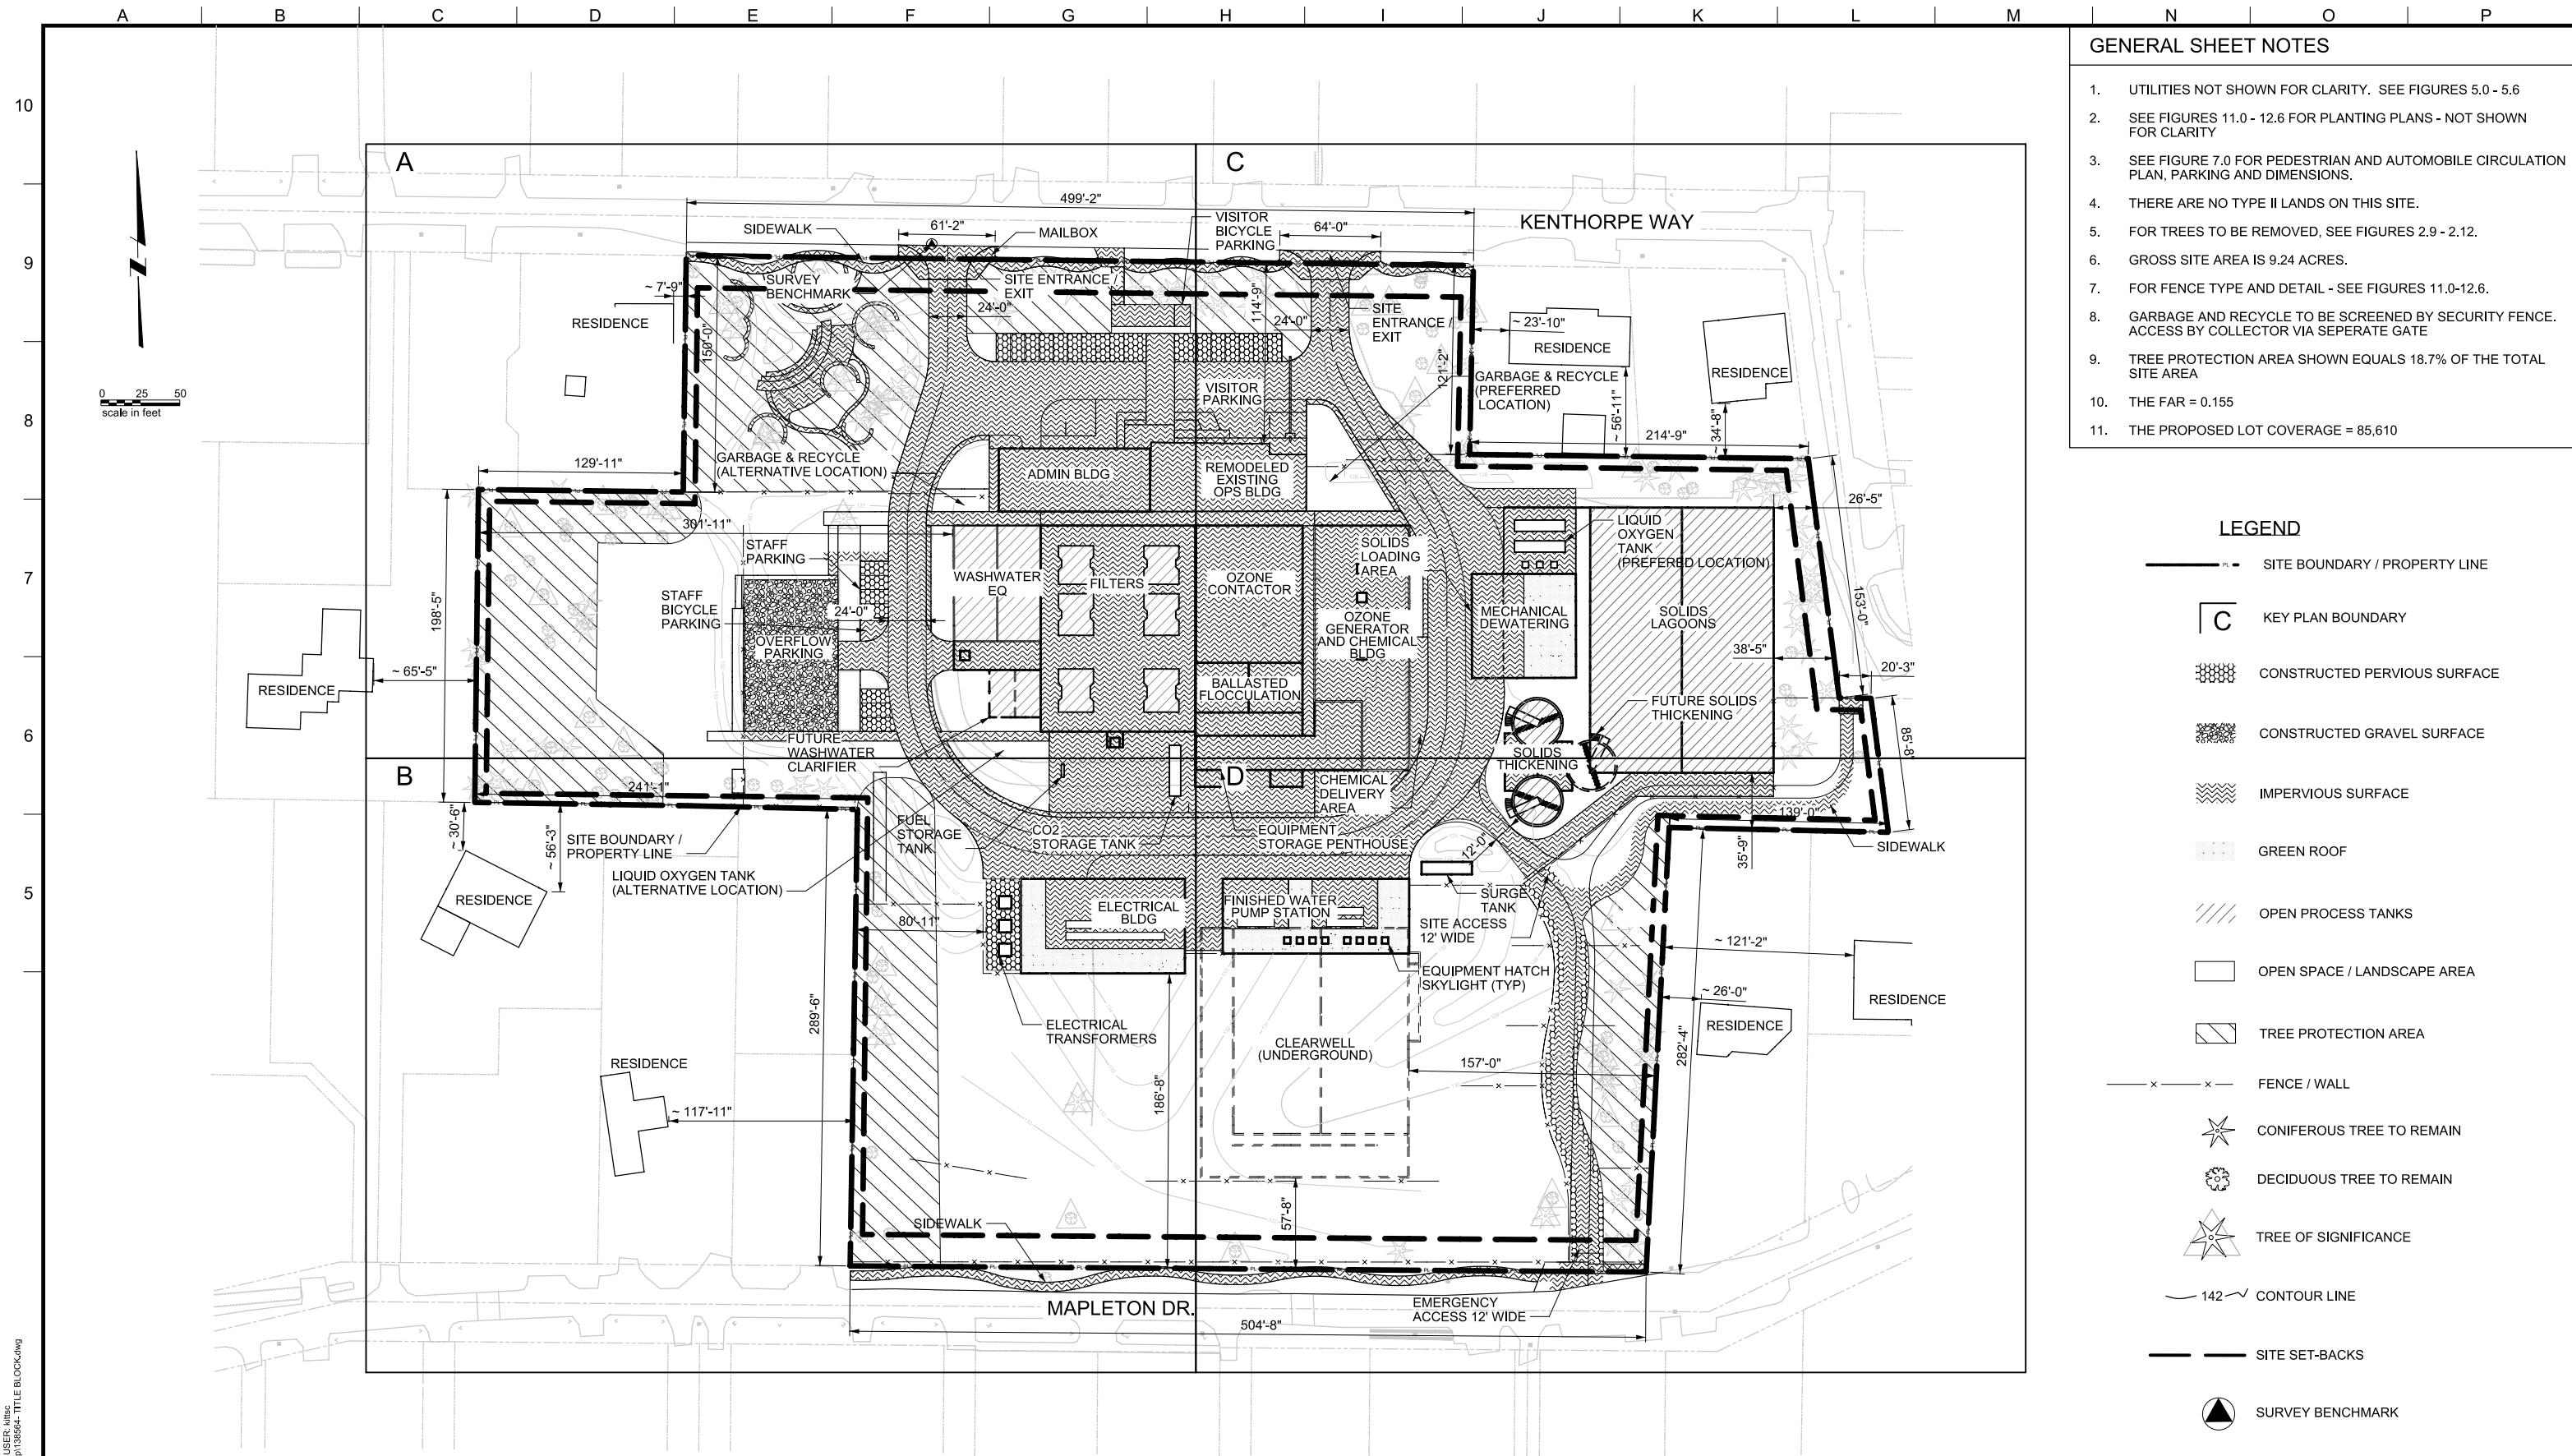
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LAKE OSWEGO AND TIGARD WATER TREATMENT PLANT  
 DESIGN REVIEW AND CONDITIONAL USE  
**SITE ANALYSIS - EXISTING TREE REMOVAL**  
 AREA D

FILENAME	
PROJECT NUMBER	
SCALE	1" = 20'
DRAWING/FIGURE NUMBER	2.12
### OF	





- GENERAL SHEET NOTES**
1. UTILITIES NOT SHOWN FOR CLARITY. SEE FIGURES 5.0 - 5.6
  2. SEE FIGURES 11.0 - 12.6 FOR PLANTING PLANS - NOT SHOWN FOR CLARITY
  3. SEE FIGURE 7.0 FOR PEDESTRIAN AND AUTOMOBILE CIRCULATION PLAN, PARKING AND DIMENSIONS.
  4. THERE ARE NO TYPE II LANDS ON THIS SITE.
  5. FOR TREES TO BE REMOVED, SEE FIGURES 2.9 - 2.12.
  6. GROSS SITE AREA IS 9.24 ACRES.
  7. FOR FENCE TYPE AND DETAIL - SEE FIGURES 11.0-12.6.
  8. GARBAGE AND RECYCLE TO BE SCREENED BY SECURITY FENCE. ACCESS BY COLLECTOR VIA SEPERATE GATE
  9. TREE PROTECTION AREA SHOWN EQUALS 18.7% OF THE TOTAL SITE AREA
  10. THE FAR = 0.155
  11. THE PROPOSED LOT COVERAGE = 85,610

- LEGEND**
- SITE BOUNDARY / PROPERTY LINE
  - ⊃ KEY PLAN BOUNDARY
  - ▨ CONSTRUCTED PERVIOUS SURFACE
  - ▩ CONSTRUCTED GRAVEL SURFACE
  - ▧ IMPERVIOUS SURFACE
  - ▤ GREEN ROOF
  - ▦ OPEN PROCESS TANKS
  - OPEN SPACE / LANDSCAPE AREA
  - ▧ TREE PROTECTION AREA
  - x-x- FENCE / WALL
  - ★ CONIFEROUS TREE TO REMAIN
  - ⊙ DECIDUOUS TREE TO REMAIN
  - ⊙ TREE OF SIGNIFICANCE
  - ~ 142 ~ CONTOUR LINE
  - SITE SET-BACKS
  - ▲ SURVEY BENCHMARK

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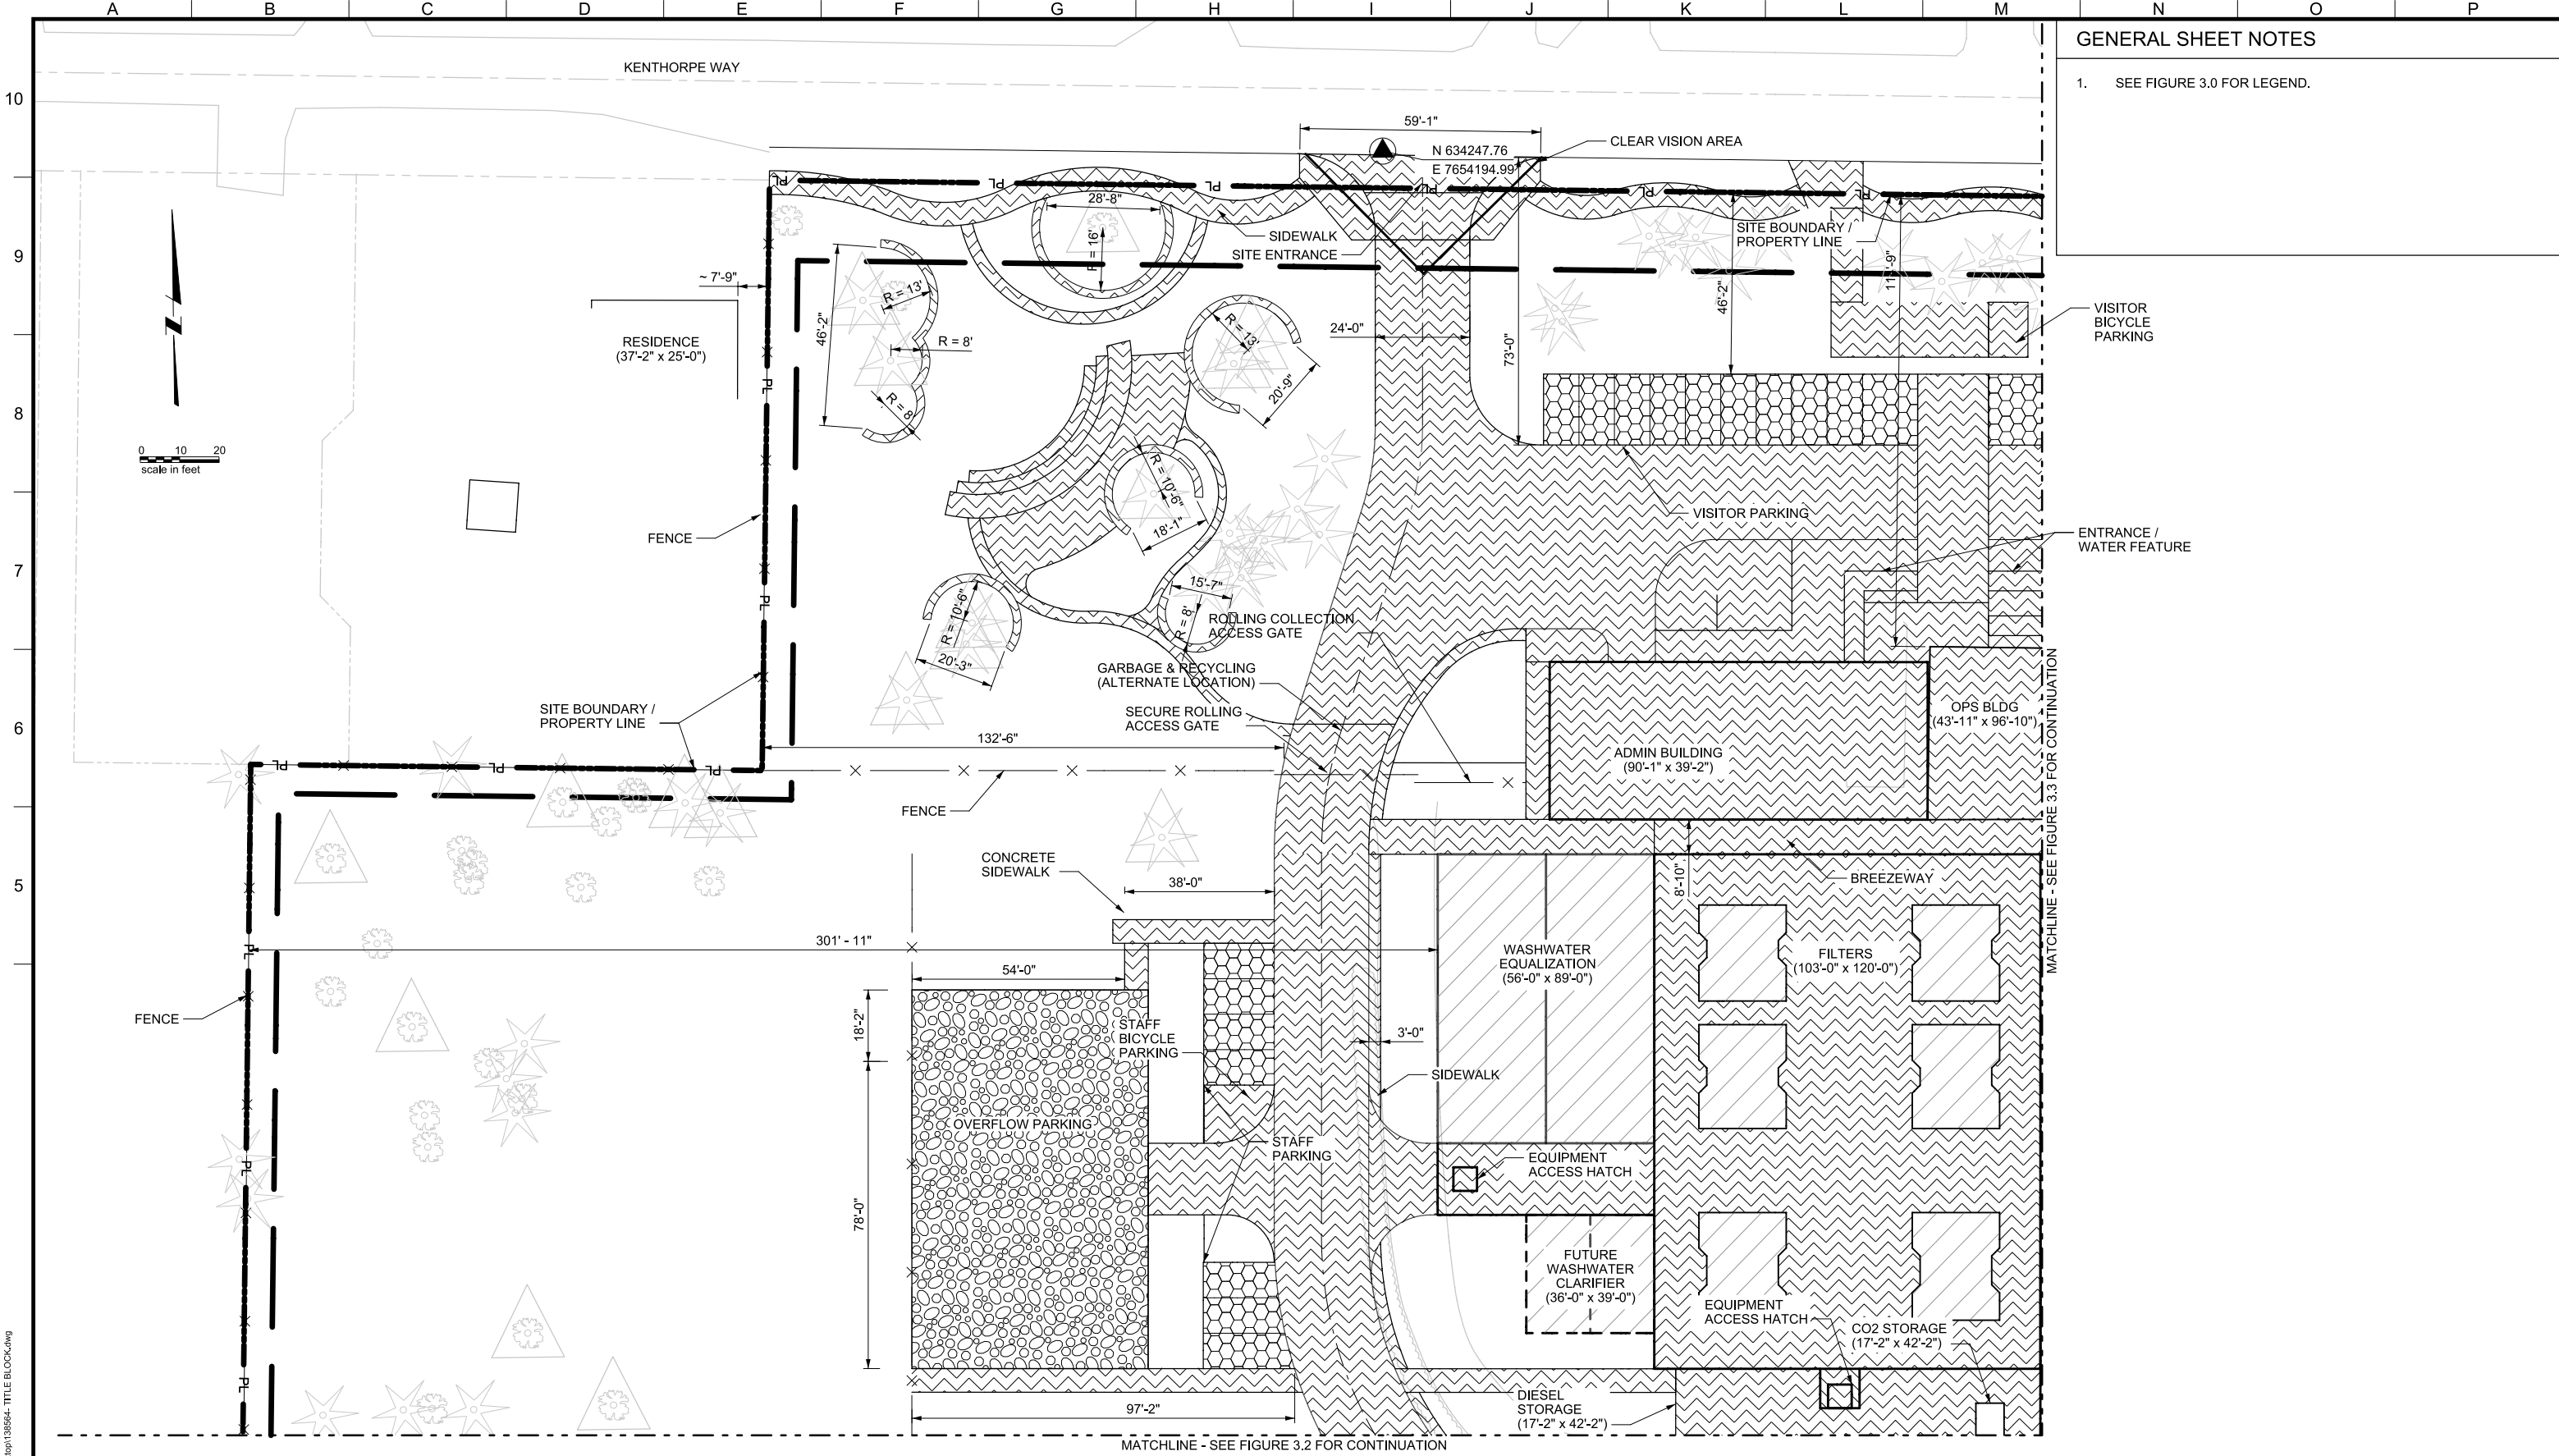
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LAKE OSWEGO AND TIGARD WATER TREATMENT PLANT  
 DESIGN REVIEW AND CONDITIONAL USE  
**PROPOSED SITE PLAN  
 OVERVIEW**

FILENAME	
PROJECT NUMBER	
SCALE	1" = 50'
DRAWING/FIGURE NUMBER	3.0
### OF	



**GENERAL SHEET NOTES**

1. SEE FIGURE 3.0 FOR LEGEND.

MATCHLINE - SEE FIGURE 3.3 FOR CONTINUATION

MATCHLINE - SEE FIGURE 3.2 FOR CONTINUATION

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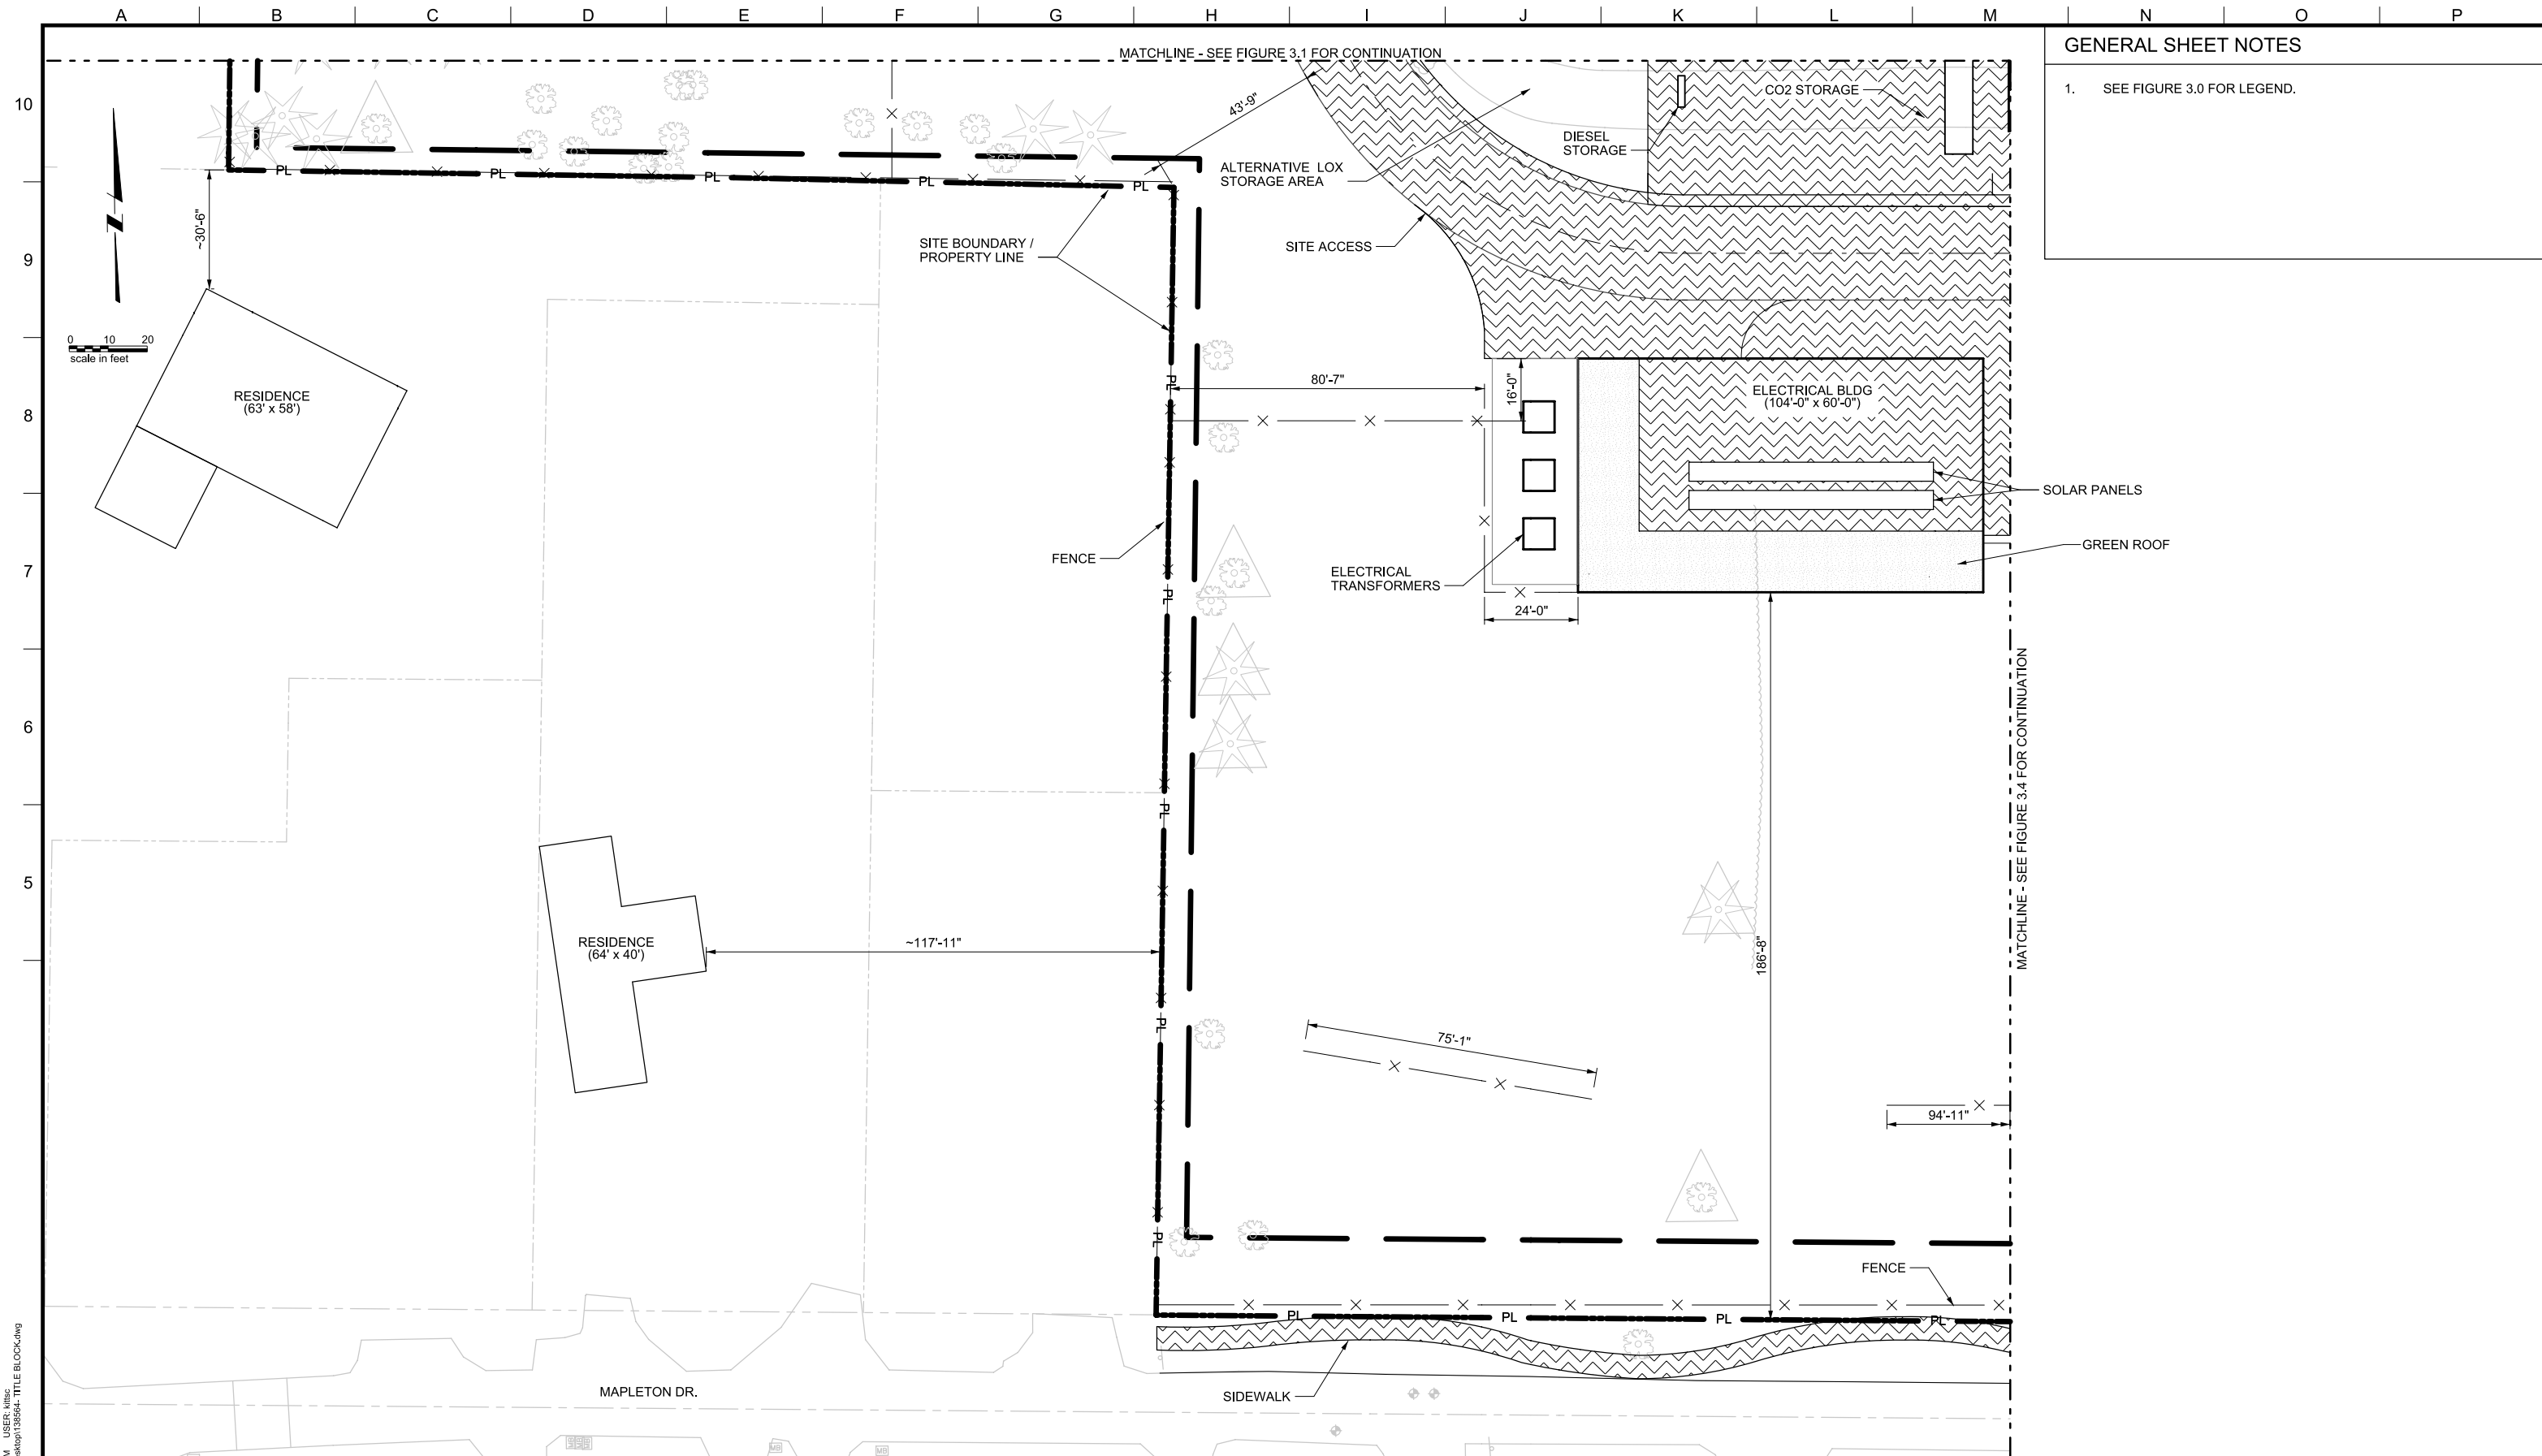
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REV.	DESCRIPTION	BY	DATE	APP.

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LAKE OSWEGO AND TIGARD WATER TREATMENT PLANT  
DESIGN REVIEW AND CONDITIONAL USE  
**PROPOSED SITE PLAN  
AREA A**

FILENAME	
PROJECT NUMBER	
SCALE	1" = 20'
DRAWING/FIGURE NUMBER	<b>3.1</b>
### OF	



**GENERAL SHEET NOTES**

1. SEE FIGURE 3.0 FOR LEGEND.

**MWH**  
806 SW BROADWAY, SUITE 200  
PORTLAND, OREGON 97205

LINE IS 2 INCHES AT FULL SIZE (IF NOT 2" - SCALE ACCORDINGLY)

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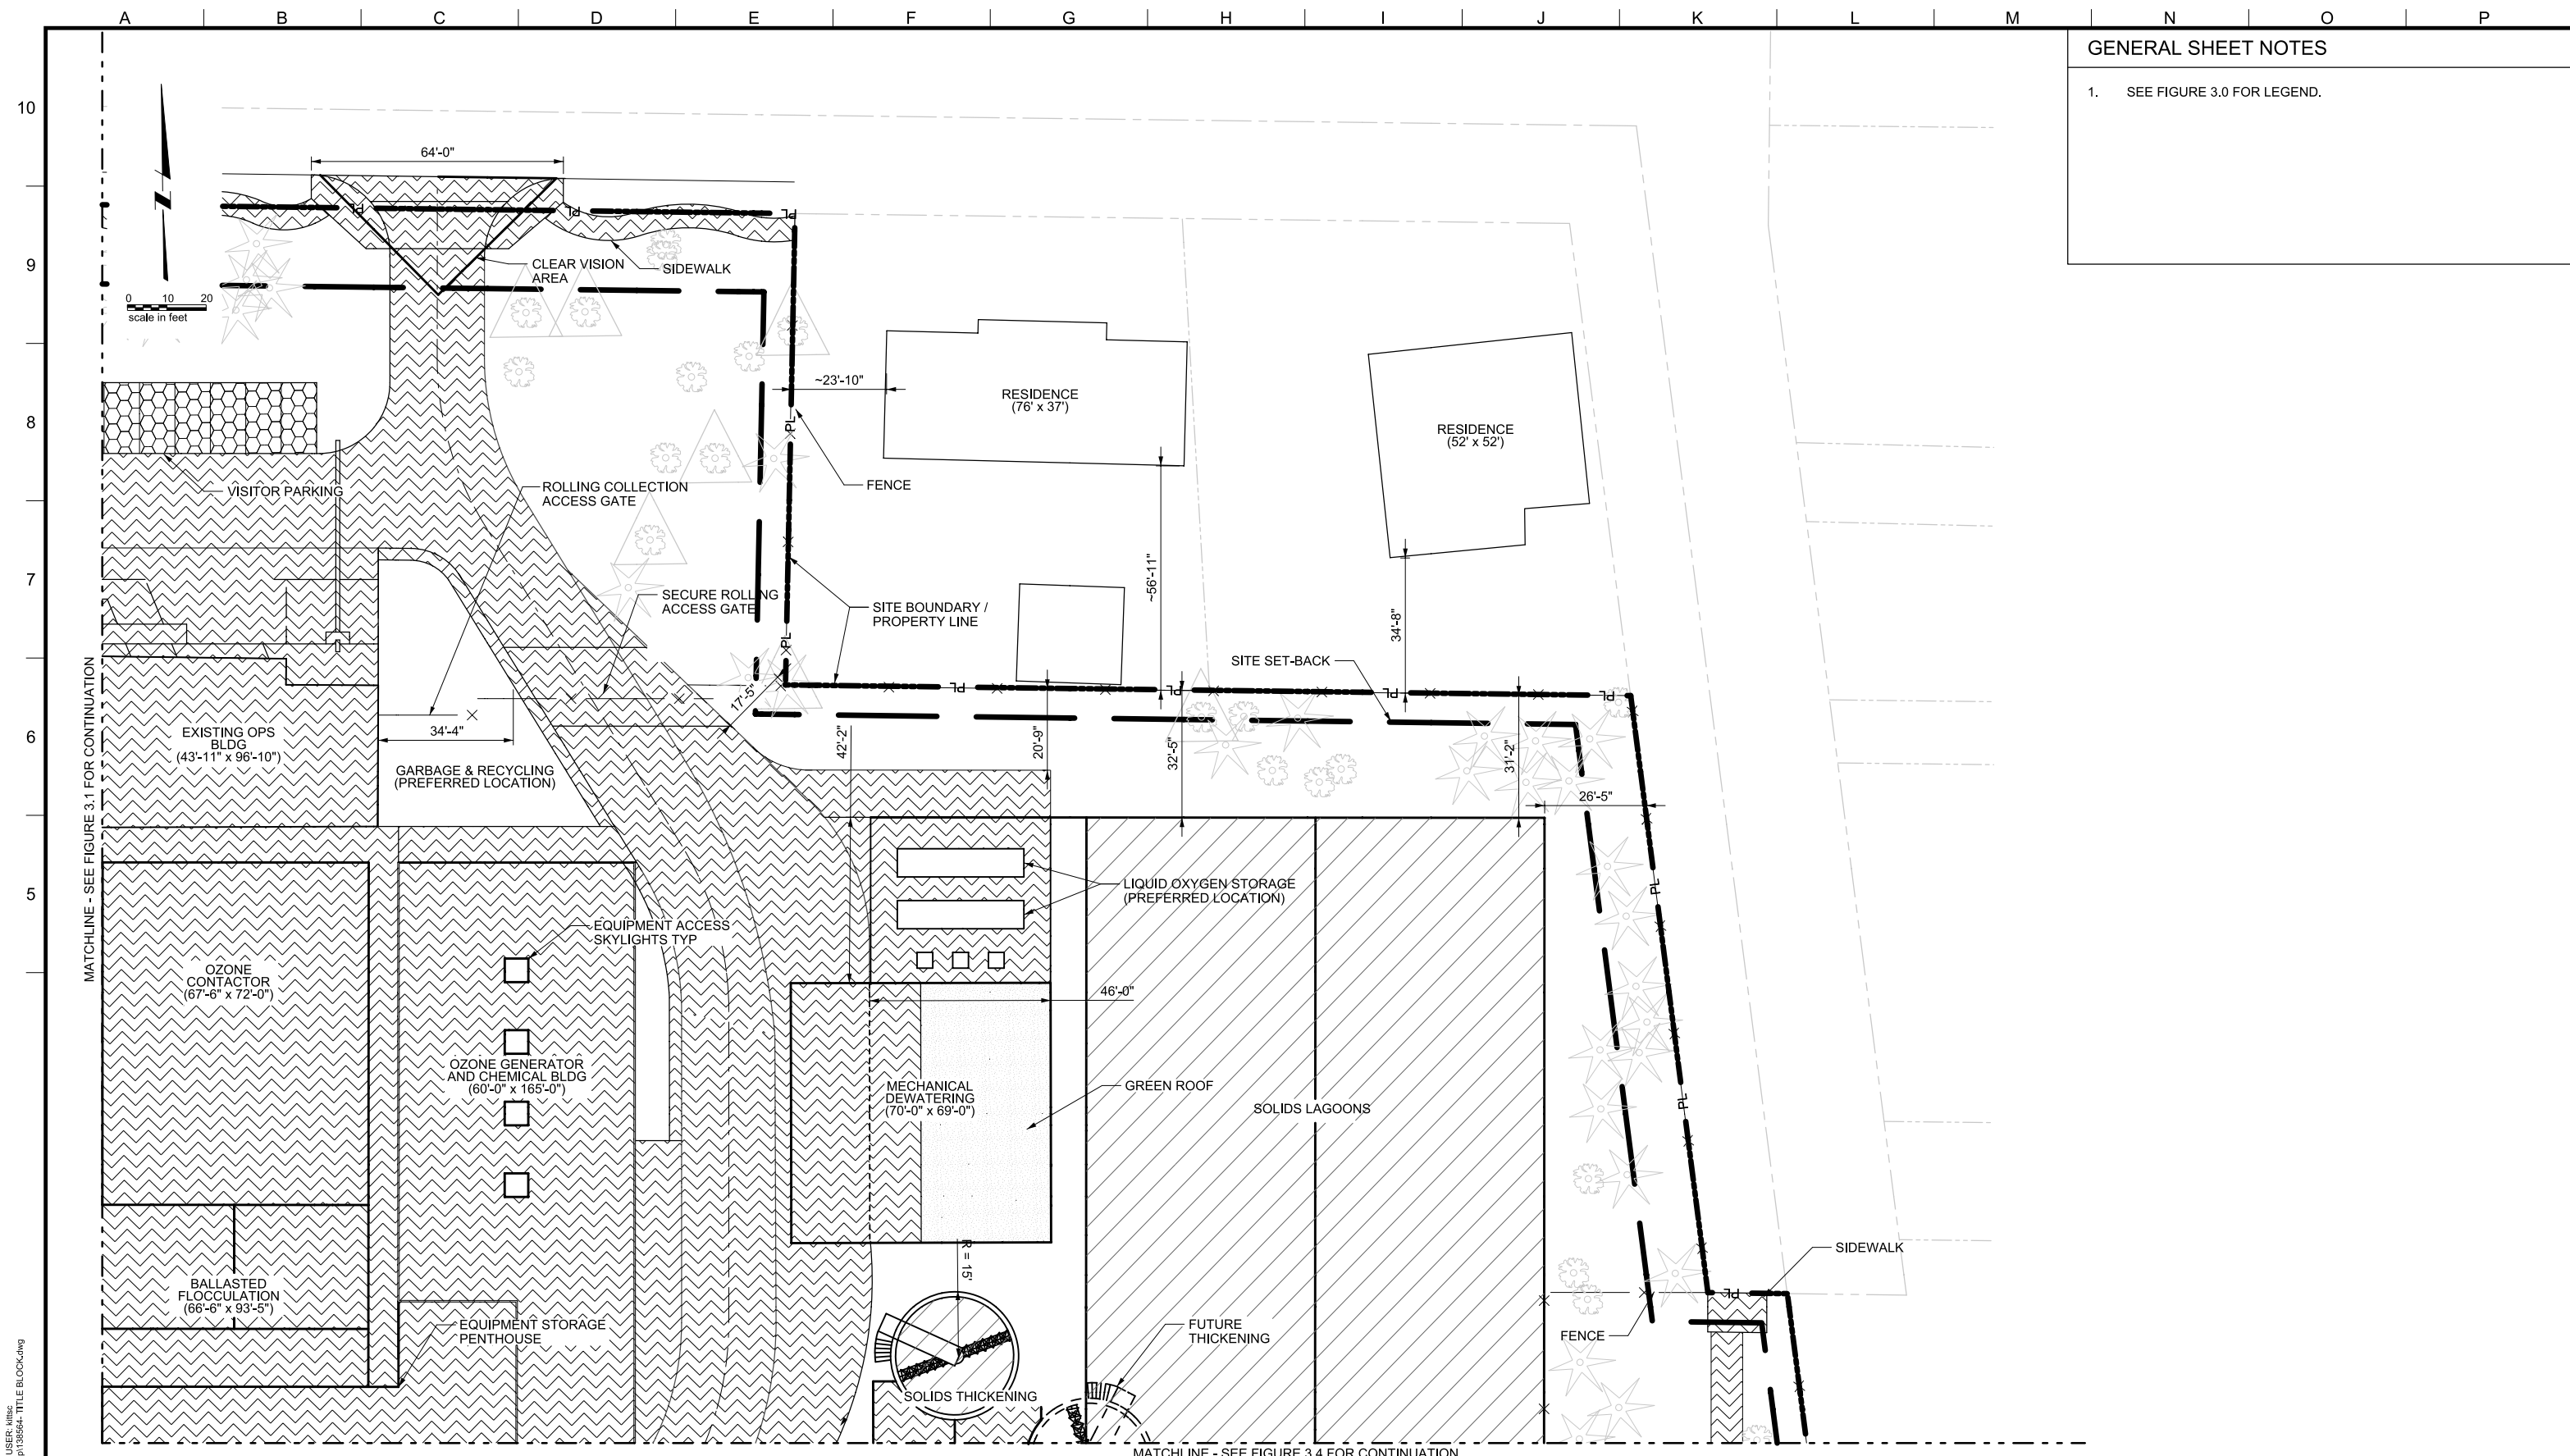
LAKE OSWEGO AND TIGARD WATER TREATMENT PLANT  
DESIGN REVIEW AND CONDITIONAL USE  
**PROPOSED SITE PLAN**  
AREA B

FILENAME	
PROJECT NUMBER	
SCALE	1" = 20'
DRAWING/FIGURE NUMBER	3.2
#### OF	

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GENERAL SHEET NOTES

1. SEE FIGURE 3.0 FOR LEGEND.



MATCHLINE - SEE FIGURE 3.1 FOR CONTINUATION

MATCHLINE - SEE FIGURE 3.4 FOR CONTINUATION



LINE IS 2 INCHES AT FULL SIZE (IF NOT 2" - SCALE ACCORDINGLY)

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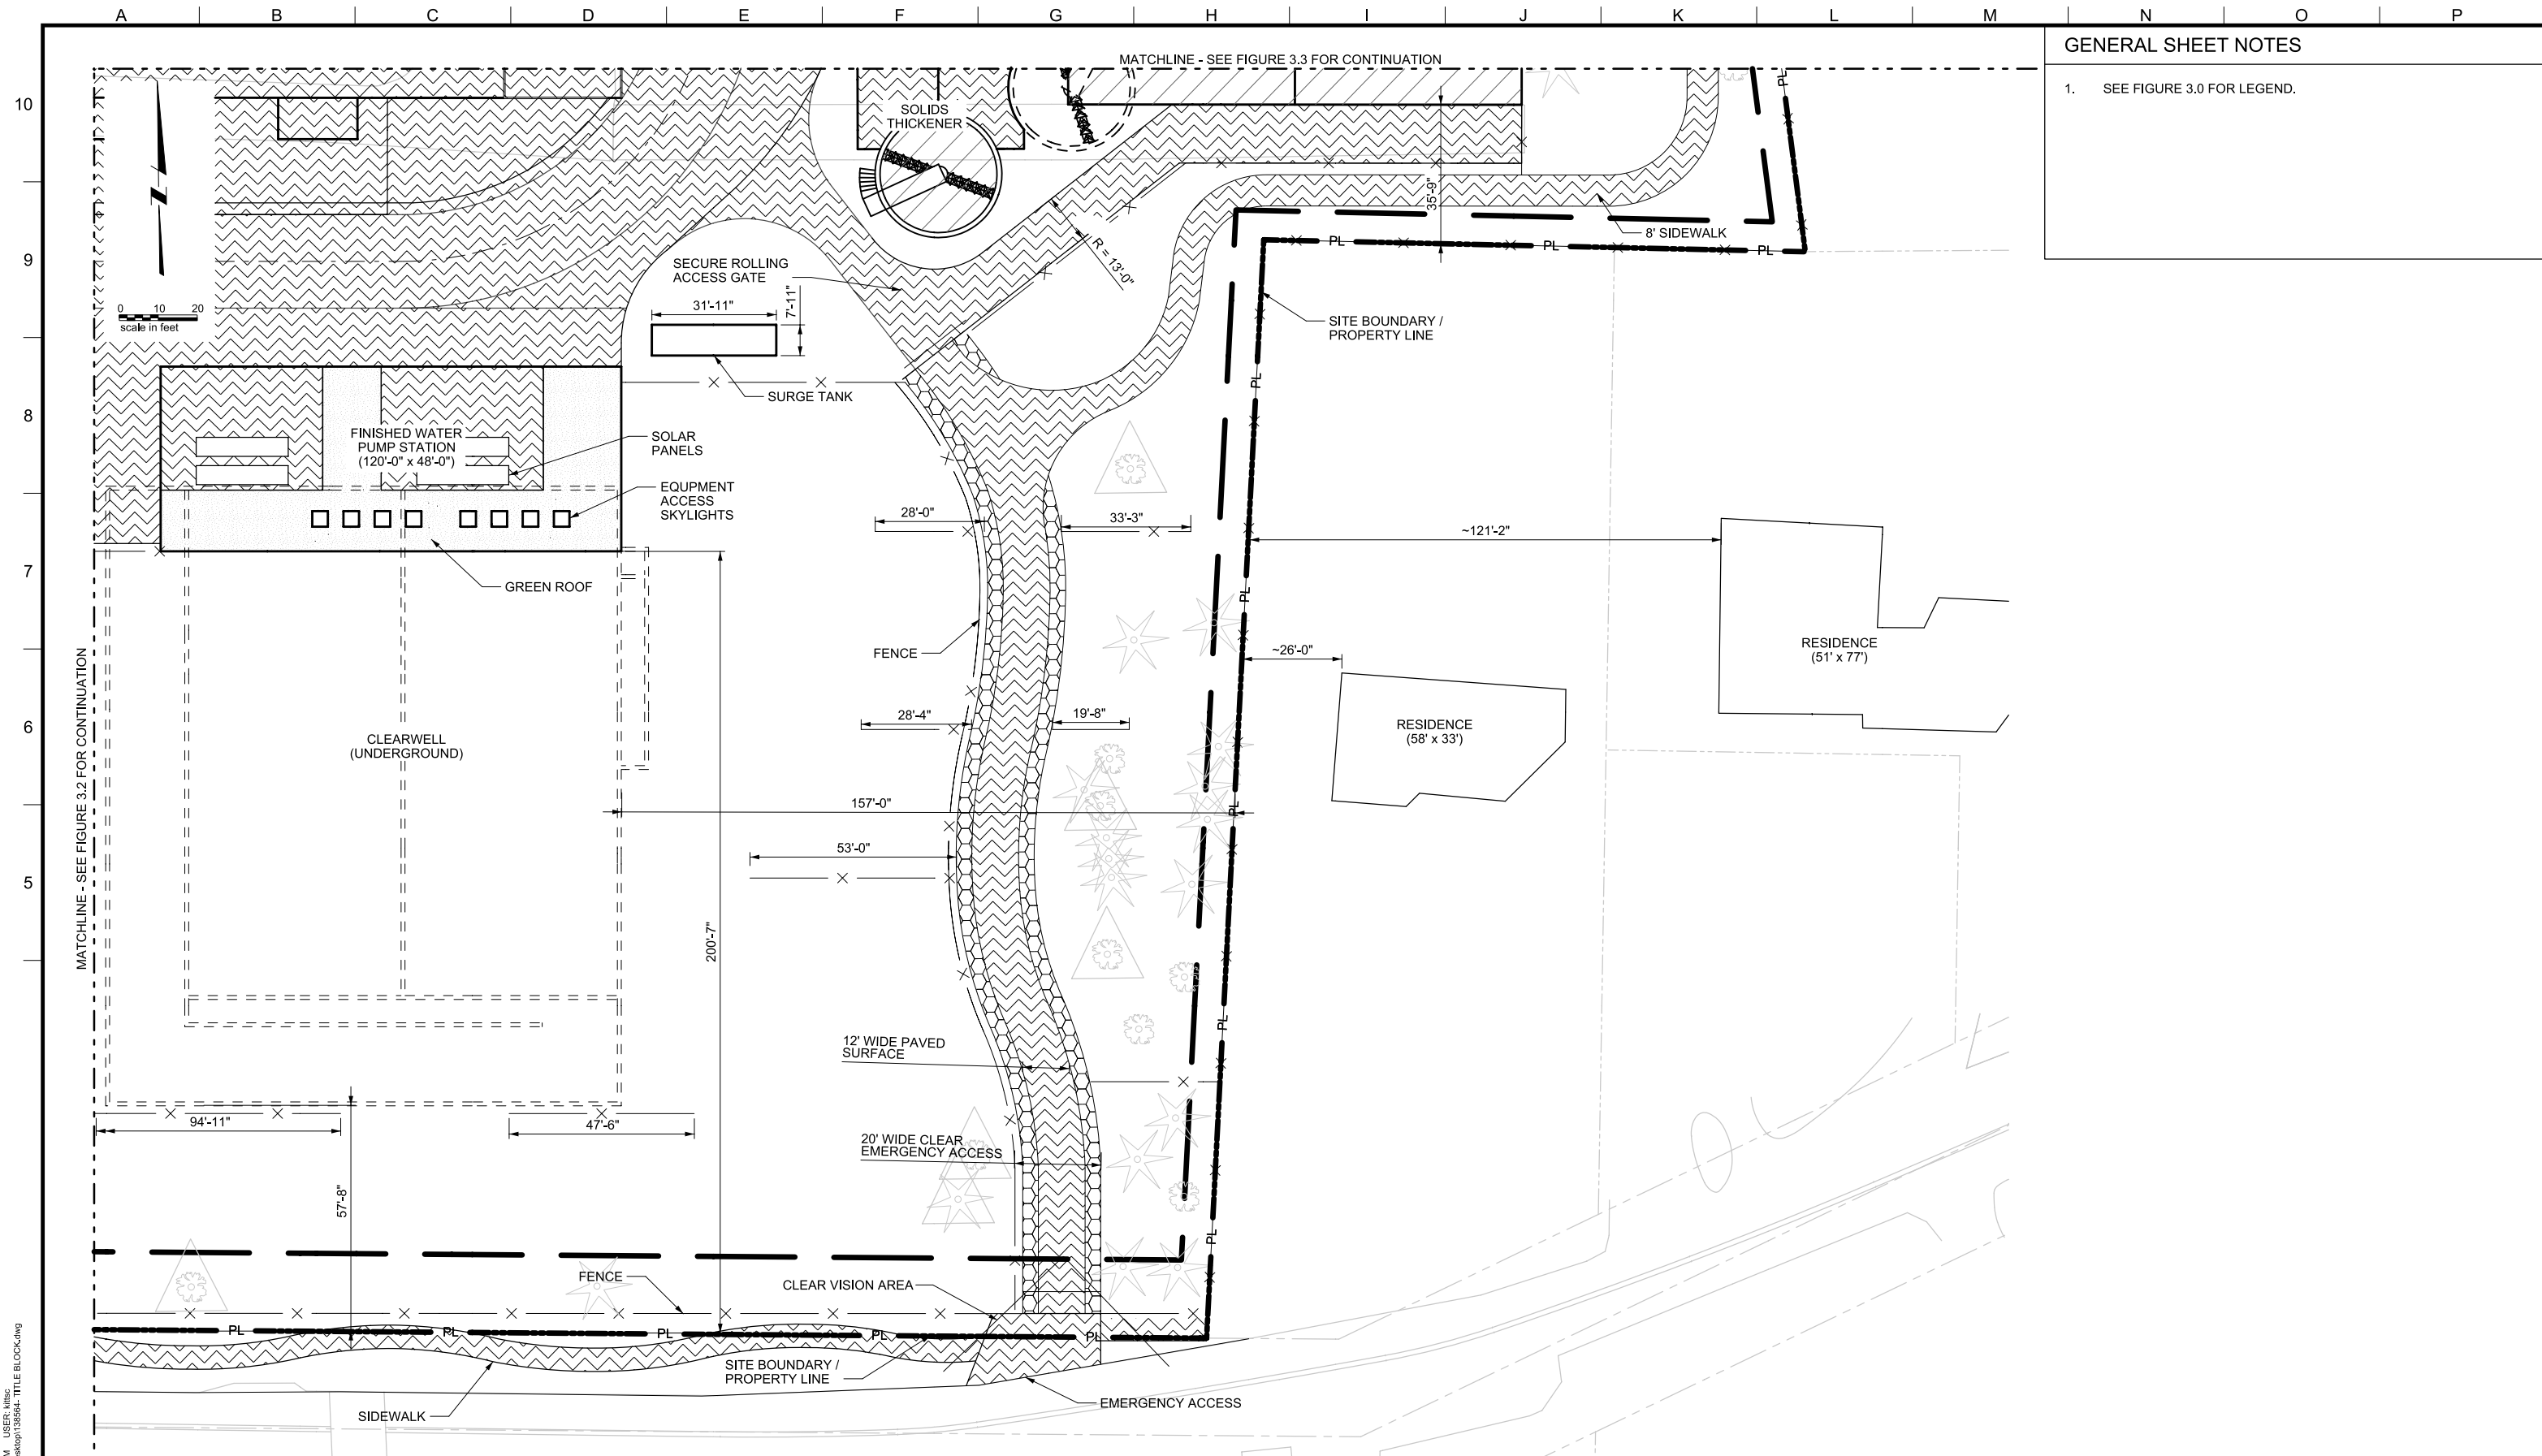
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LAKE OSWEGO AND TIGARD WATER TREATMENT PLANT  
 DESIGN REVIEW AND CONDITIONAL USE  
**PROPOSED SITE PLAN**  
 AREA C

FILENAME	
PROJECT NUMBER	
SCALE	1" = 20'
DRAWING/FIGURE NUMBER	3.3
### OF	

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**GENERAL SHEET NOTES**

1. SEE FIGURE 3.0 FOR LEGEND.

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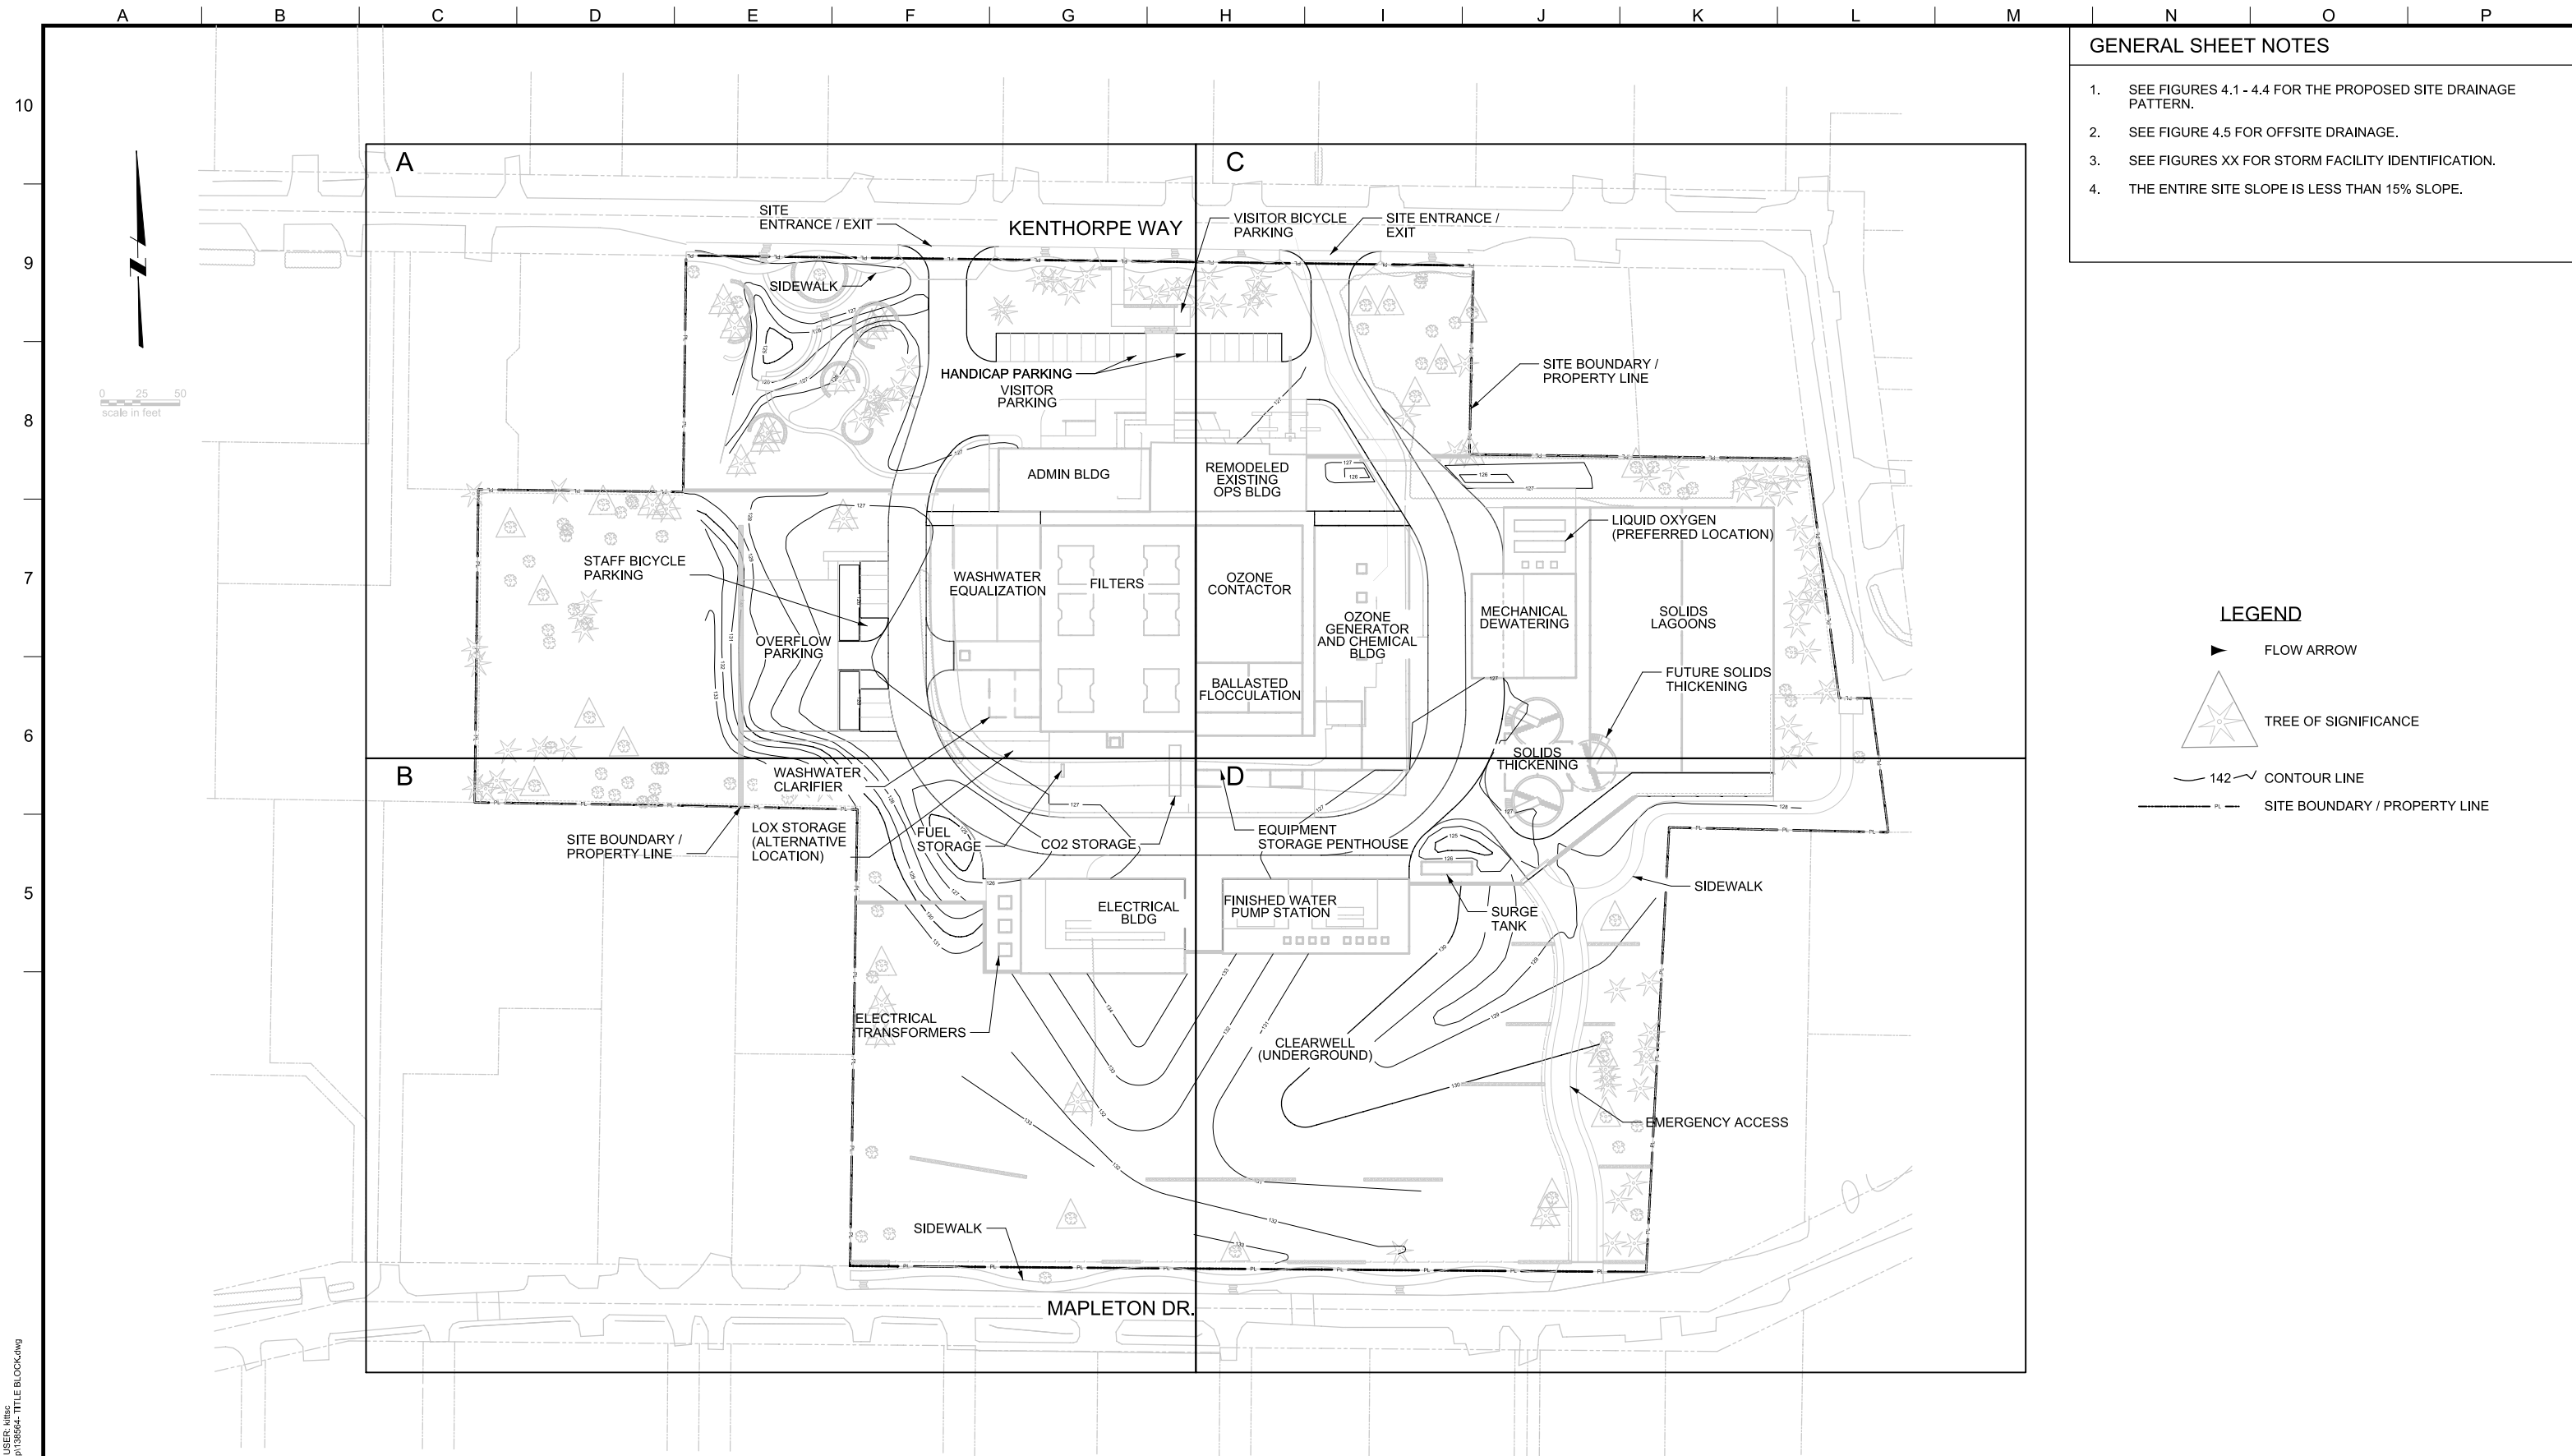
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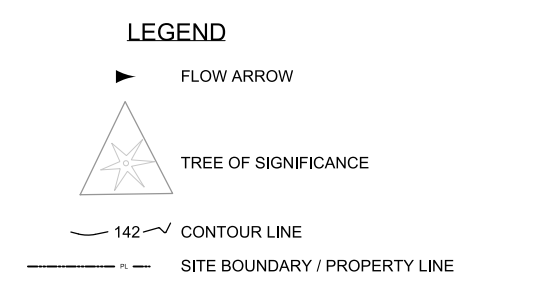


LAKE OSWEGO AND TIGARD WATER TREATMENT PLANT  
 DESIGN REVIEW AND CONDITIONAL USE  
**PROPOSED SITE PLAN**  
 AREA D

FILENAME	
PROJECT NUMBER	
SCALE	1" = 20'
DRAWING/FIGURE NUMBER	3.4
### OF	



- GENERAL SHEET NOTES**
- SEE FIGURES 4.1 - 4.4 FOR THE PROPOSED SITE DRAINAGE PATTERN.
  - SEE FIGURE 4.5 FOR OFFSITE DRAINAGE.
  - SEE FIGURES XX FOR STORM FACILITY IDENTIFICATION.
  - THE ENTIRE SITE SLOPE IS LESS THAN 15% SLOPE.



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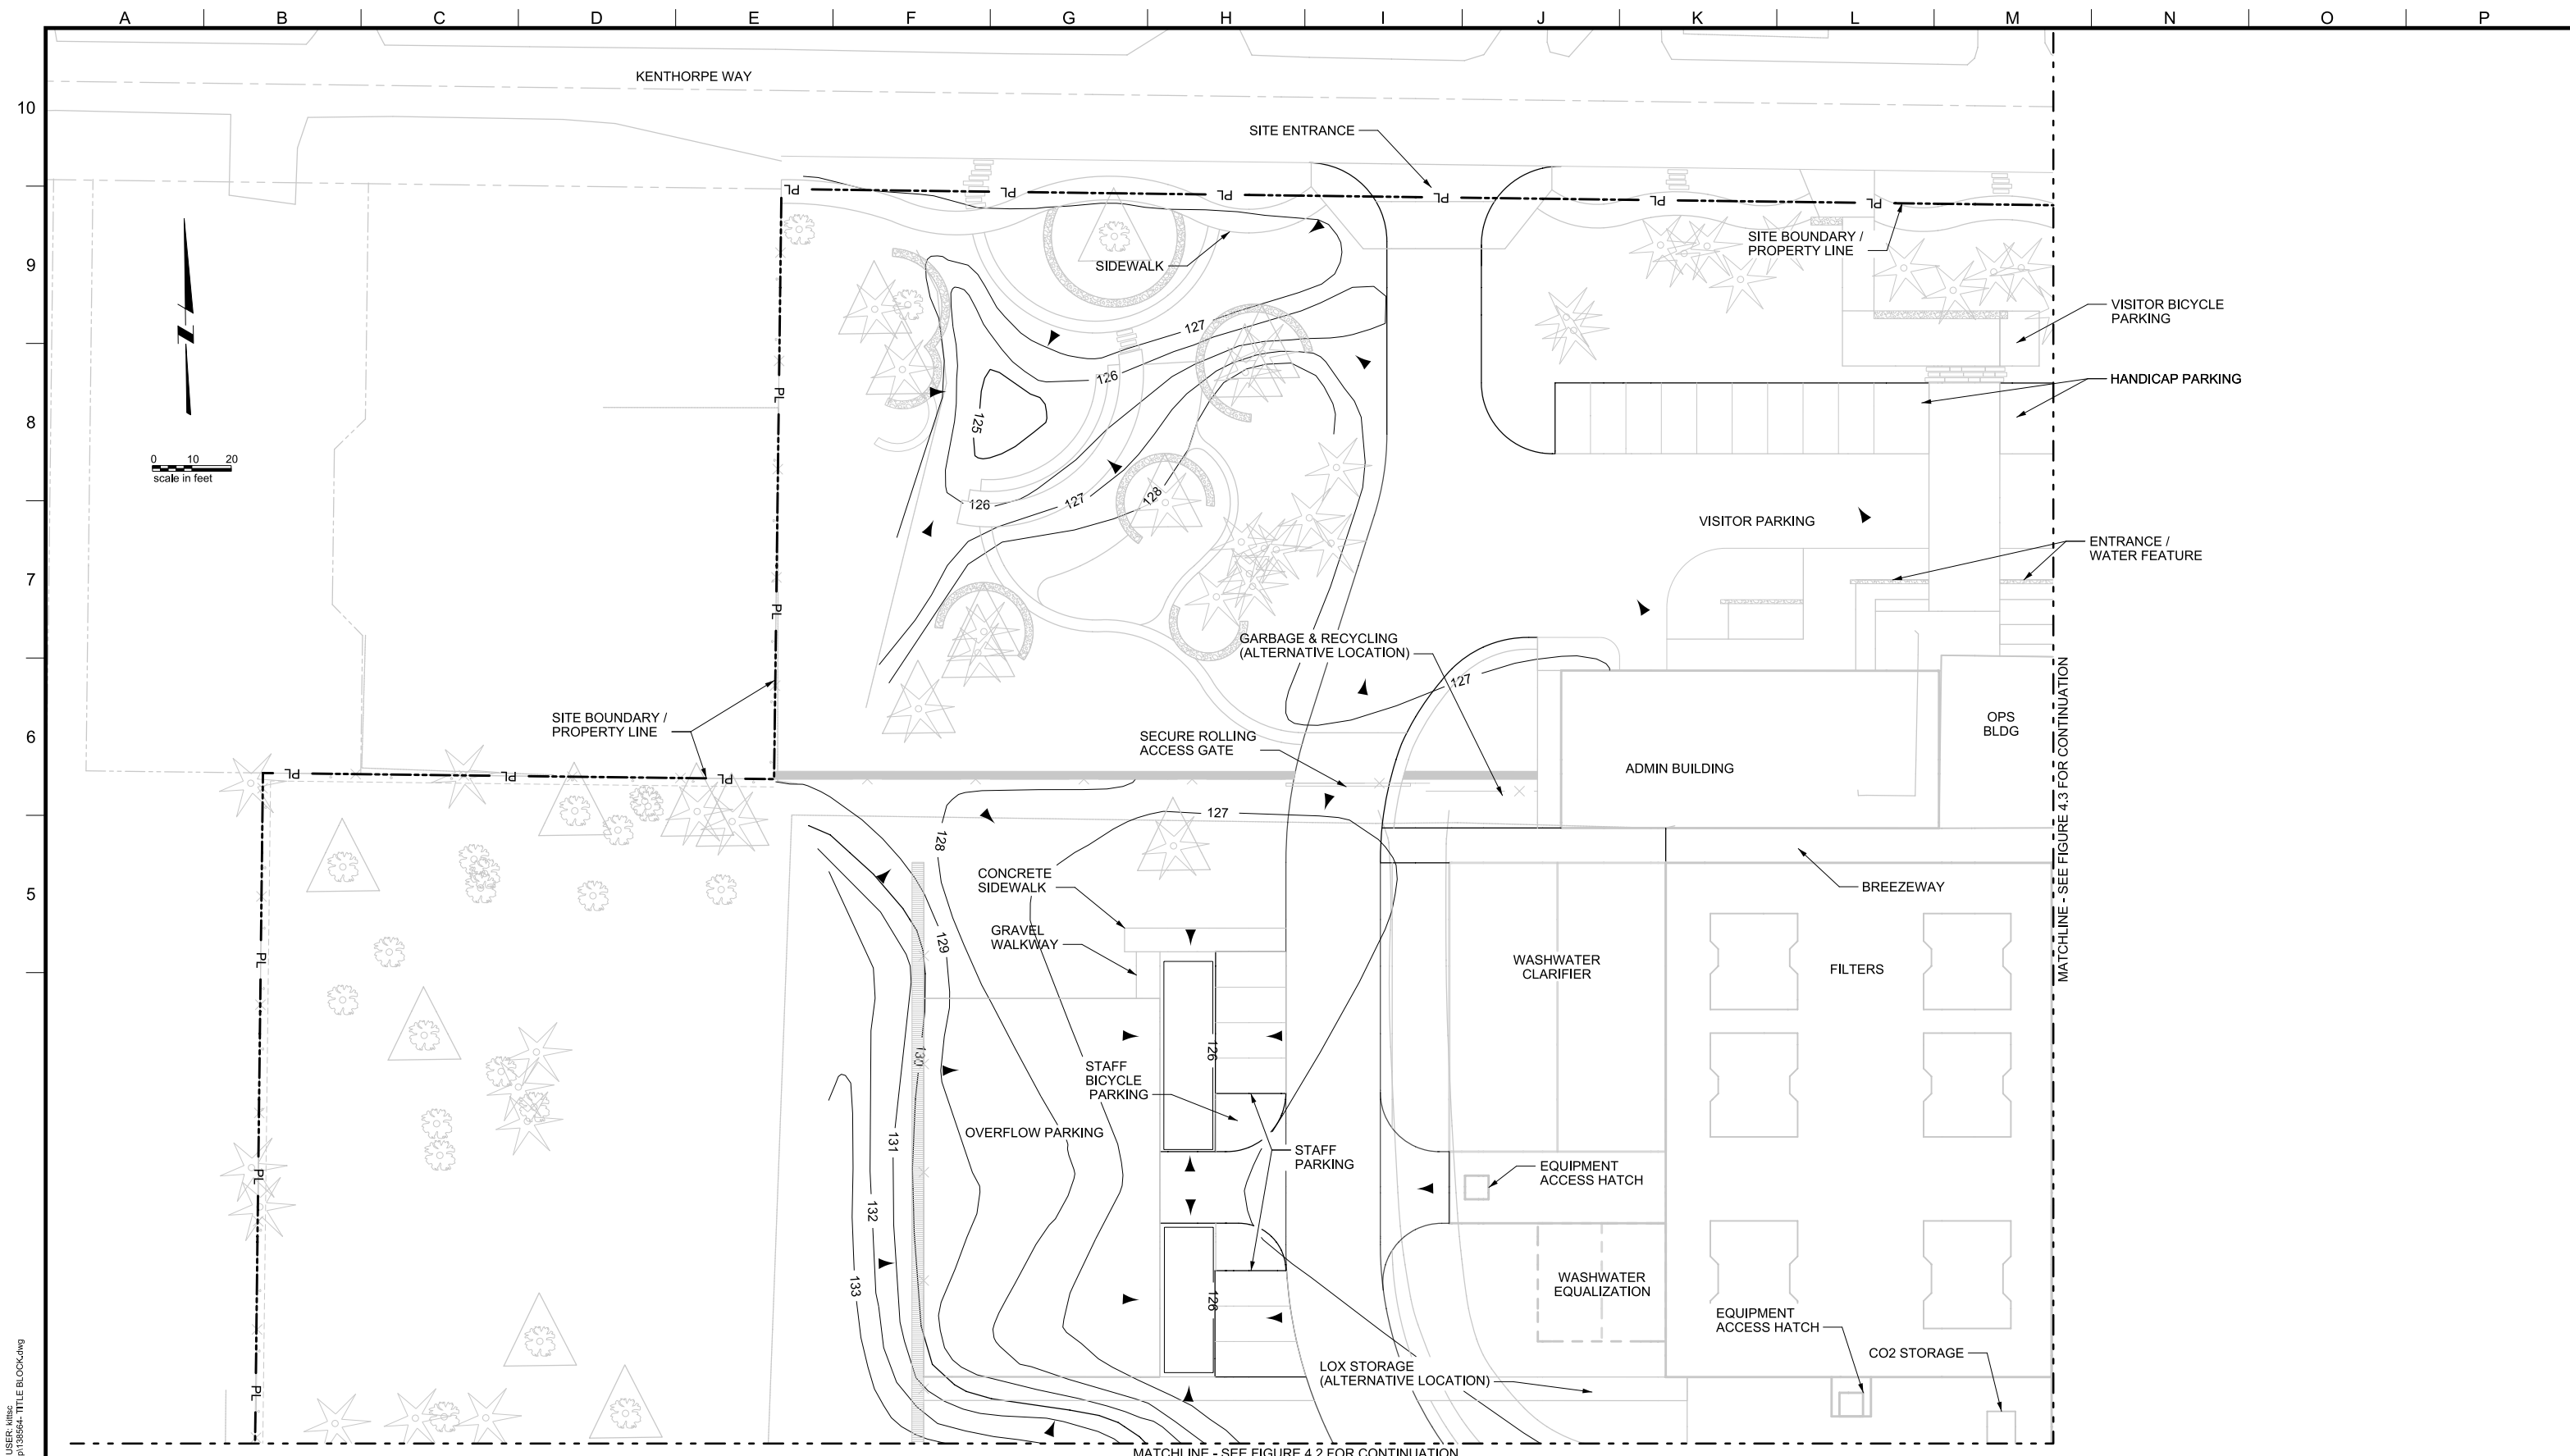
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LAKE OSWEGO AND TIGARD WATER TREATMENT PLANT  
 DESIGN REVIEW AND CONDITIONAL USE  
**GRADING PLAN  
 OVERVIEW**

FILENAME	
PROJECT NUMBER	
SCALE	1" = 50'
DRAWING/FIGURE NUMBER	4.0
### OF	



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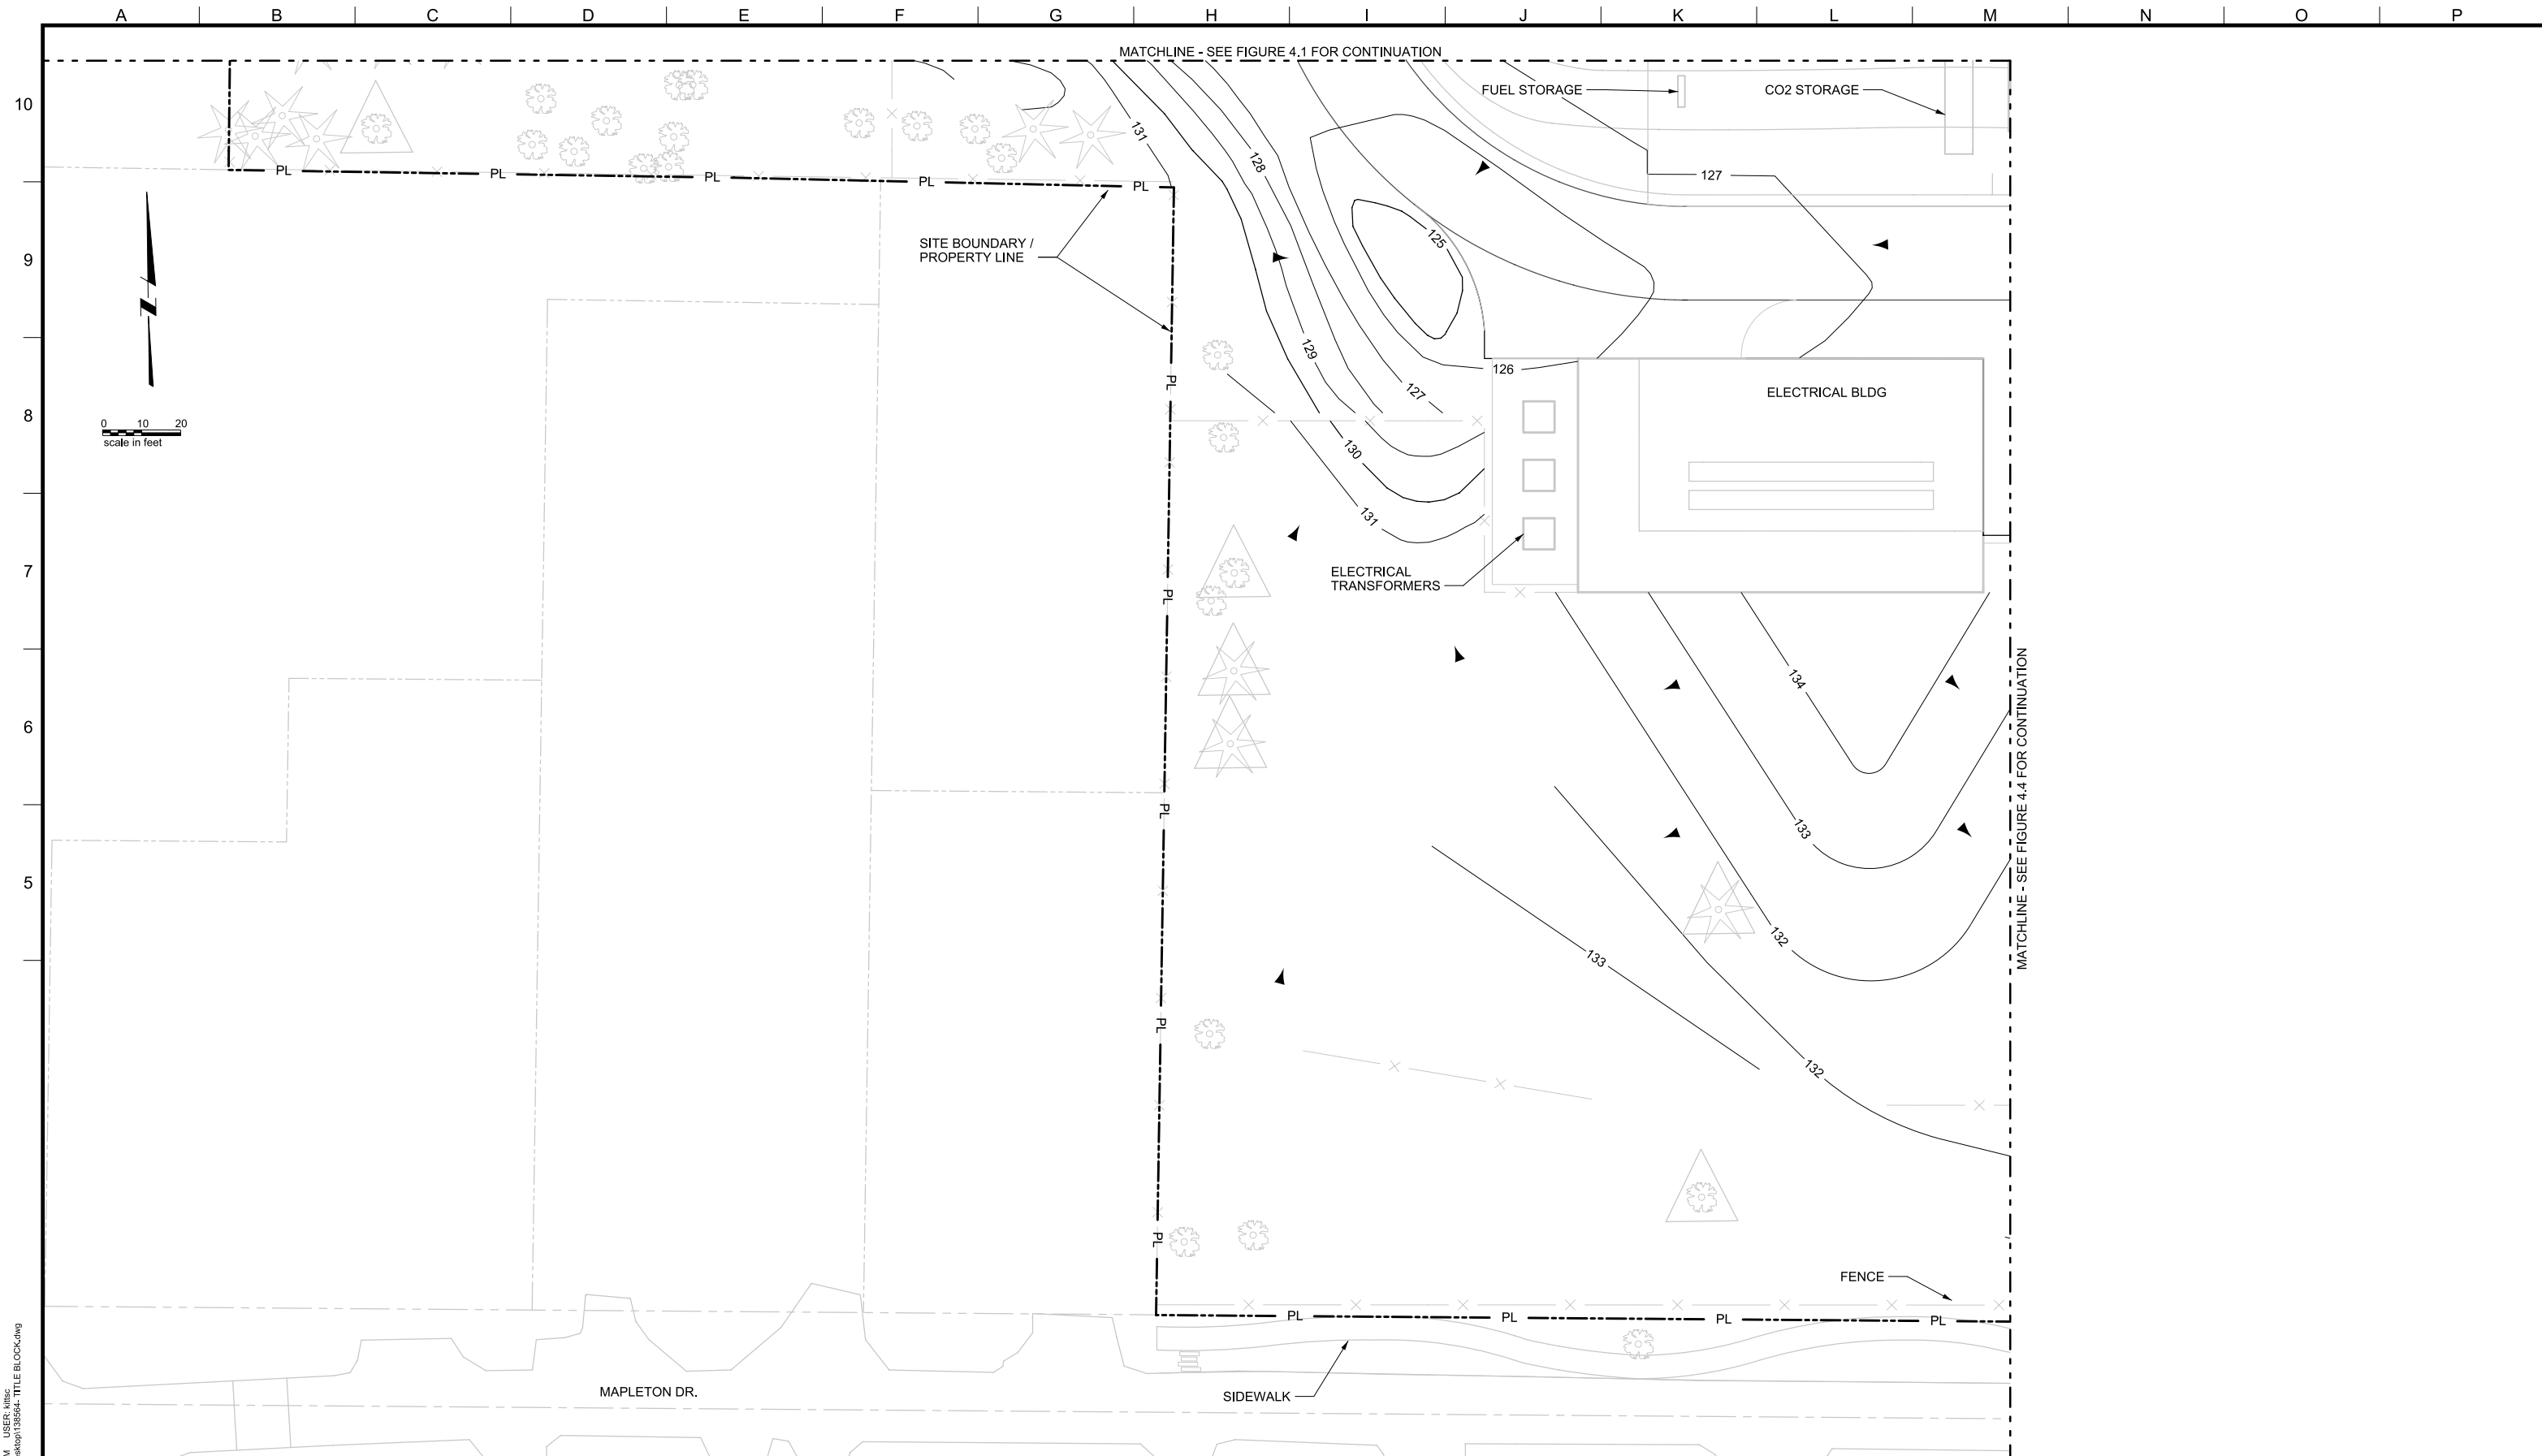
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LAKE OSWEGO AND TIGARD WATER TREATMENT PLANT  
 DESIGN REVIEW AND CONDITIONAL USE  
**GRADING PLAN**  
 AREA A

FILENAME	
PROJECT NUMBER	
SCALE	1" = 20'
DRAWING/FIGURE NUMBER	4.1
### OF	



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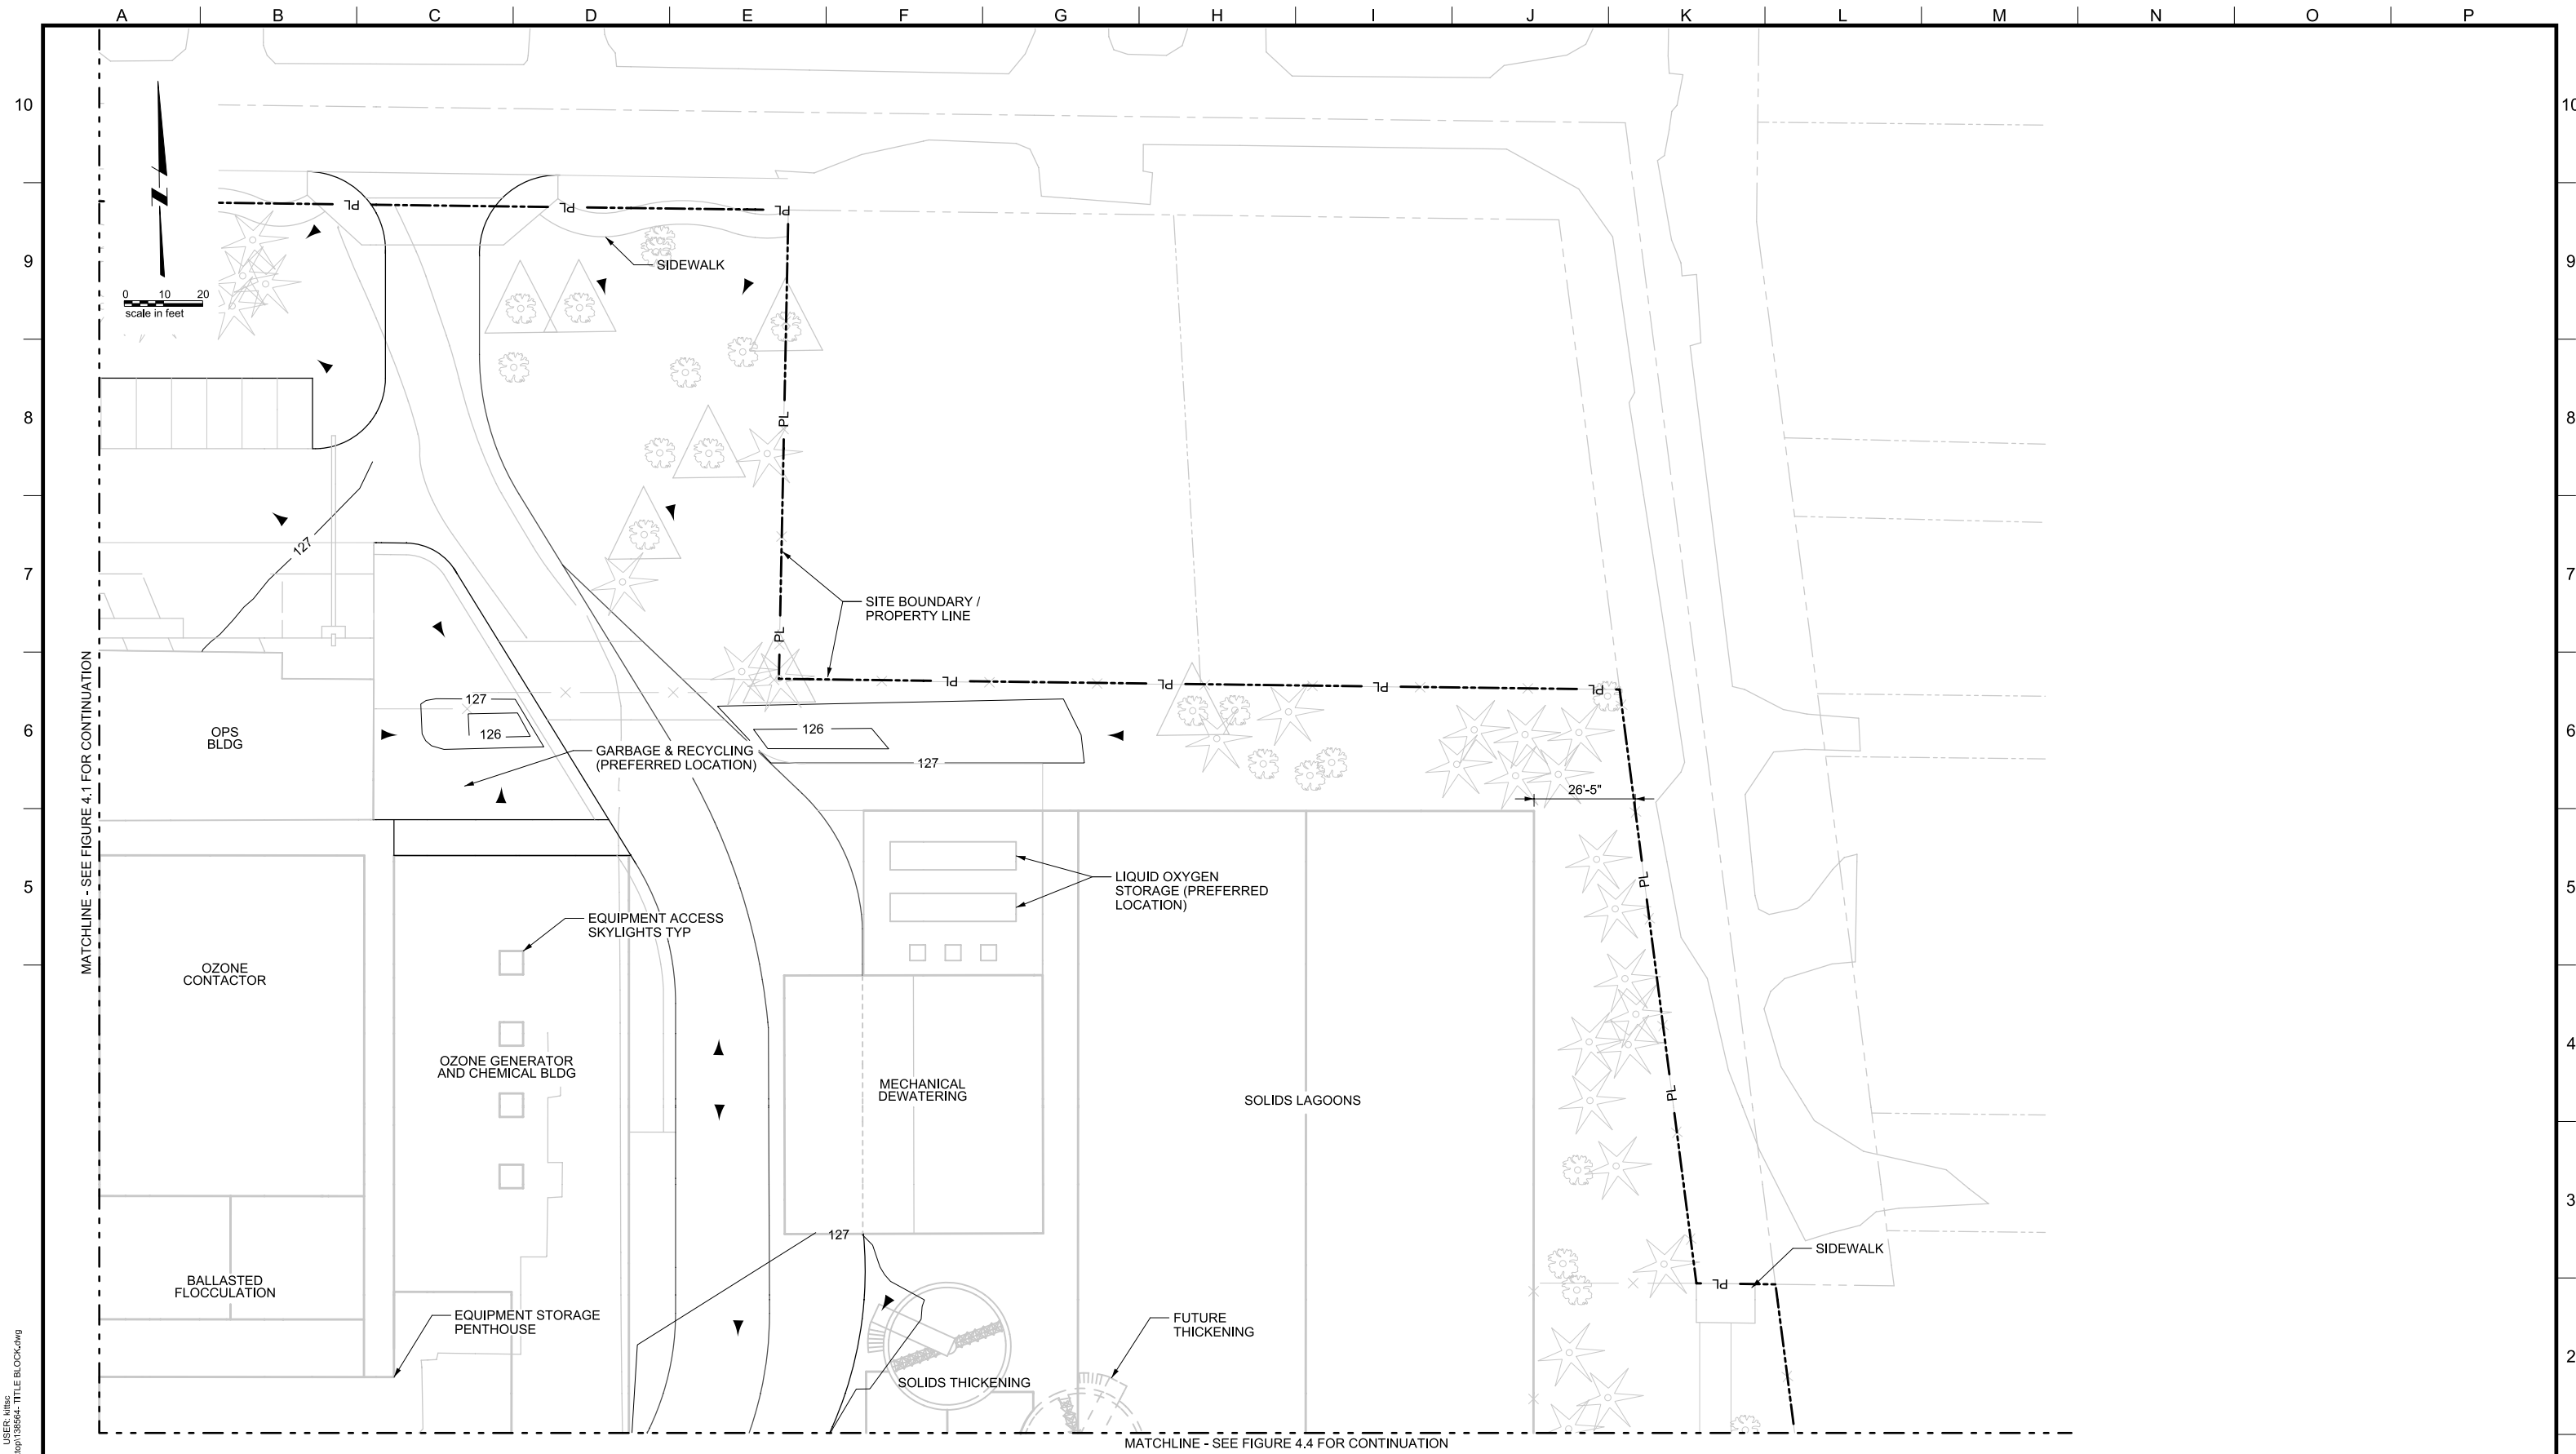
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LAKE OSWEGO AND TIGARD WATER TREATMENT PLANT  
 DESIGN REVIEW AND CONDITIONAL USE  
**GRADING PLAN**  
**AREA B**

FILENAME	
PROJECT NUMBER	
SCALE	1" = 20'
DRAWING/FIGURE NUMBER	4.2
### OF	1





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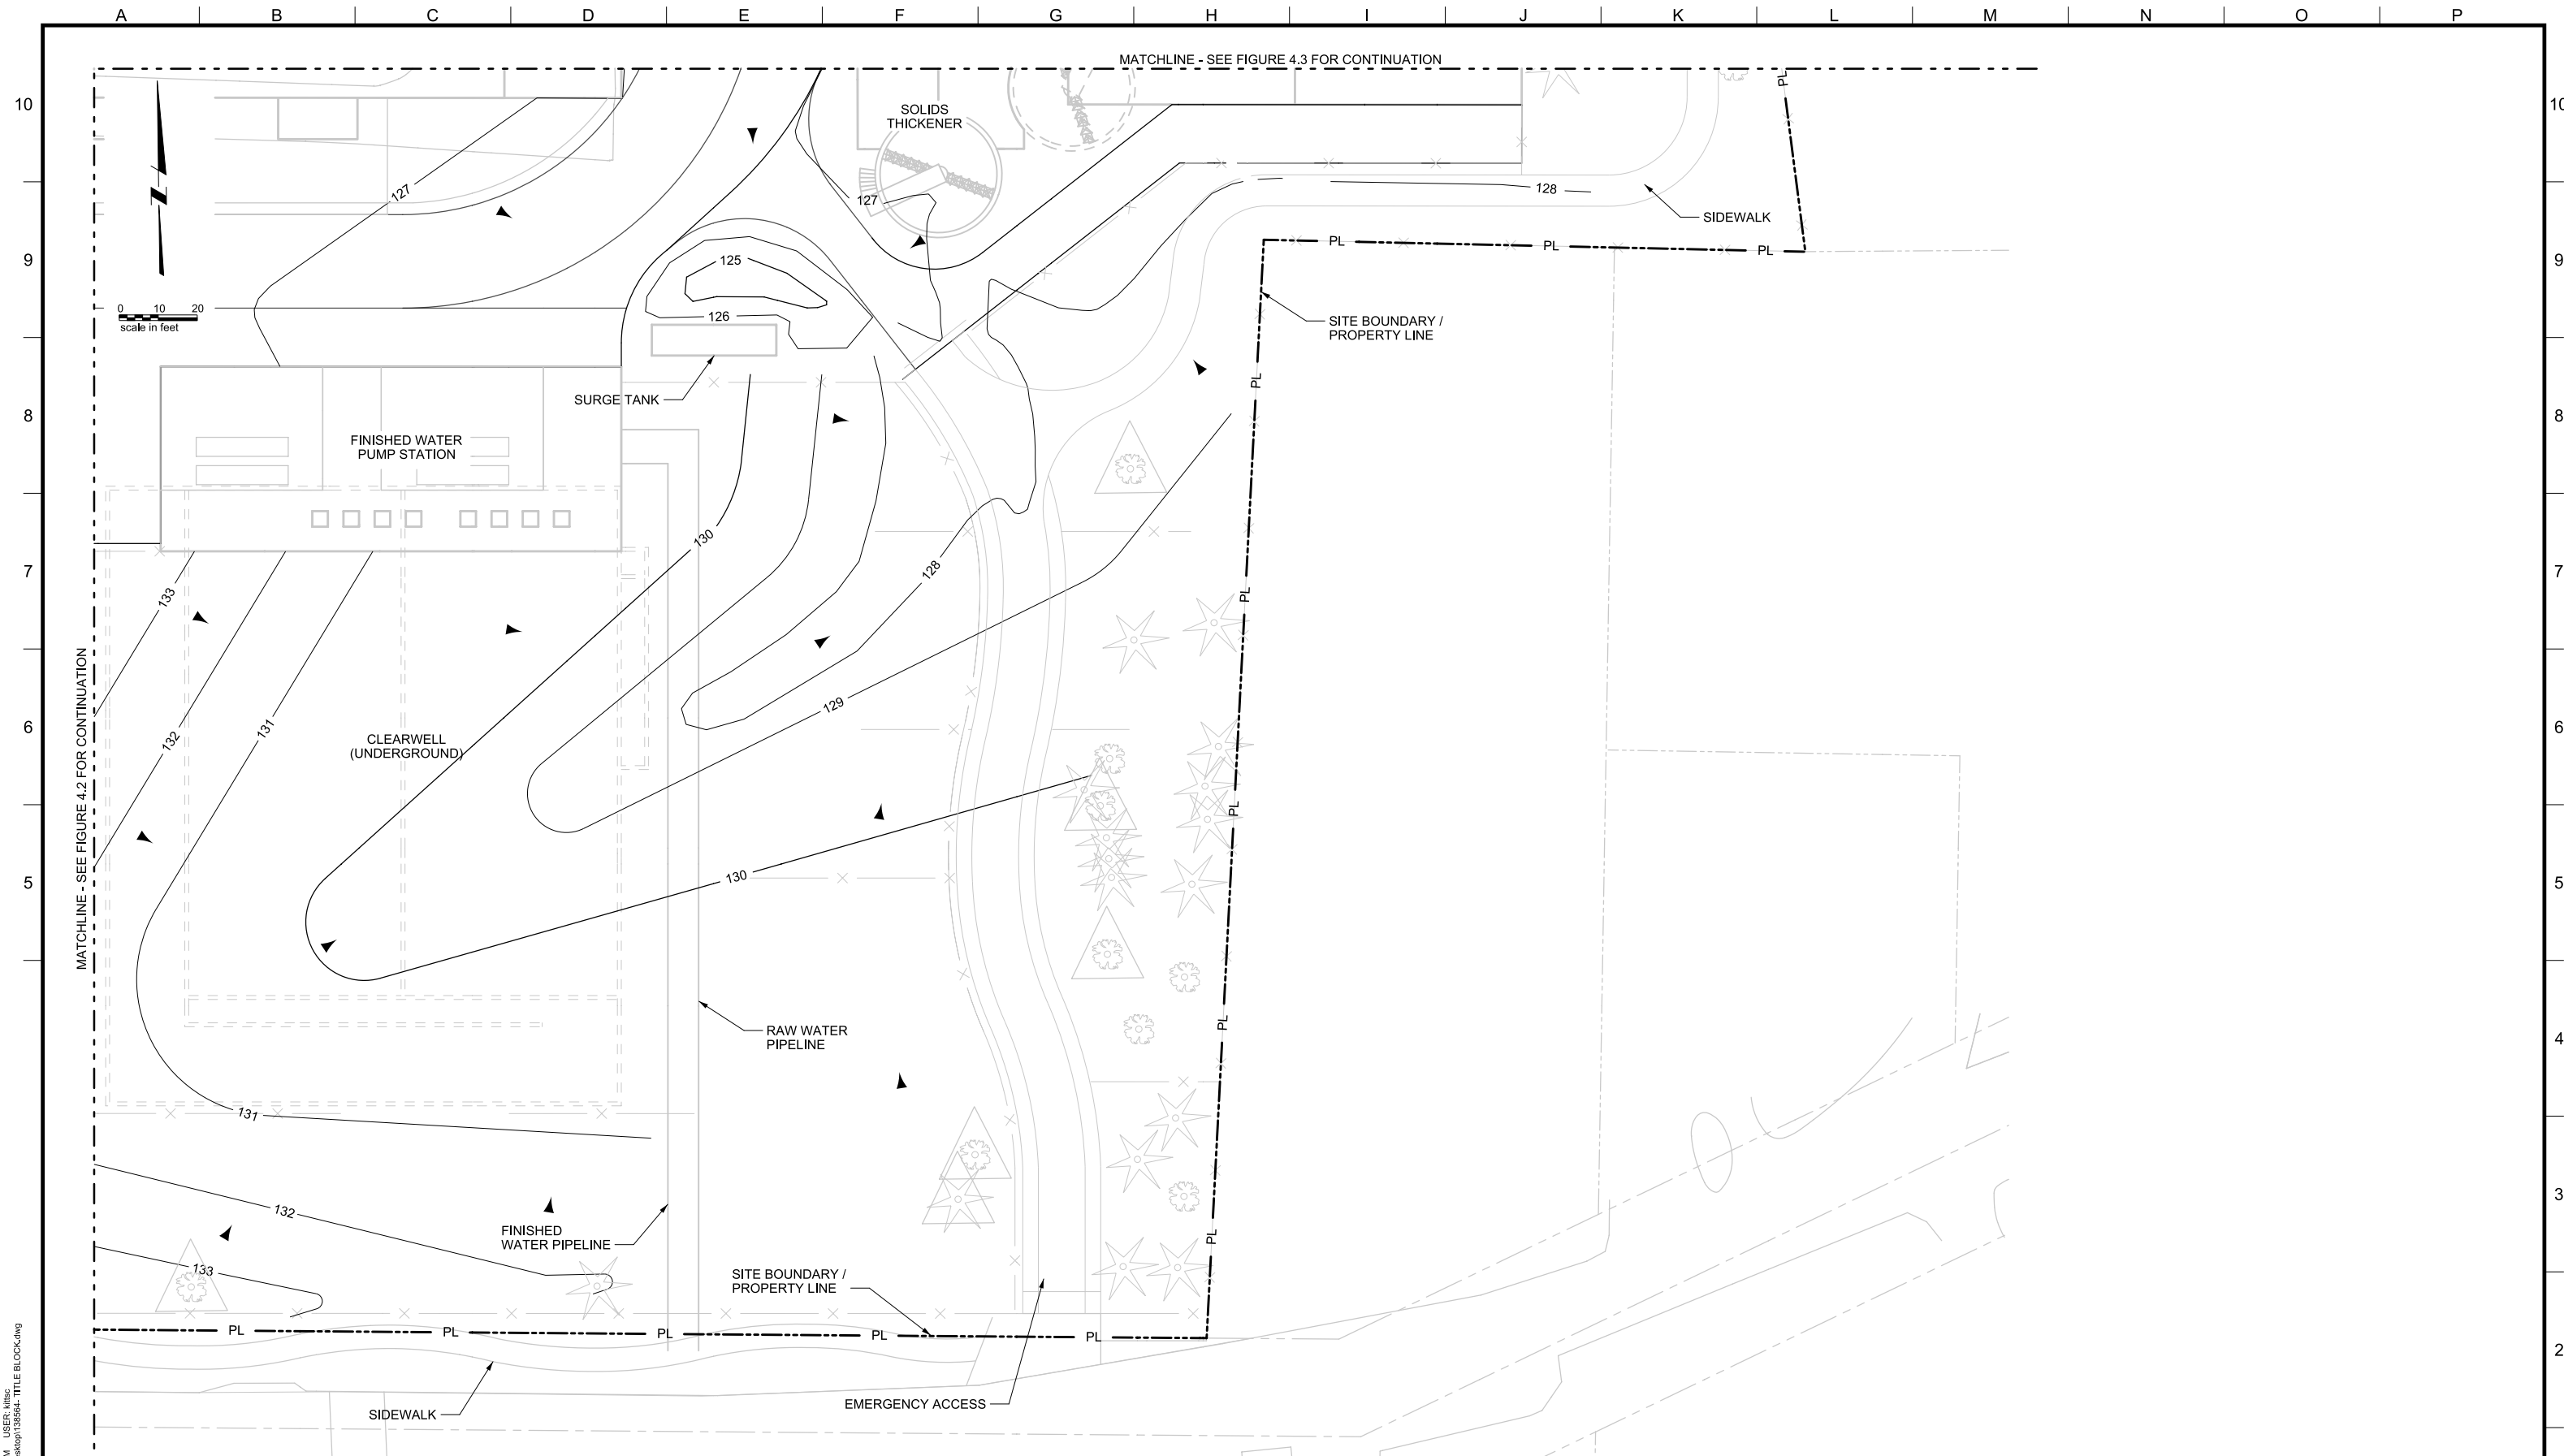
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LAKE OSWEGO AND TIGARD WATER TREATMENT PLANT  
 DESIGN REVIEW AND CONDITIONAL USE  
**GRADING PLAN**  
 AREA C

FILENAME	
PROJECT NUMBER	1
SCALE	1" = 20'
DRAWING/FIGURE NUMBER	4.3
### OF	



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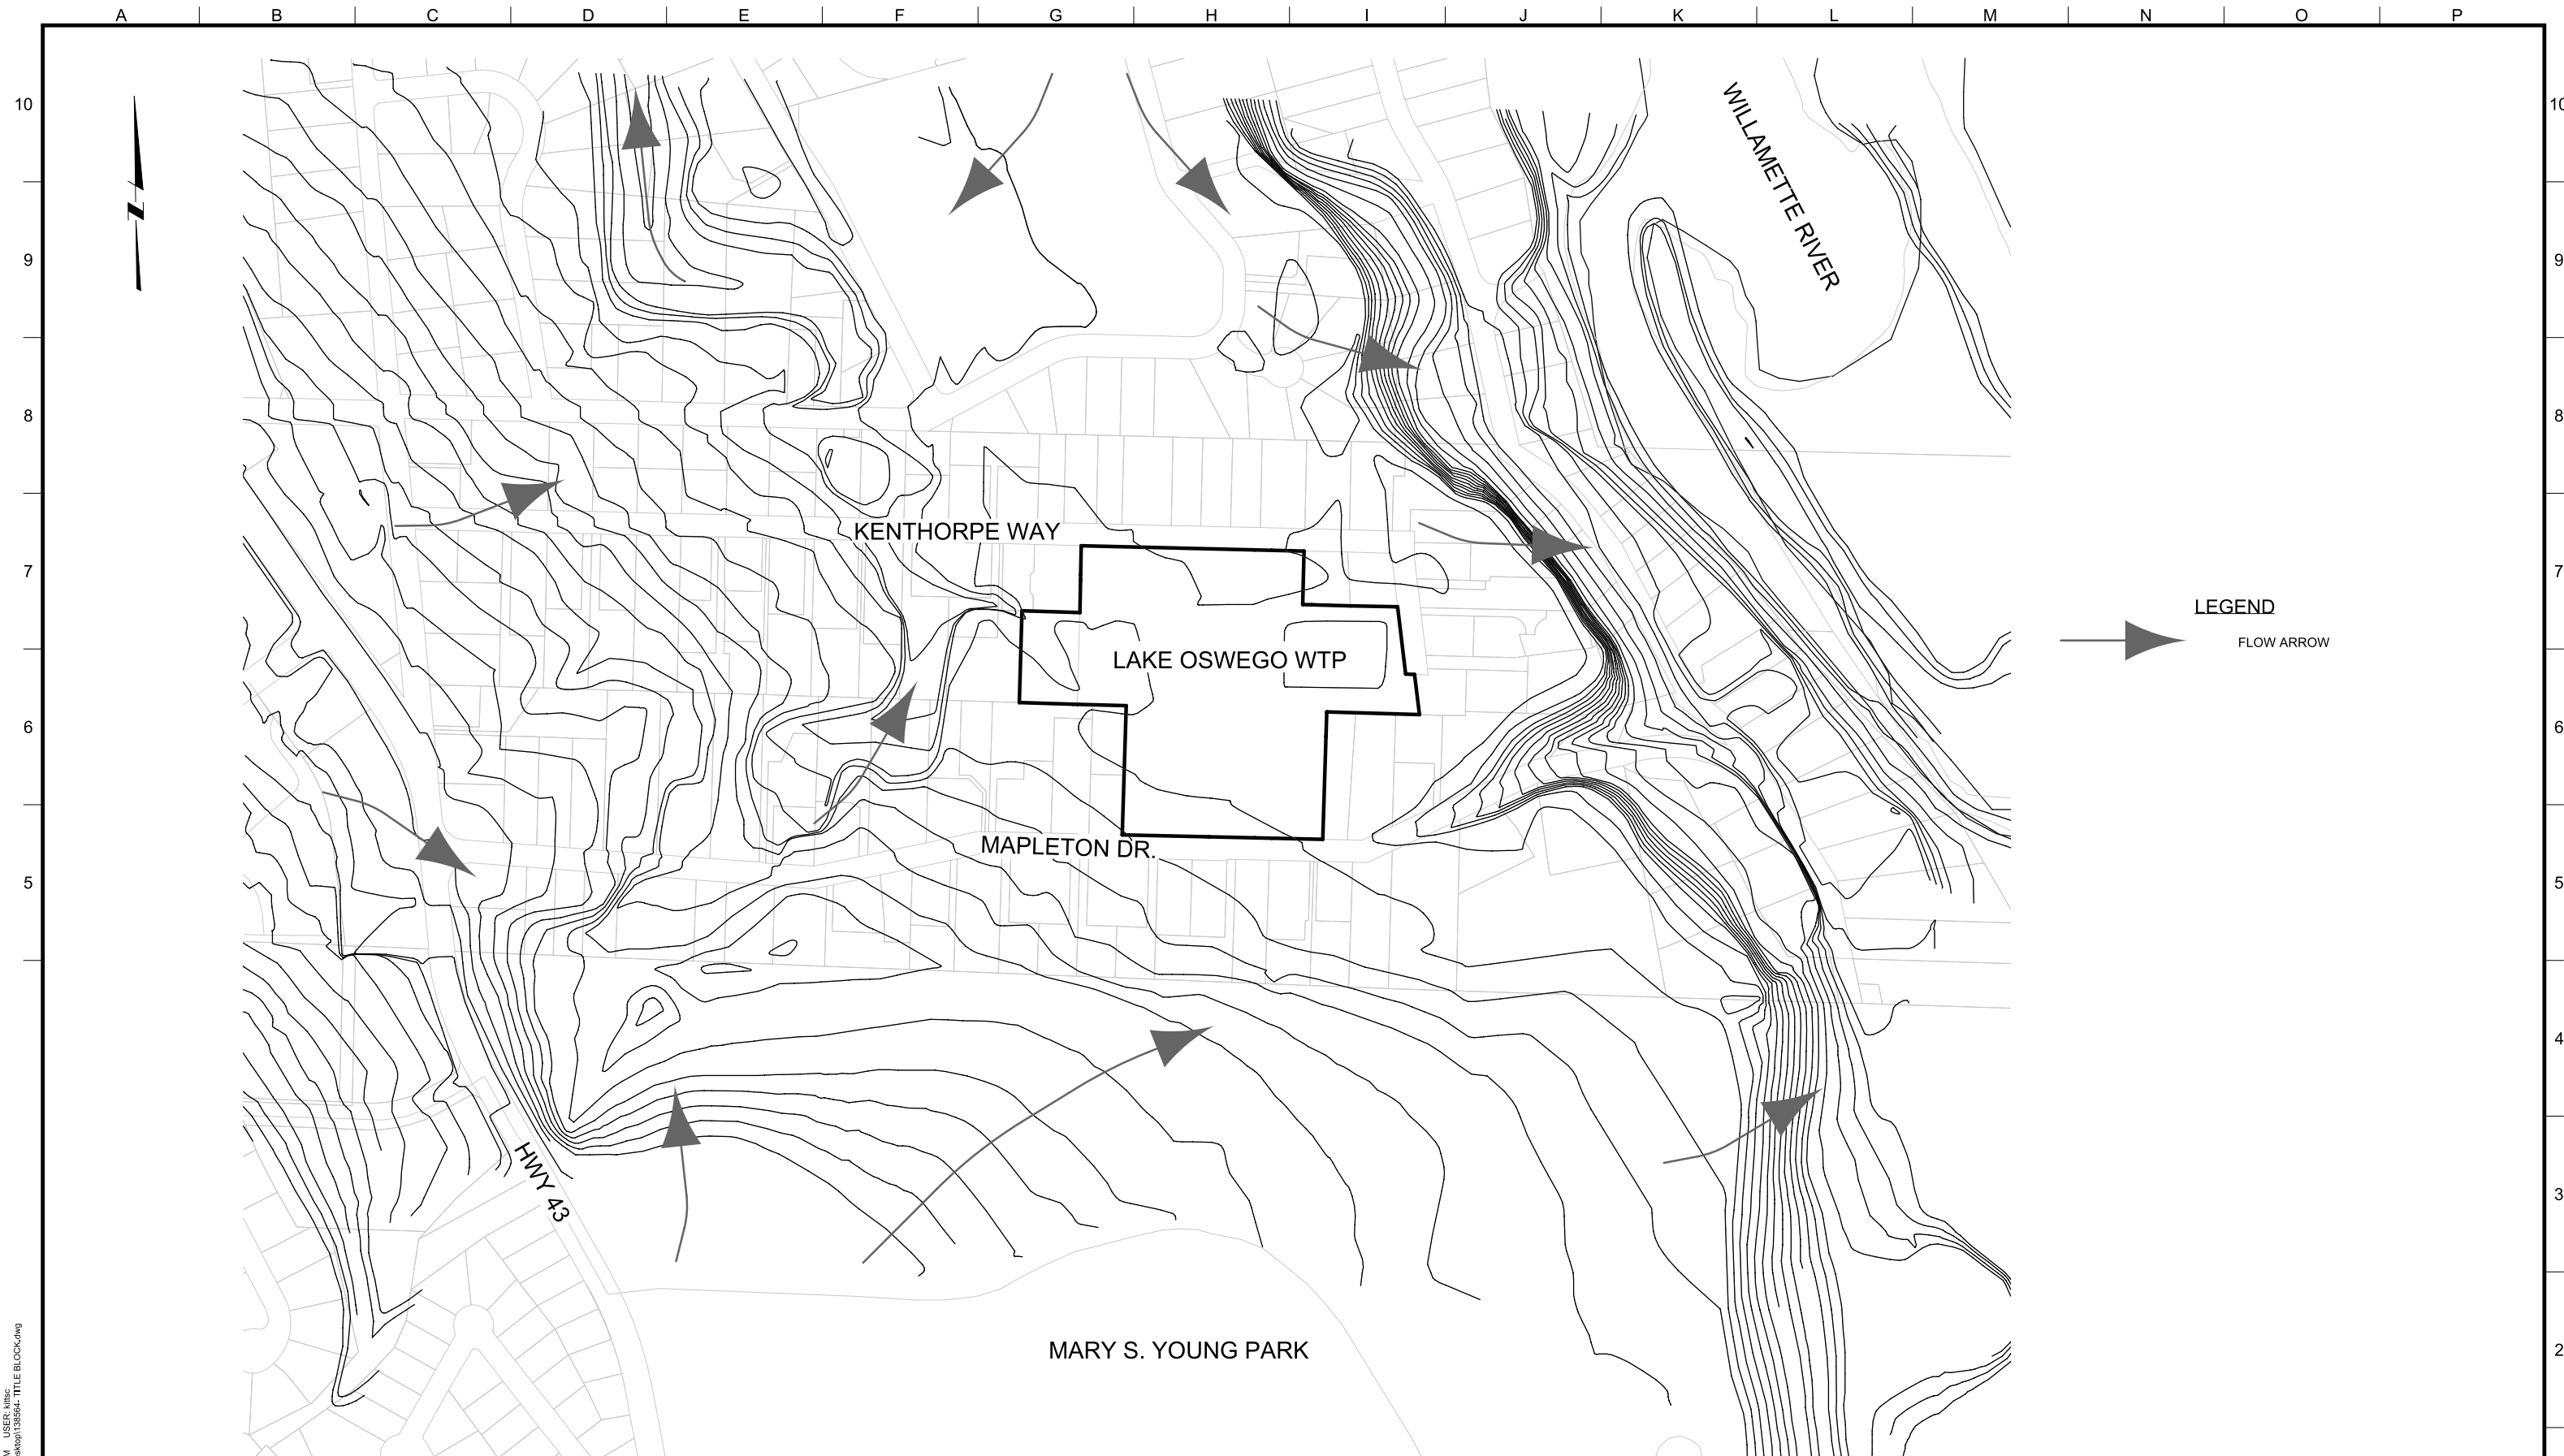
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LAKE OSWEGO AND TIGARD WATER TREATMENT PLANT  
 DESIGN REVIEW AND CONDITIONAL USE  
**GRADING PLAN**  
 AREA D

FILENAME	
PROJECT NUMBER	
SCALE	1" = 20'
DRAWING/FIGURE NUMBER	4.4
### OF	1



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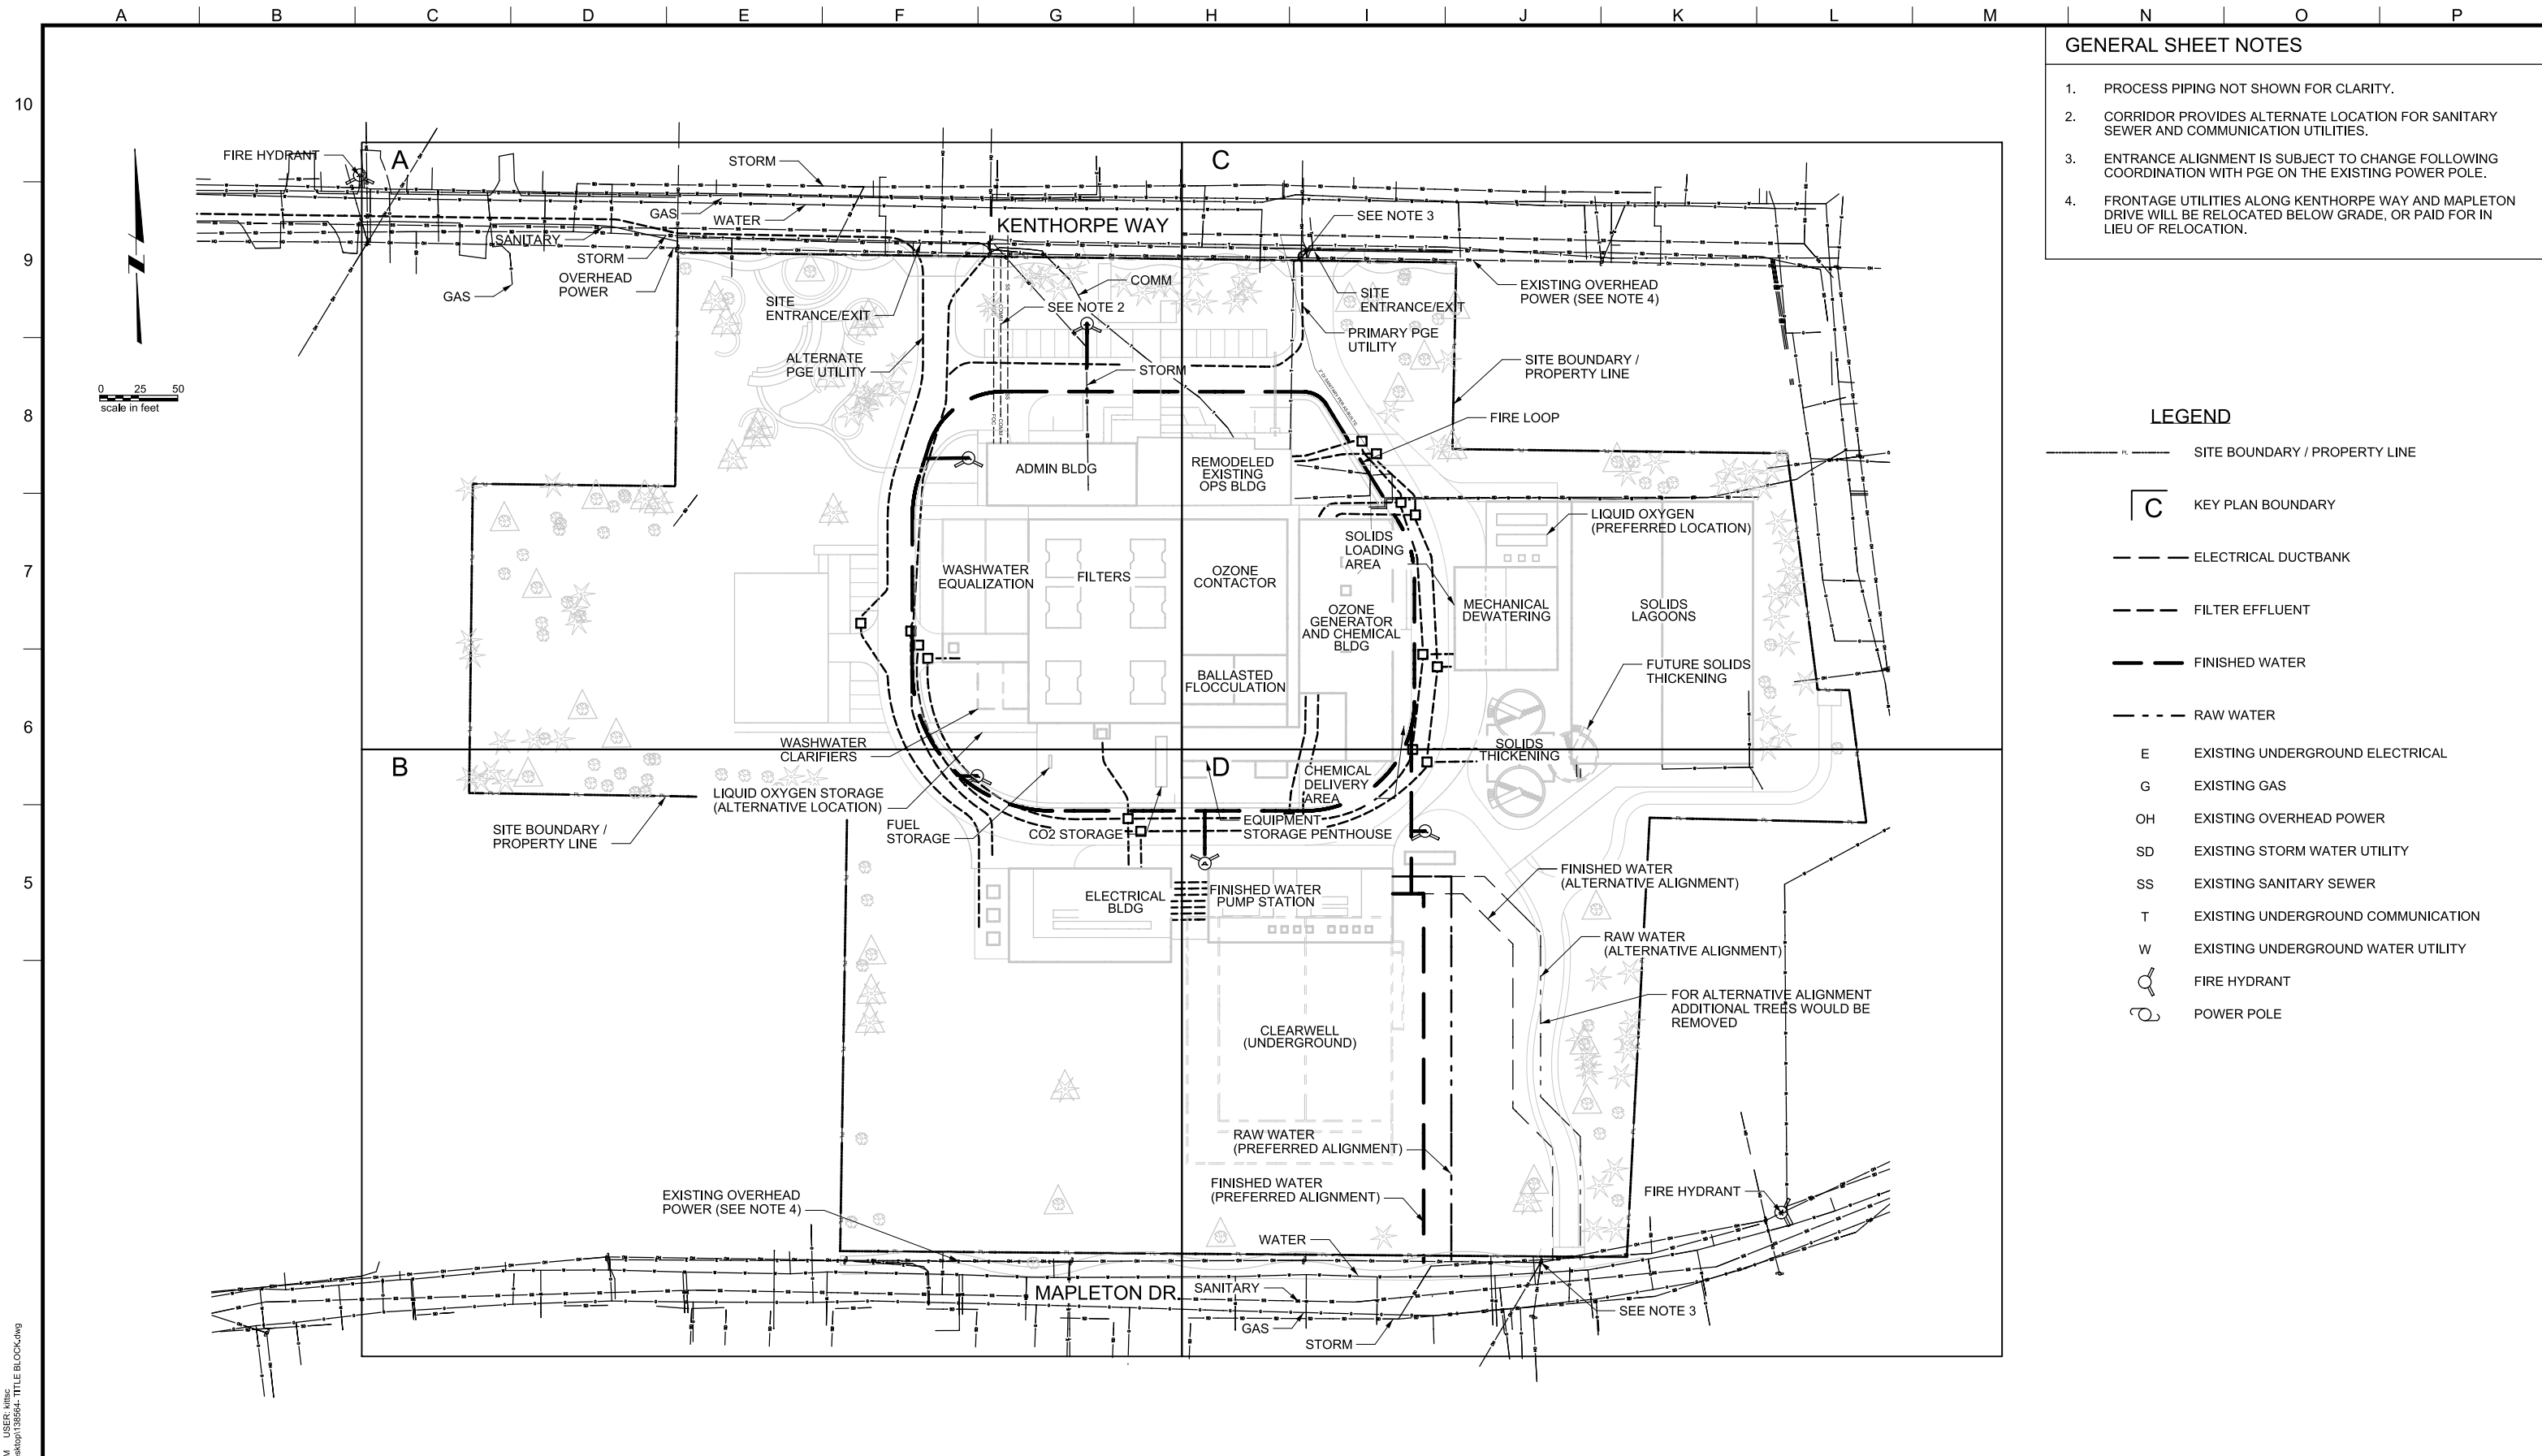
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LAKE OSWEGO AND TIGARD WATER TREATMENT PLANT  
 DESIGN REVIEW AND CONDITIONAL USE  
**GRADING PLAN**  
 SURROUNDING DRAINAGE

FILENAME	
PROJECT NUMBER	
SCALE	
DRAWING/FIGURE NUMBER	4.5
### OF	1



- GENERAL SHEET NOTES**
1. PROCESS PIPING NOT SHOWN FOR CLARITY.
  2. CORRIDOR PROVIDES ALTERNATE LOCATION FOR SANITARY SEWER AND COMMUNICATION UTILITIES.
  3. ENTRANCE ALIGNMENT IS SUBJECT TO CHANGE FOLLOWING COORDINATION WITH PGE ON THE EXISTING POWER POLE.
  4. FRONTAGE UTILITIES ALONG KENTHORPE WAY AND MAPLETON DRIVE WILL BE RELOCATED BELOW GRADE, OR PAID FOR IN LIEU OF RELOCATION.

- LEGEND**
- SITE BOUNDARY / PROPERTY LINE
  - [C] KEY PLAN BOUNDARY
  - ELECTRICAL DUCTBANK
  - FILTER EFFLUENT
  - FINISHED WATER
  - RAW WATER
  - E EXISTING UNDERGROUND ELECTRICAL
  - G EXISTING GAS
  - OH EXISTING OVERHEAD POWER
  - SD EXISTING STORM WATER UTILITY
  - SS EXISTING SANITARY SEWER
  - T EXISTING UNDERGROUND COMMUNICATION
  - W EXISTING UNDERGROUND WATER UTILITY
  - ⊕ FIRE HYDRANT
  - ⊙ POWER POLE

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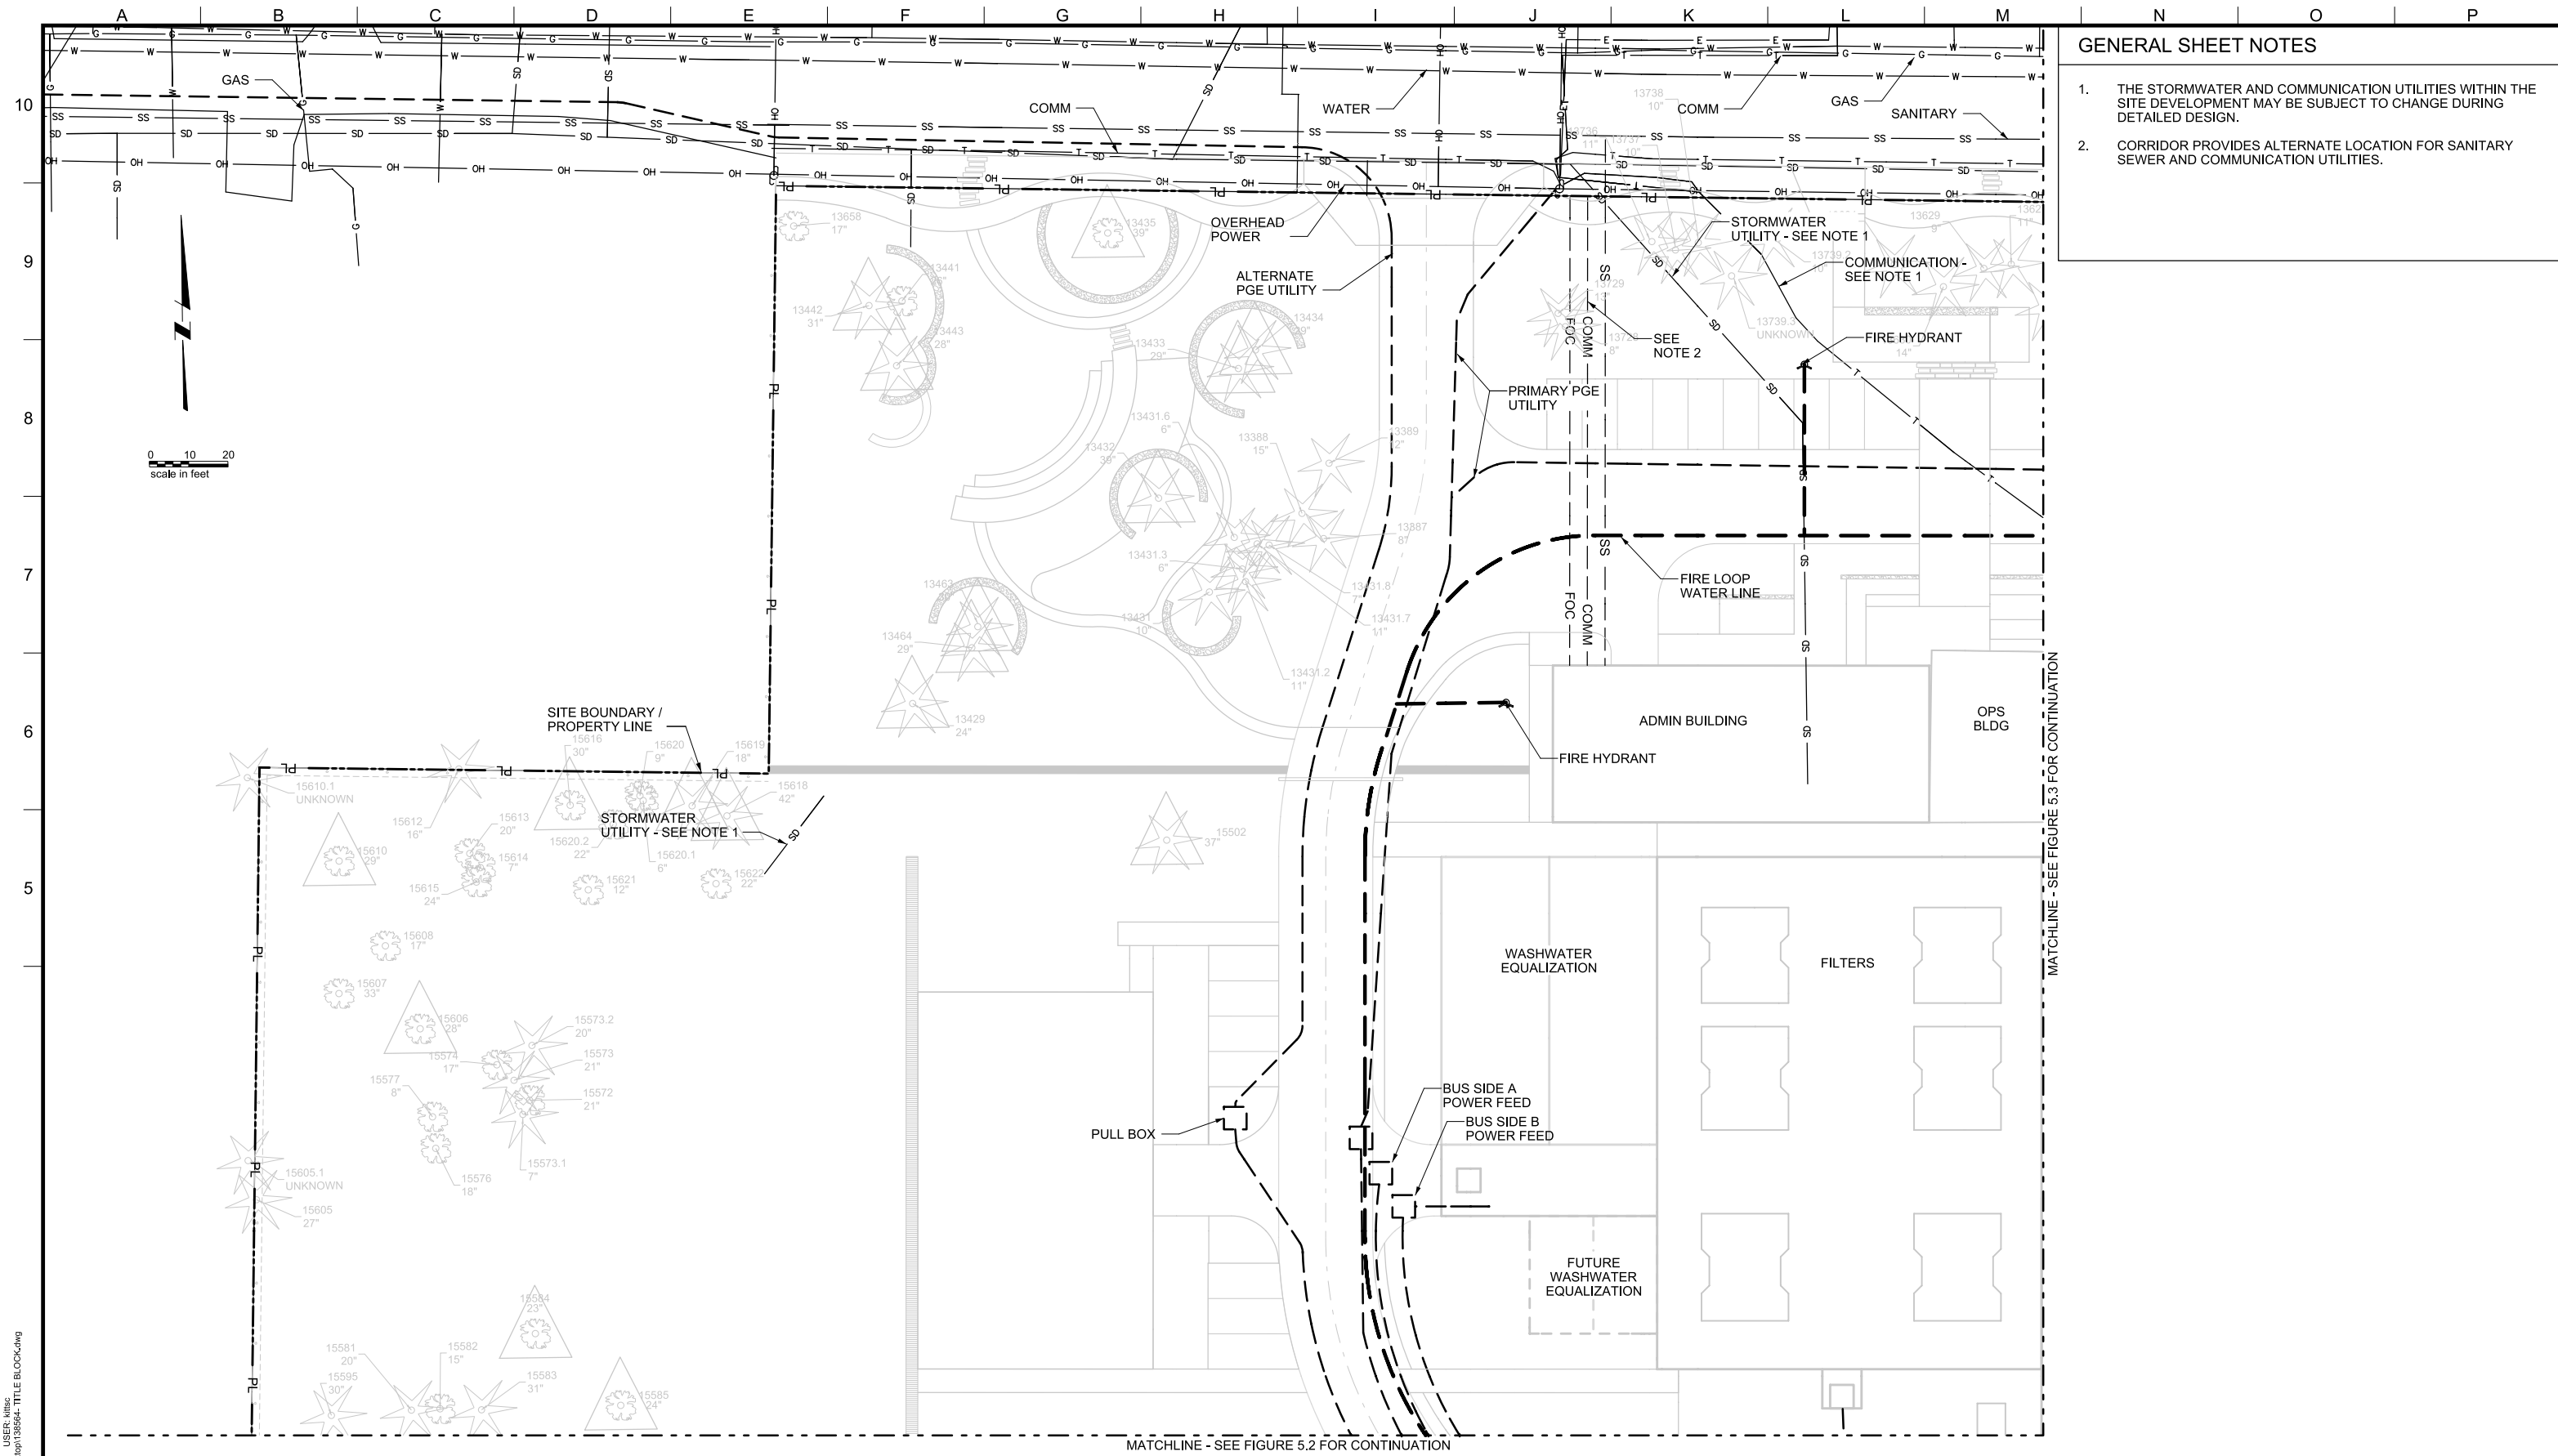
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LAKE OSWEGO AND TIGARD WATER TREATMENT PLANT  
 DESIGN REVIEW AND CONDITIONAL USE

**UTILITY PLAN  
 OVERVIEW**

FILENAME	
PROJECT NUMBER	
SCALE	1" = 50'
DRAWING/FIGURE NUMBER	5.0
#### OF	



- GENERAL SHEET NOTES**
1. THE STORMWATER AND COMMUNICATION UTILITIES WITHIN THE SITE DEVELOPMENT MAY BE SUBJECT TO CHANGE DURING DETAILED DESIGN.
  2. CORRIDOR PROVIDES ALTERNATE LOCATION FOR SANITARY SEWER AND COMMUNICATION UTILITIES.

MATCHLINE - SEE FIGURE 5.3 FOR CONTINUATION

MATCHLINE - SEE FIGURE 5.2 FOR CONTINUATION

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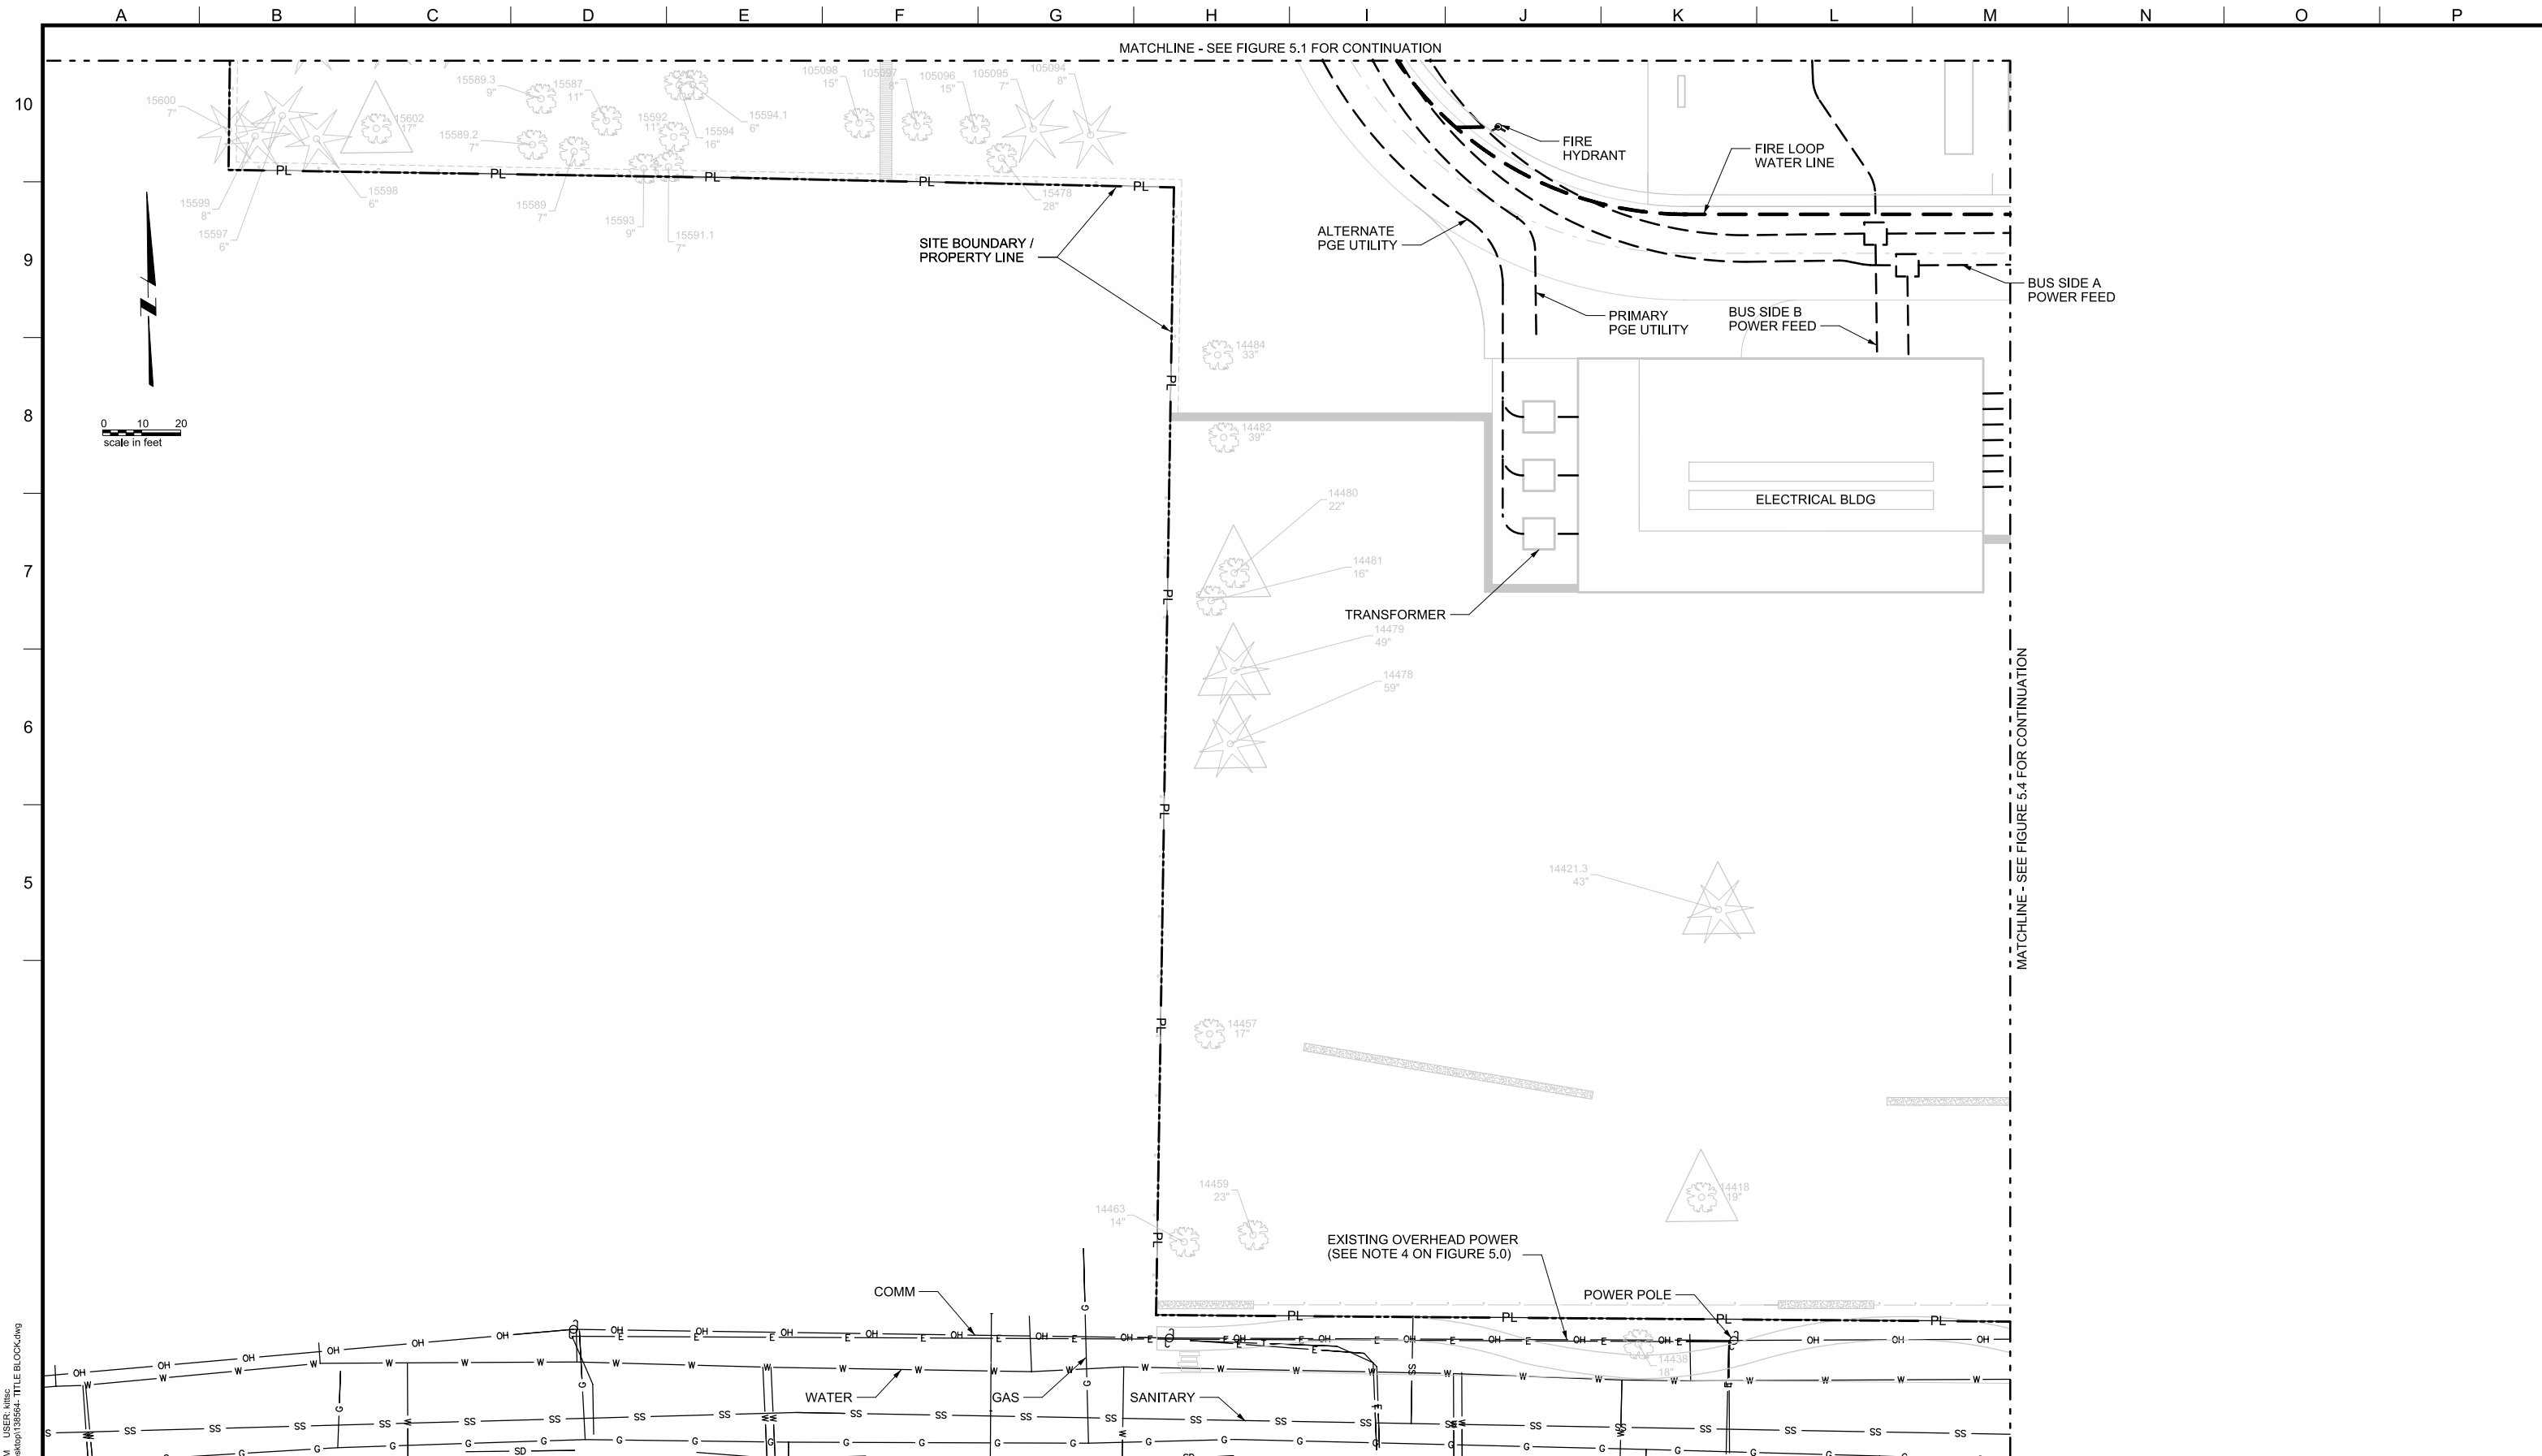
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LAKE OSWEGO AND TIGARD WATER TREATMENT PLANT  
DESIGN REVIEW AND CONDITIONAL USE  
**UTILITY PLAN  
AREA A**

FILENAME	
PROJECT NUMBER	
SCALE	1" = 20'
DRAWING/FIGURE NUMBER	5.1
### OF	



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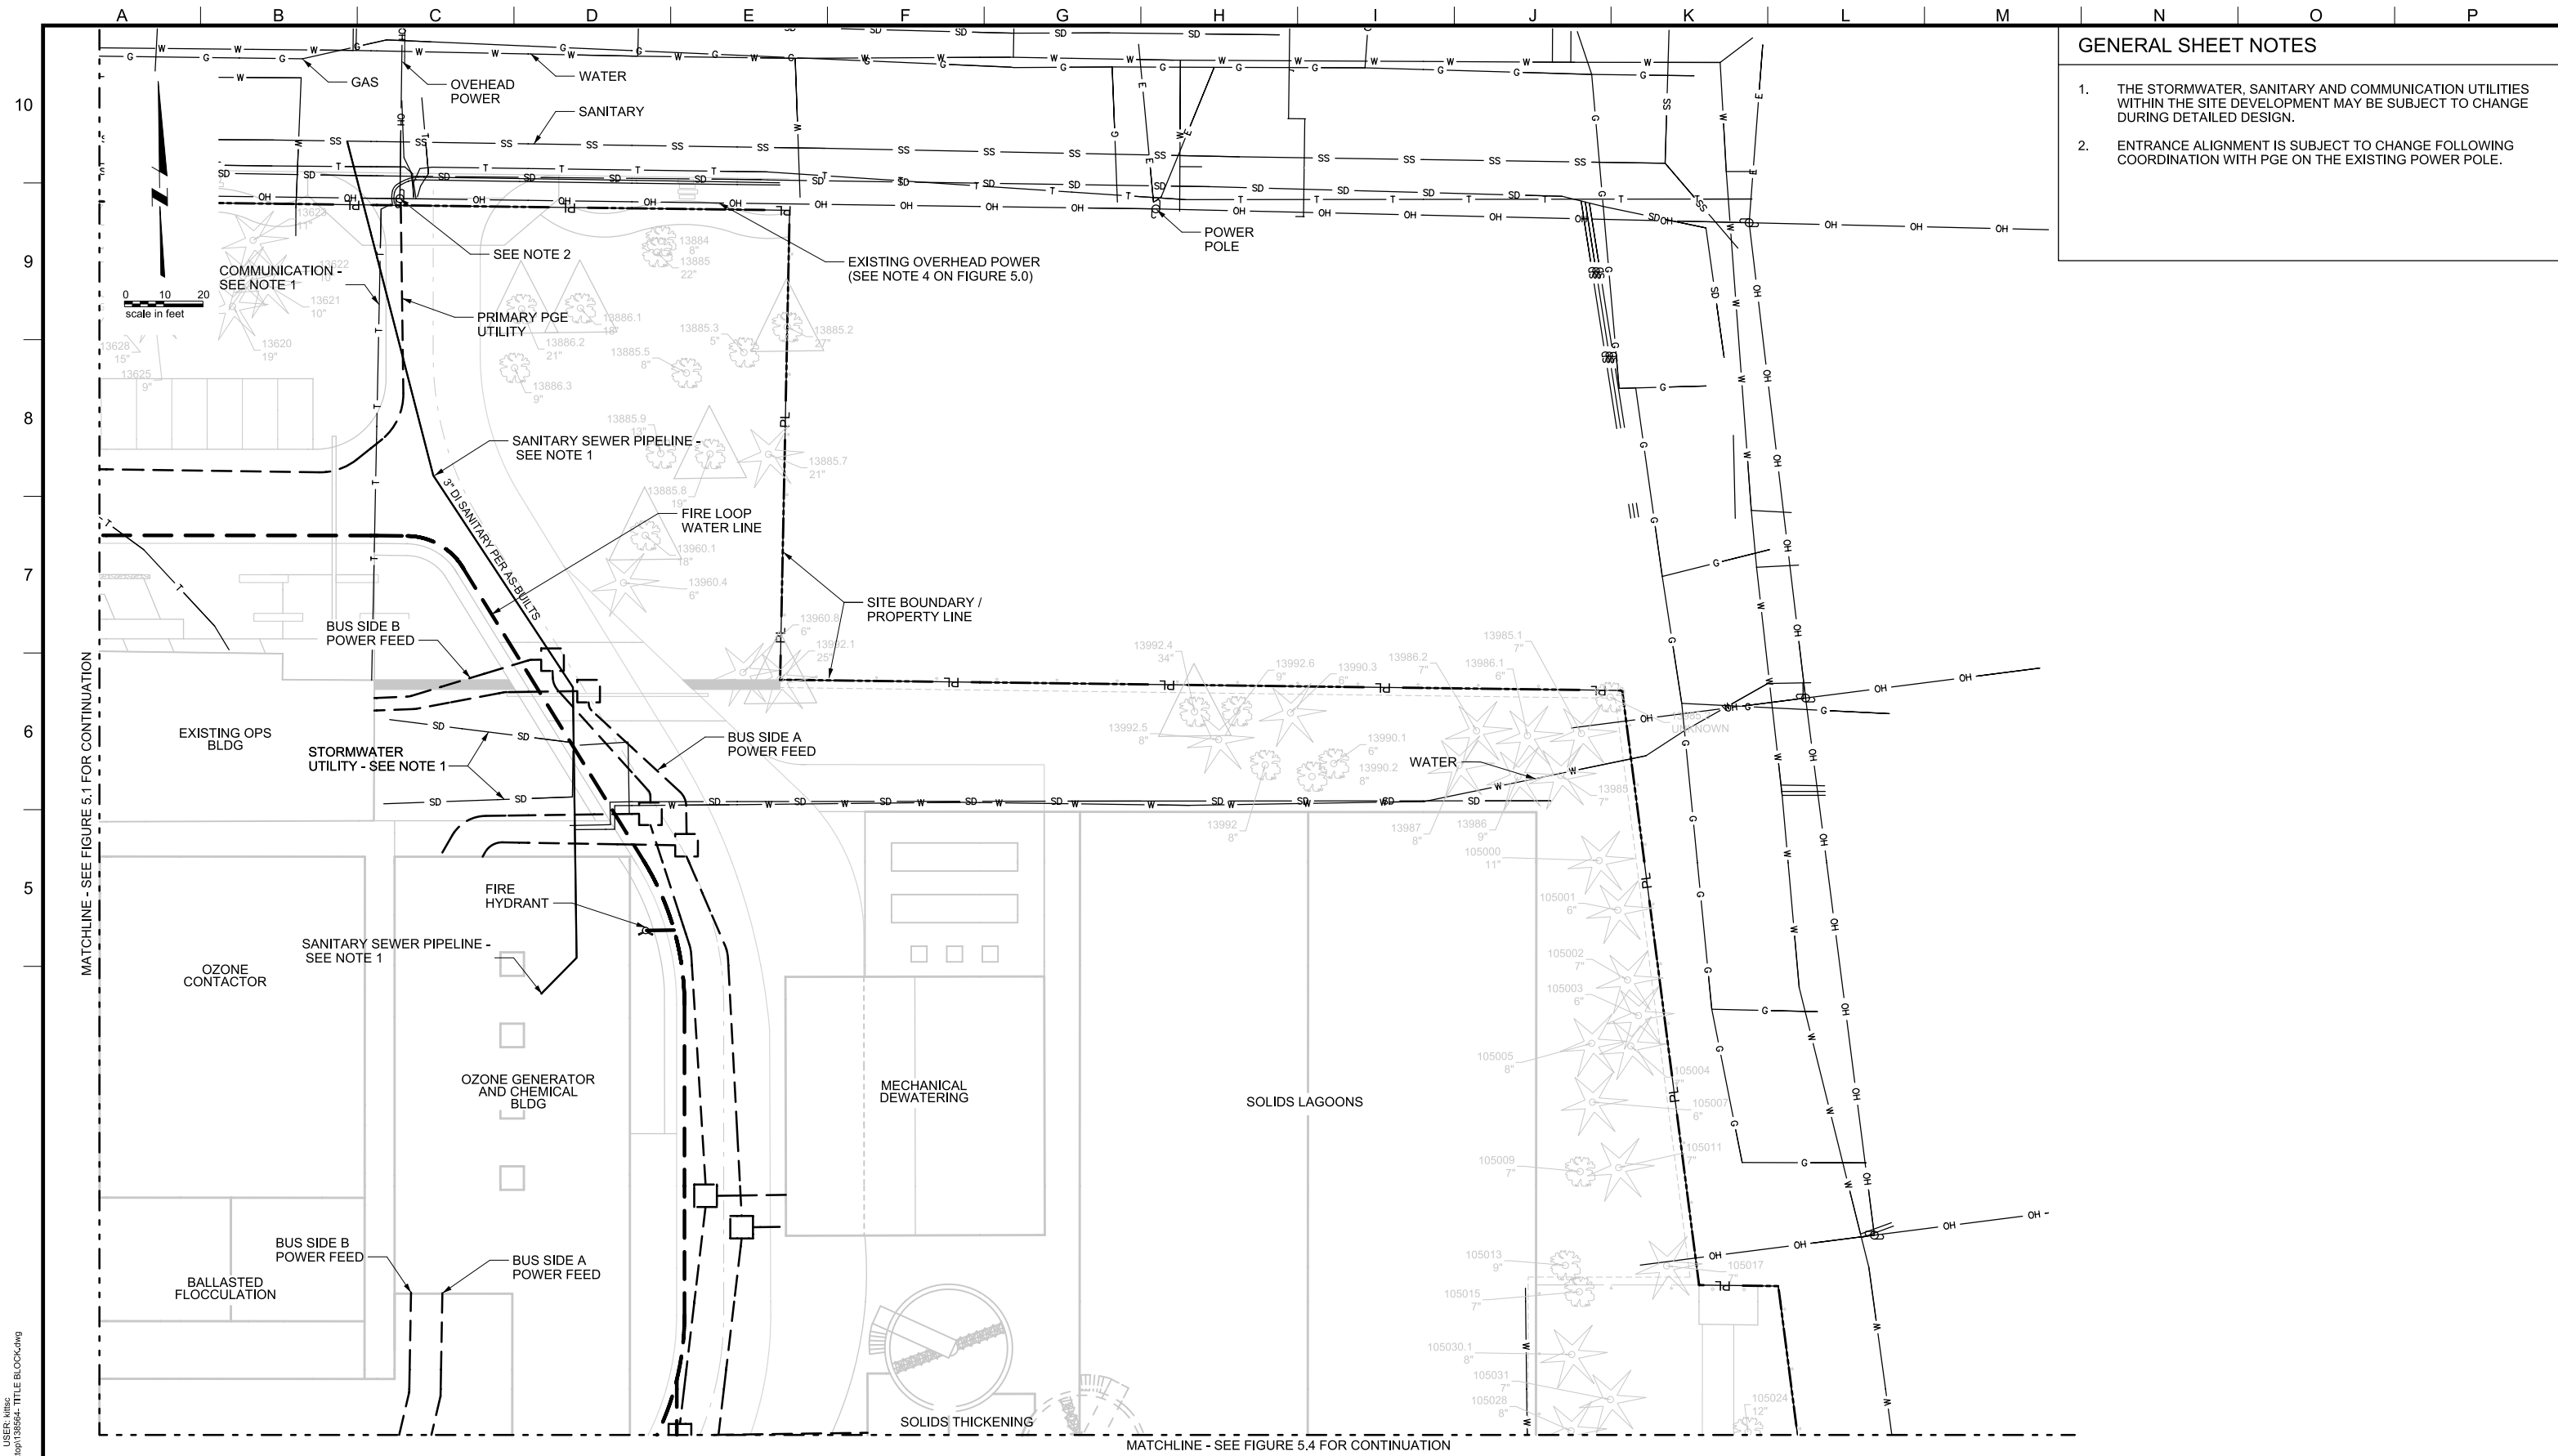
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LAKE OSWEGO AND TIGARD WATER TREATMENT PLANT  
 DESIGN REVIEW AND CONDITIONAL USE  
**UTILITY PLAN  
 AREA B**

FILENAME	
PROJECT NUMBER	
SCALE	1" = 20'
DRAWING/FIGURE NUMBER	5.2
### OF	

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**GENERAL SHEET NOTES**

1. THE STORMWATER, SANITARY AND COMMUNICATION UTILITIES WITHIN THE SITE DEVELOPMENT MAY BE SUBJECT TO CHANGE DURING DETAILED DESIGN.
2. ENTRANCE ALIGNMENT IS SUBJECT TO CHANGE FOLLOWING COORDINATION WITH PGE ON THE EXISTING POWER POLE.

MATCHLINE - SEE FIGURE 5.1 FOR CONTINUATION

MATCHLINE - SEE FIGURE 5.4 FOR CONTINUATION

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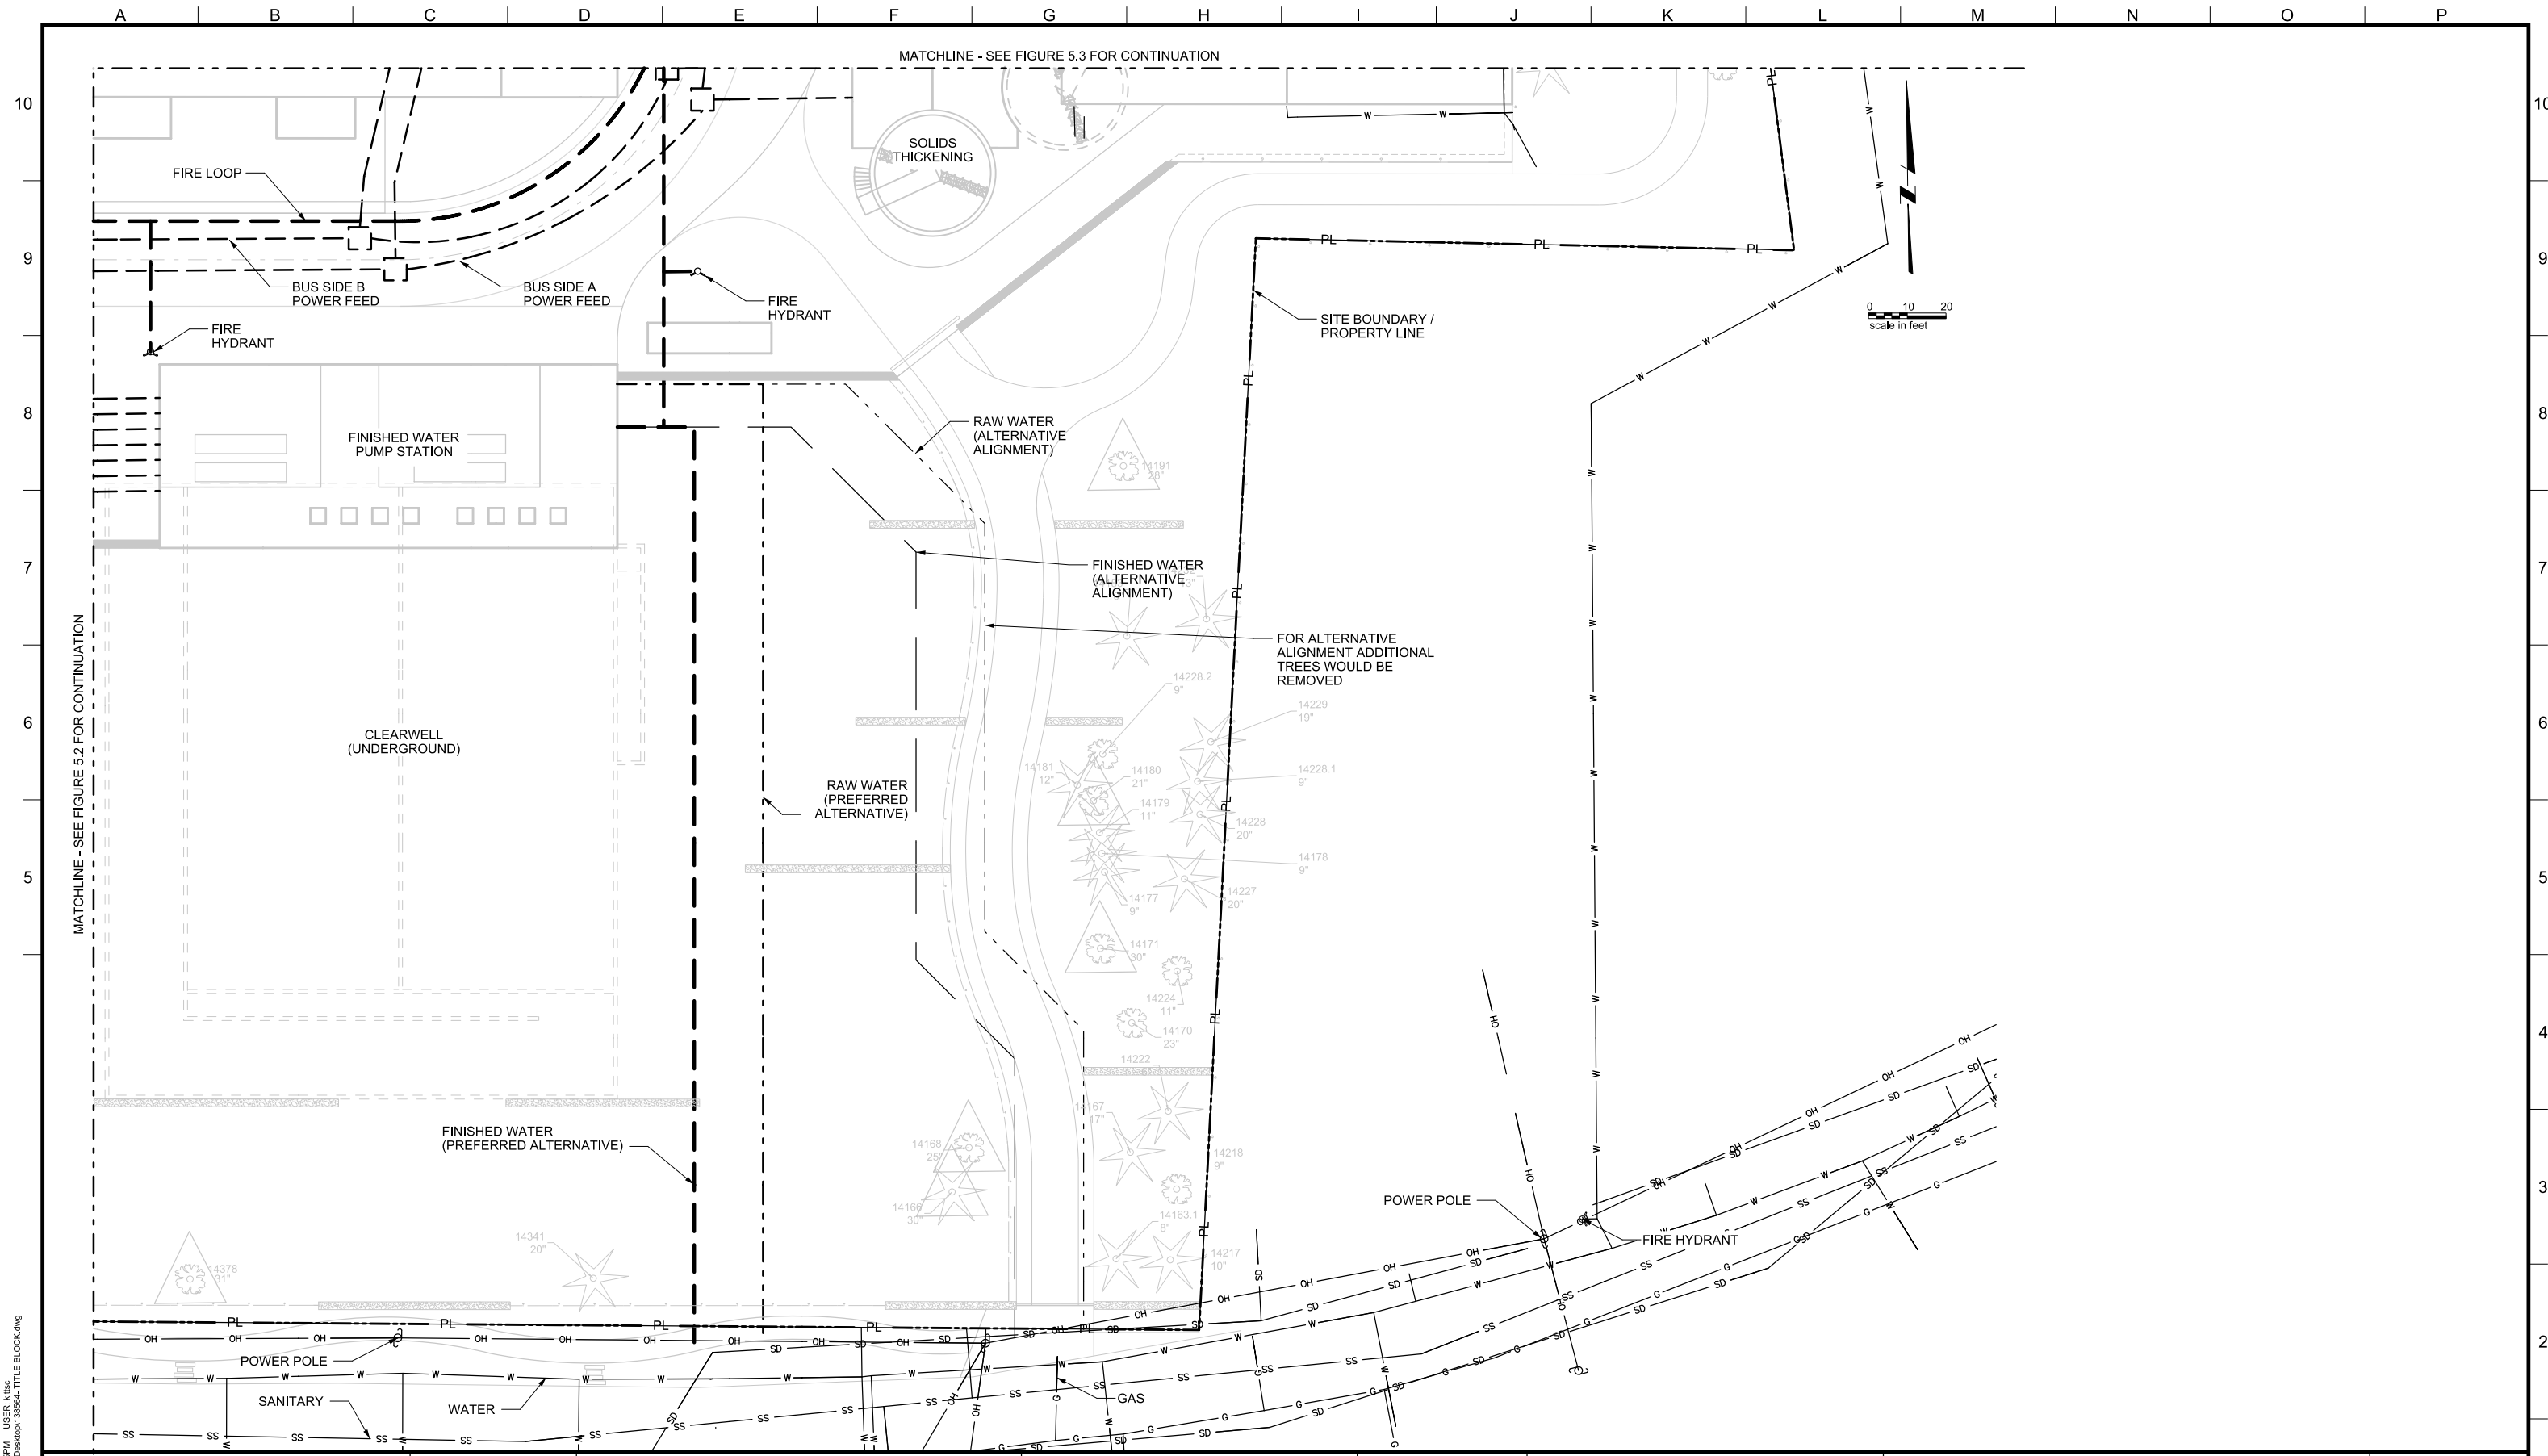
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LAKE OSWEGO AND TIGARD WATER TREATMENT PLANT  
 DESIGN REVIEW AND CONDITIONAL USE  
**UTILITY PLAN**  
 AREA C

FILENAME	
PROJECT NUMBER	
SCALE	1" = 20'
DRAWING/FIGURE NUMBER	5.3
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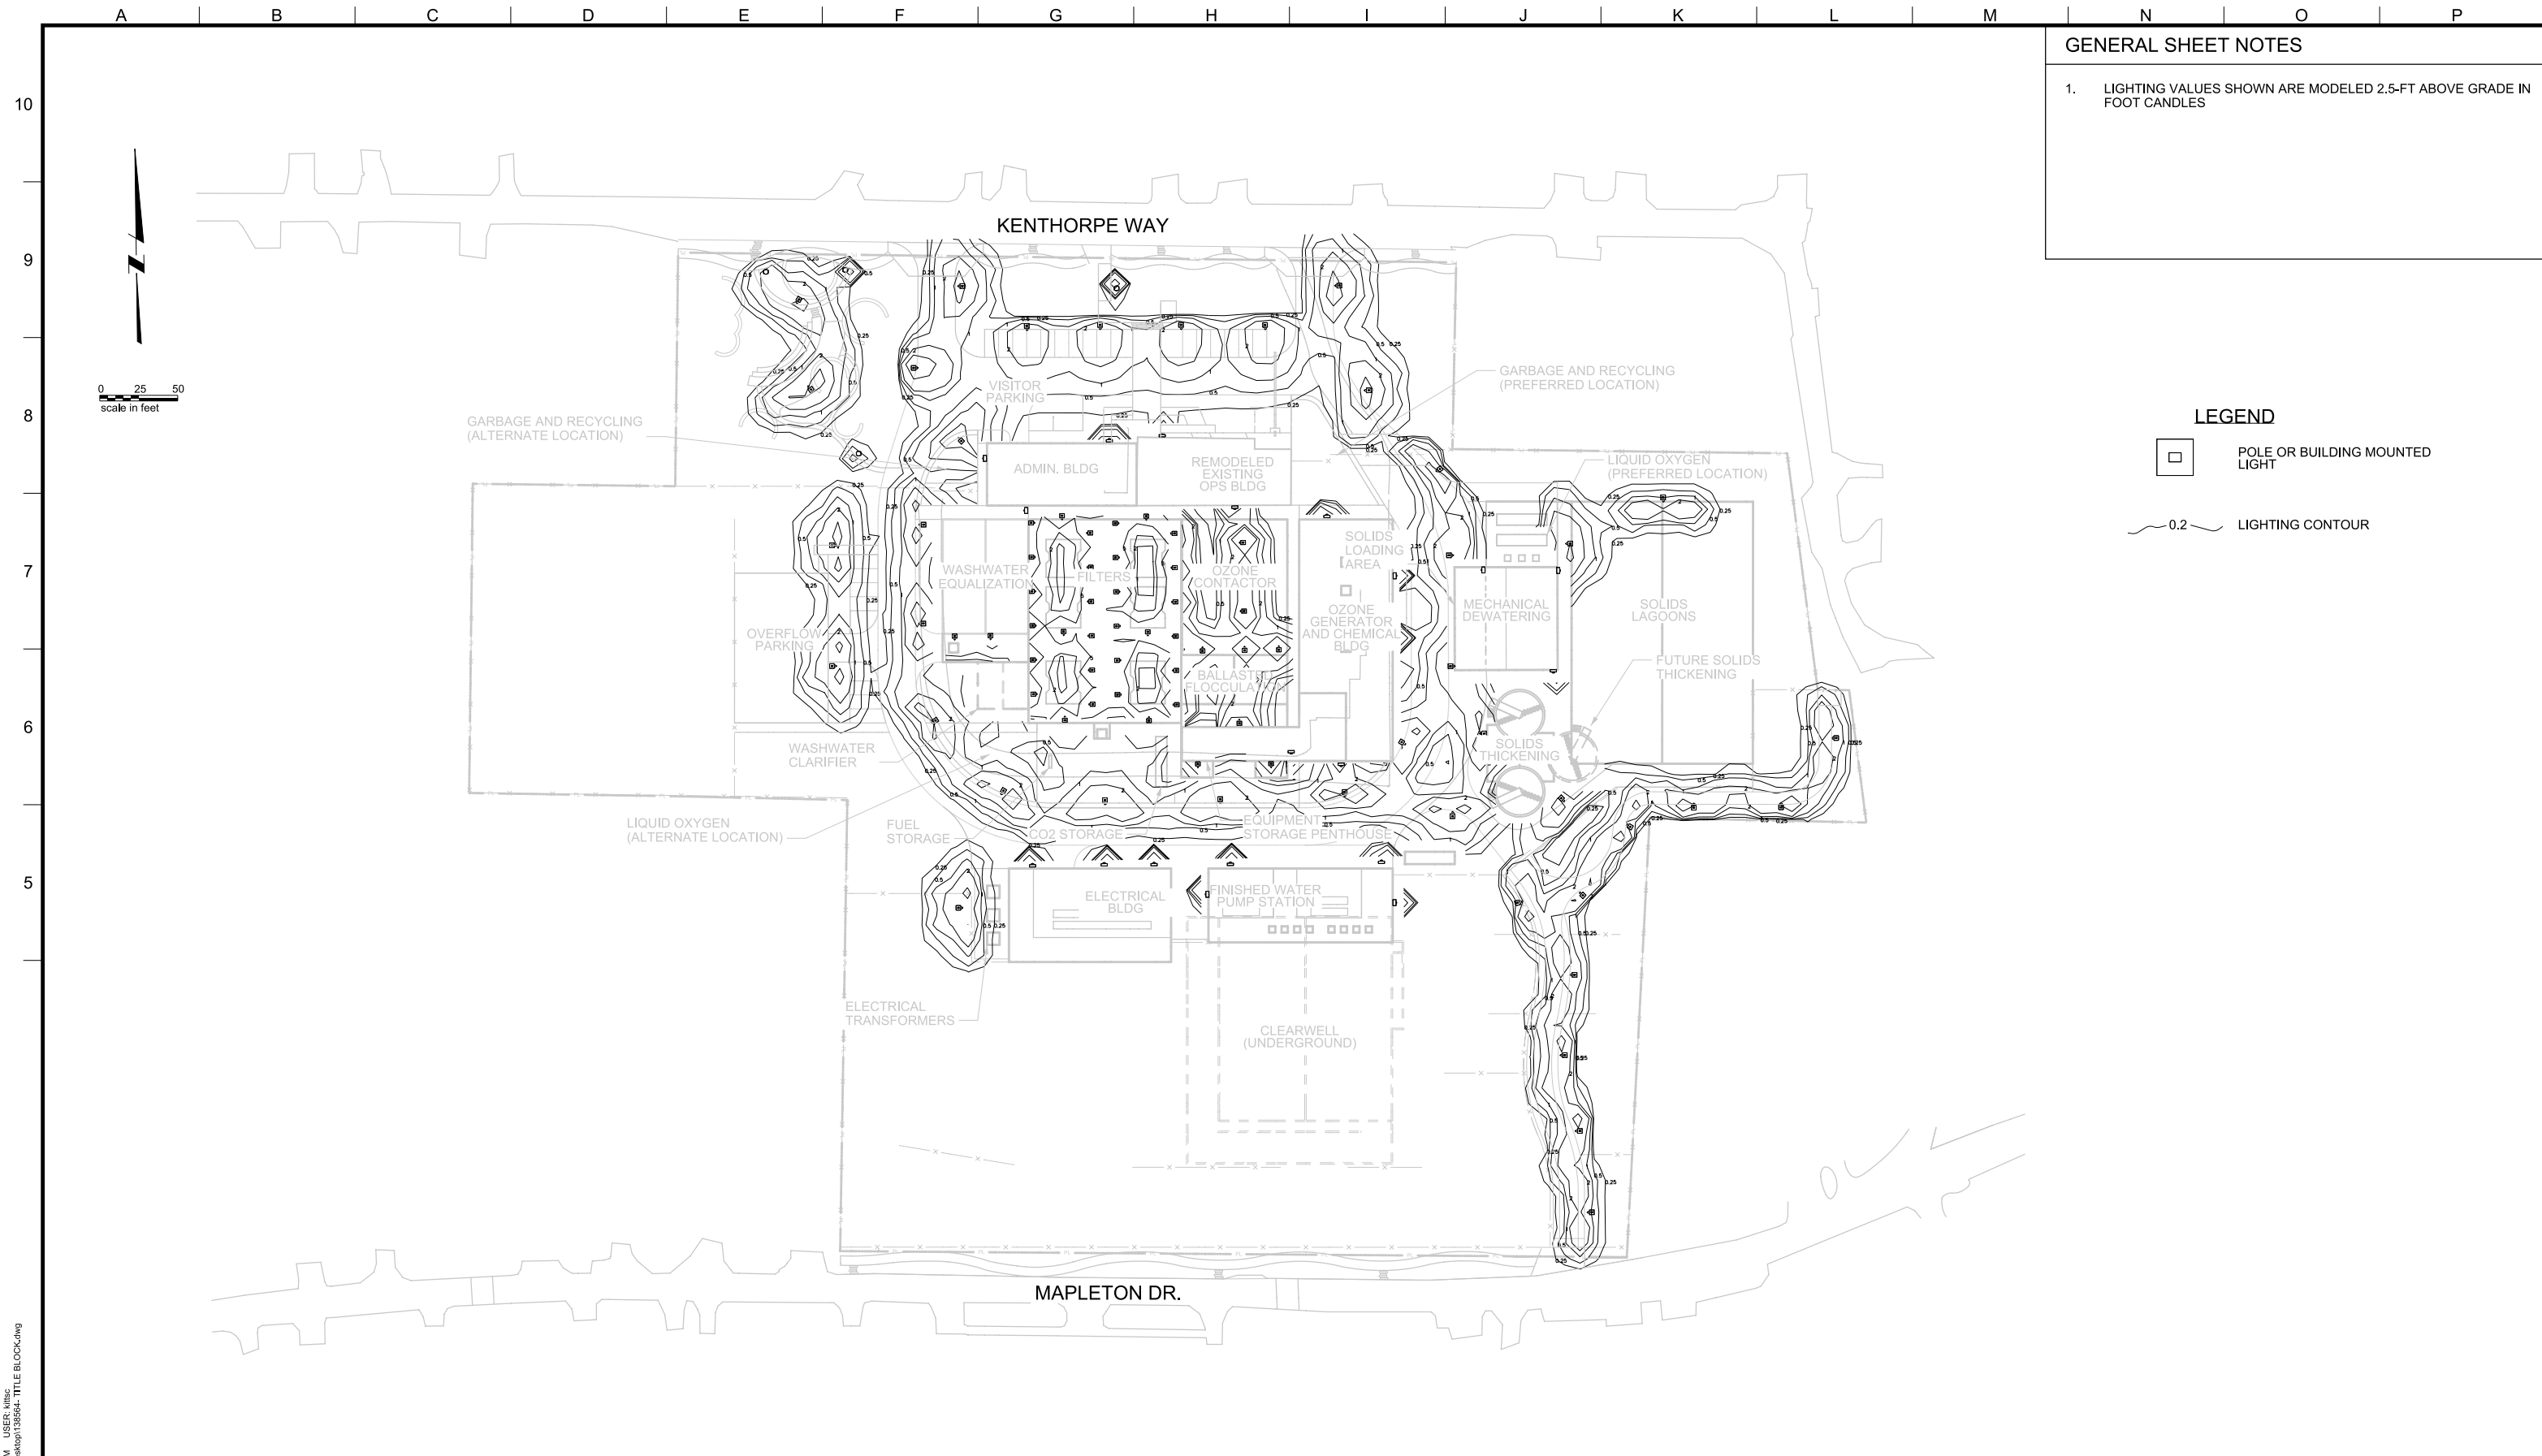
**OWNER:**  
 CITY OF LAKE OSWEGO  
 380 A AVENUE  
 LAKE OSWEGO, OR 97034  
 PHONE: 503-635-0270



LAKE OSWEGO AND TIGARD WATER TREATMENT PLANT  
 DESIGN REVIEW AND CONDITIONAL USE  
**UTILITY PLAN**  
 AREA D

FILENAME	
PROJECT NUMBER	
SCALE	1" = 20'
DRAWING/FIGURE NUMBER	5.4
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
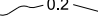





**GENERAL SHEET NOTES**

- LIGHTING VALUES SHOWN ARE MODELED 2.5-FT ABOVE GRADE IN FOOT CANDLES

**LEGEND**

-  POLE OR BUILDING MOUNTED LIGHT
-  0.2 LIGHTING CONTOUR

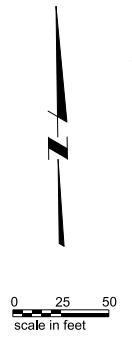

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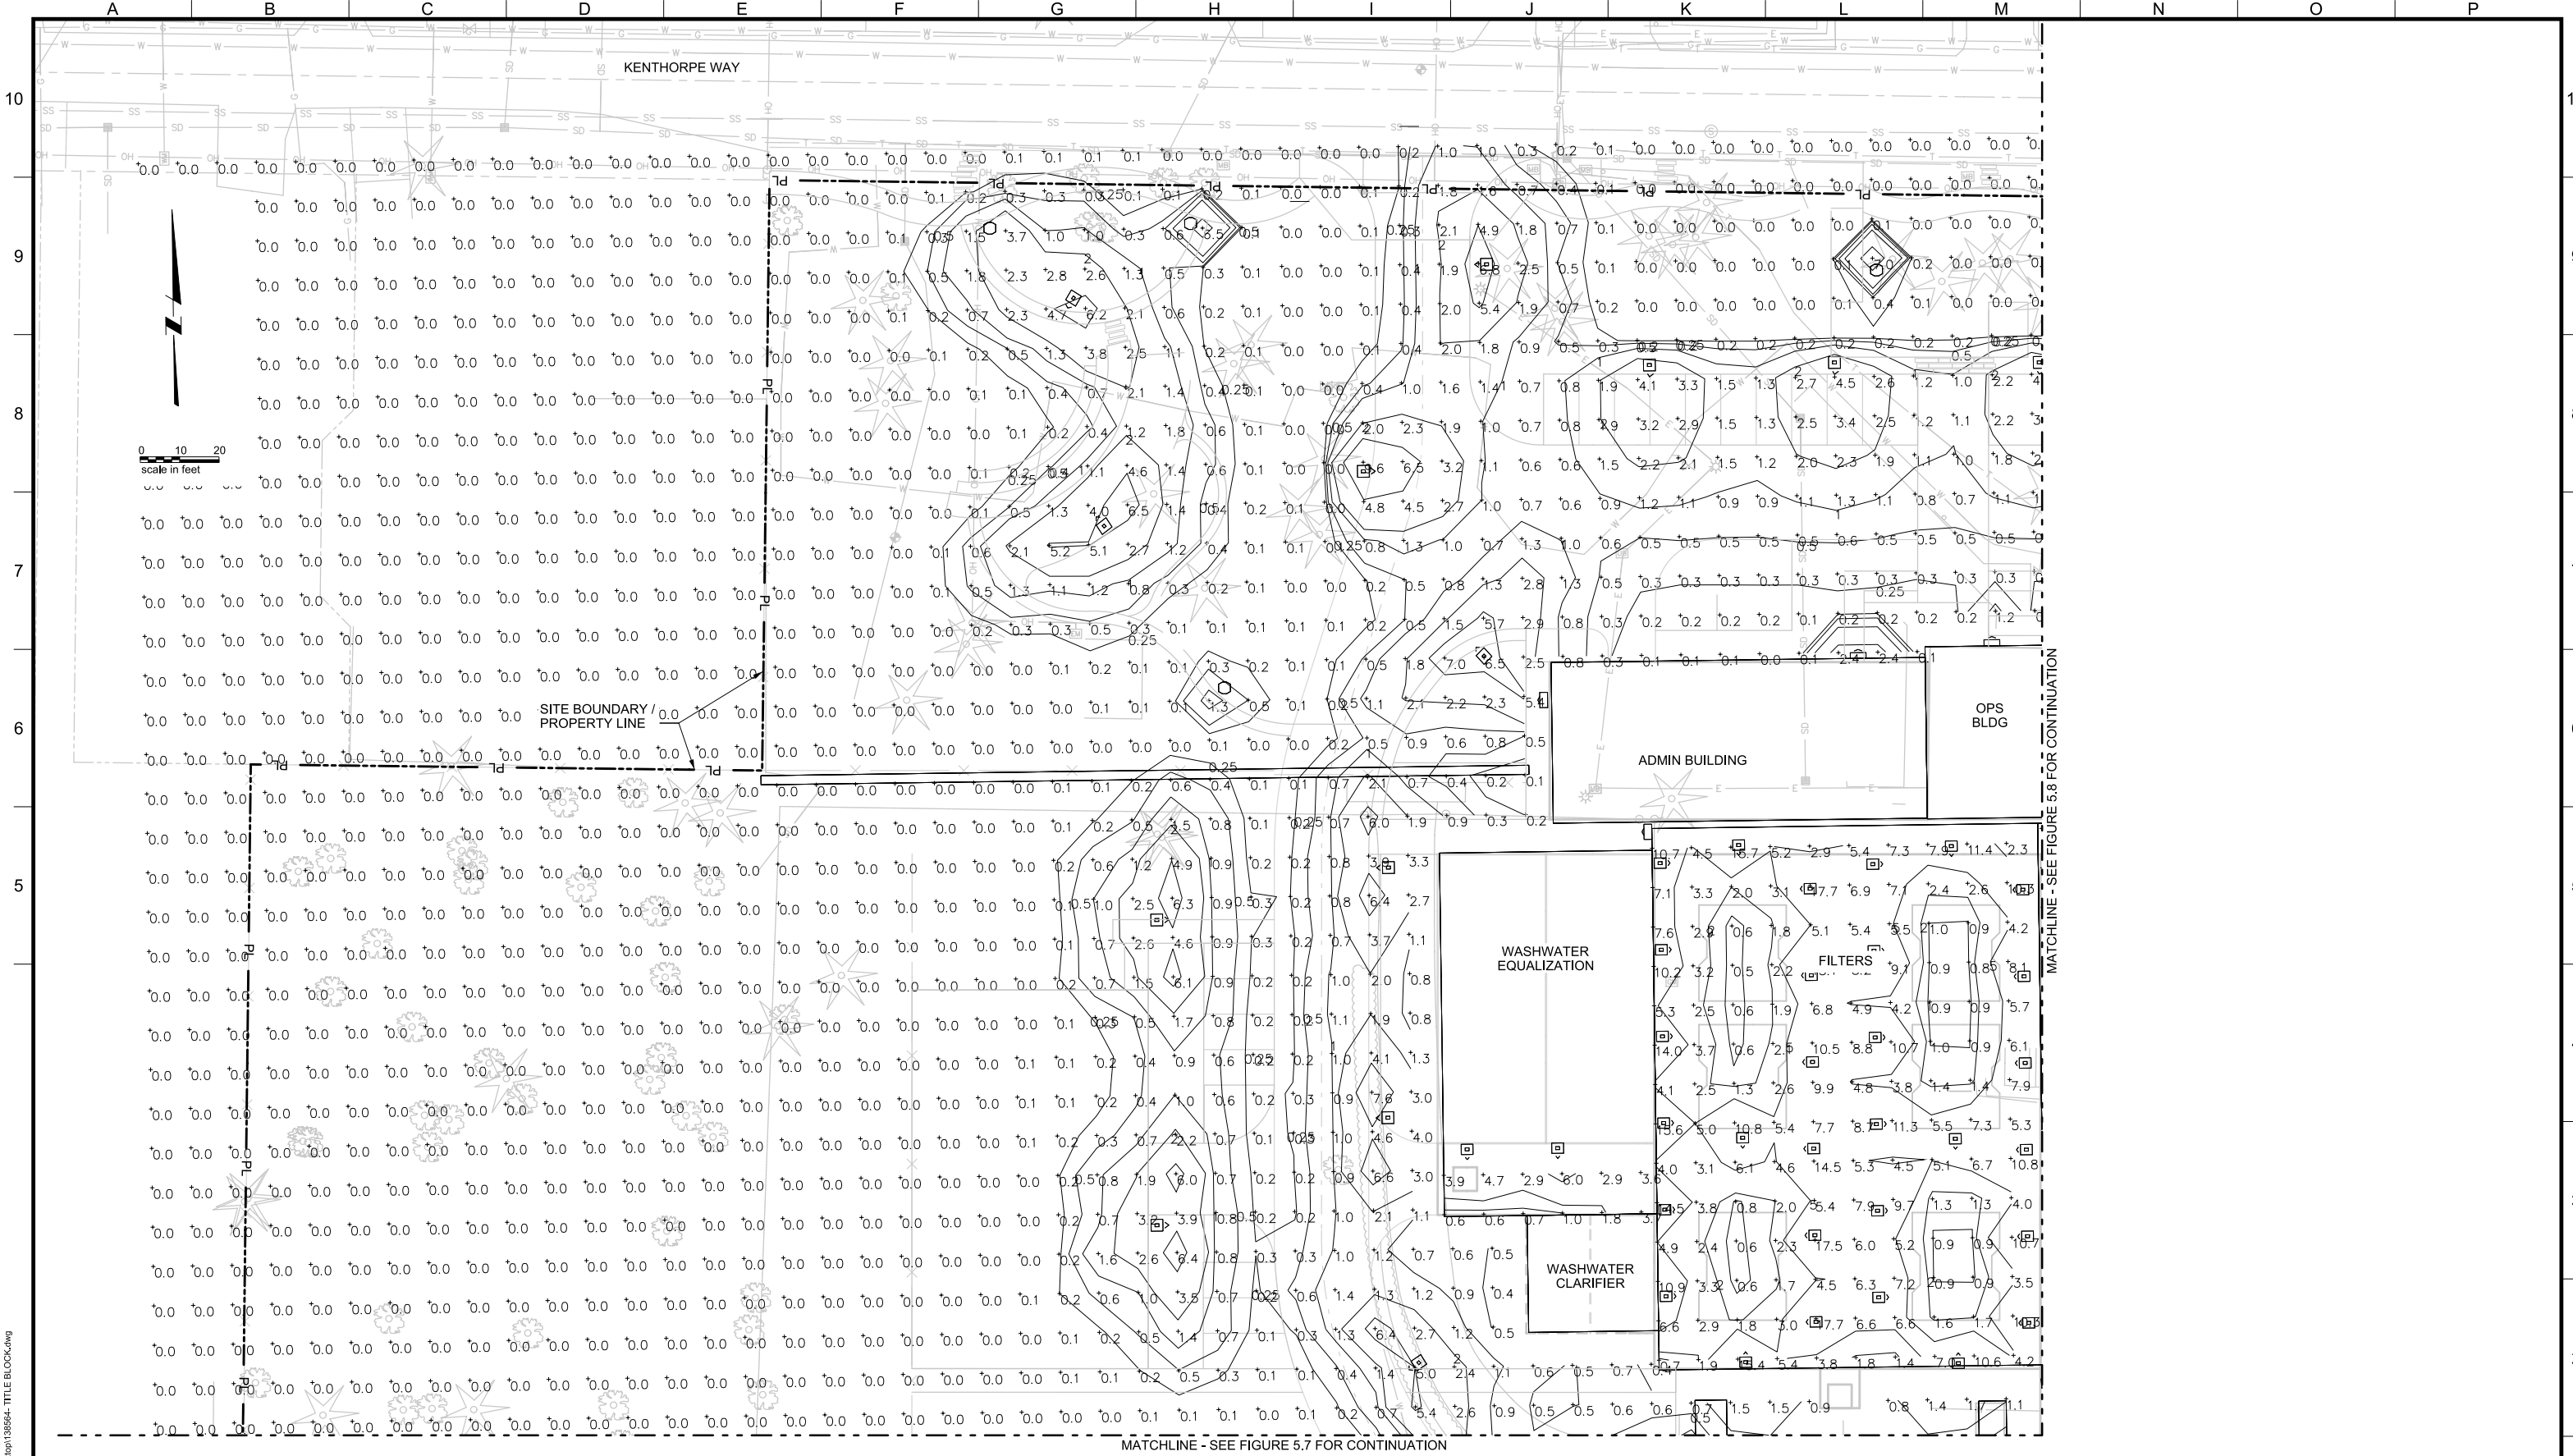
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 380 A AVENUE  
 LAKE OSWEGO, OR 97034  
 PHONE: 503-635-0270



LAKE OSWEGO AND TIGARD WATER TREATMENT PLANT  
 DESIGN REVIEW AND CONDITIONAL USE  
**LIGHTING PLAN OVERVIEW**

FILENAME	
PROJECT NUMBER	
SCALE	1" = 50'
DRAWING/FIGURE NUMBER	5.5
#### OF	



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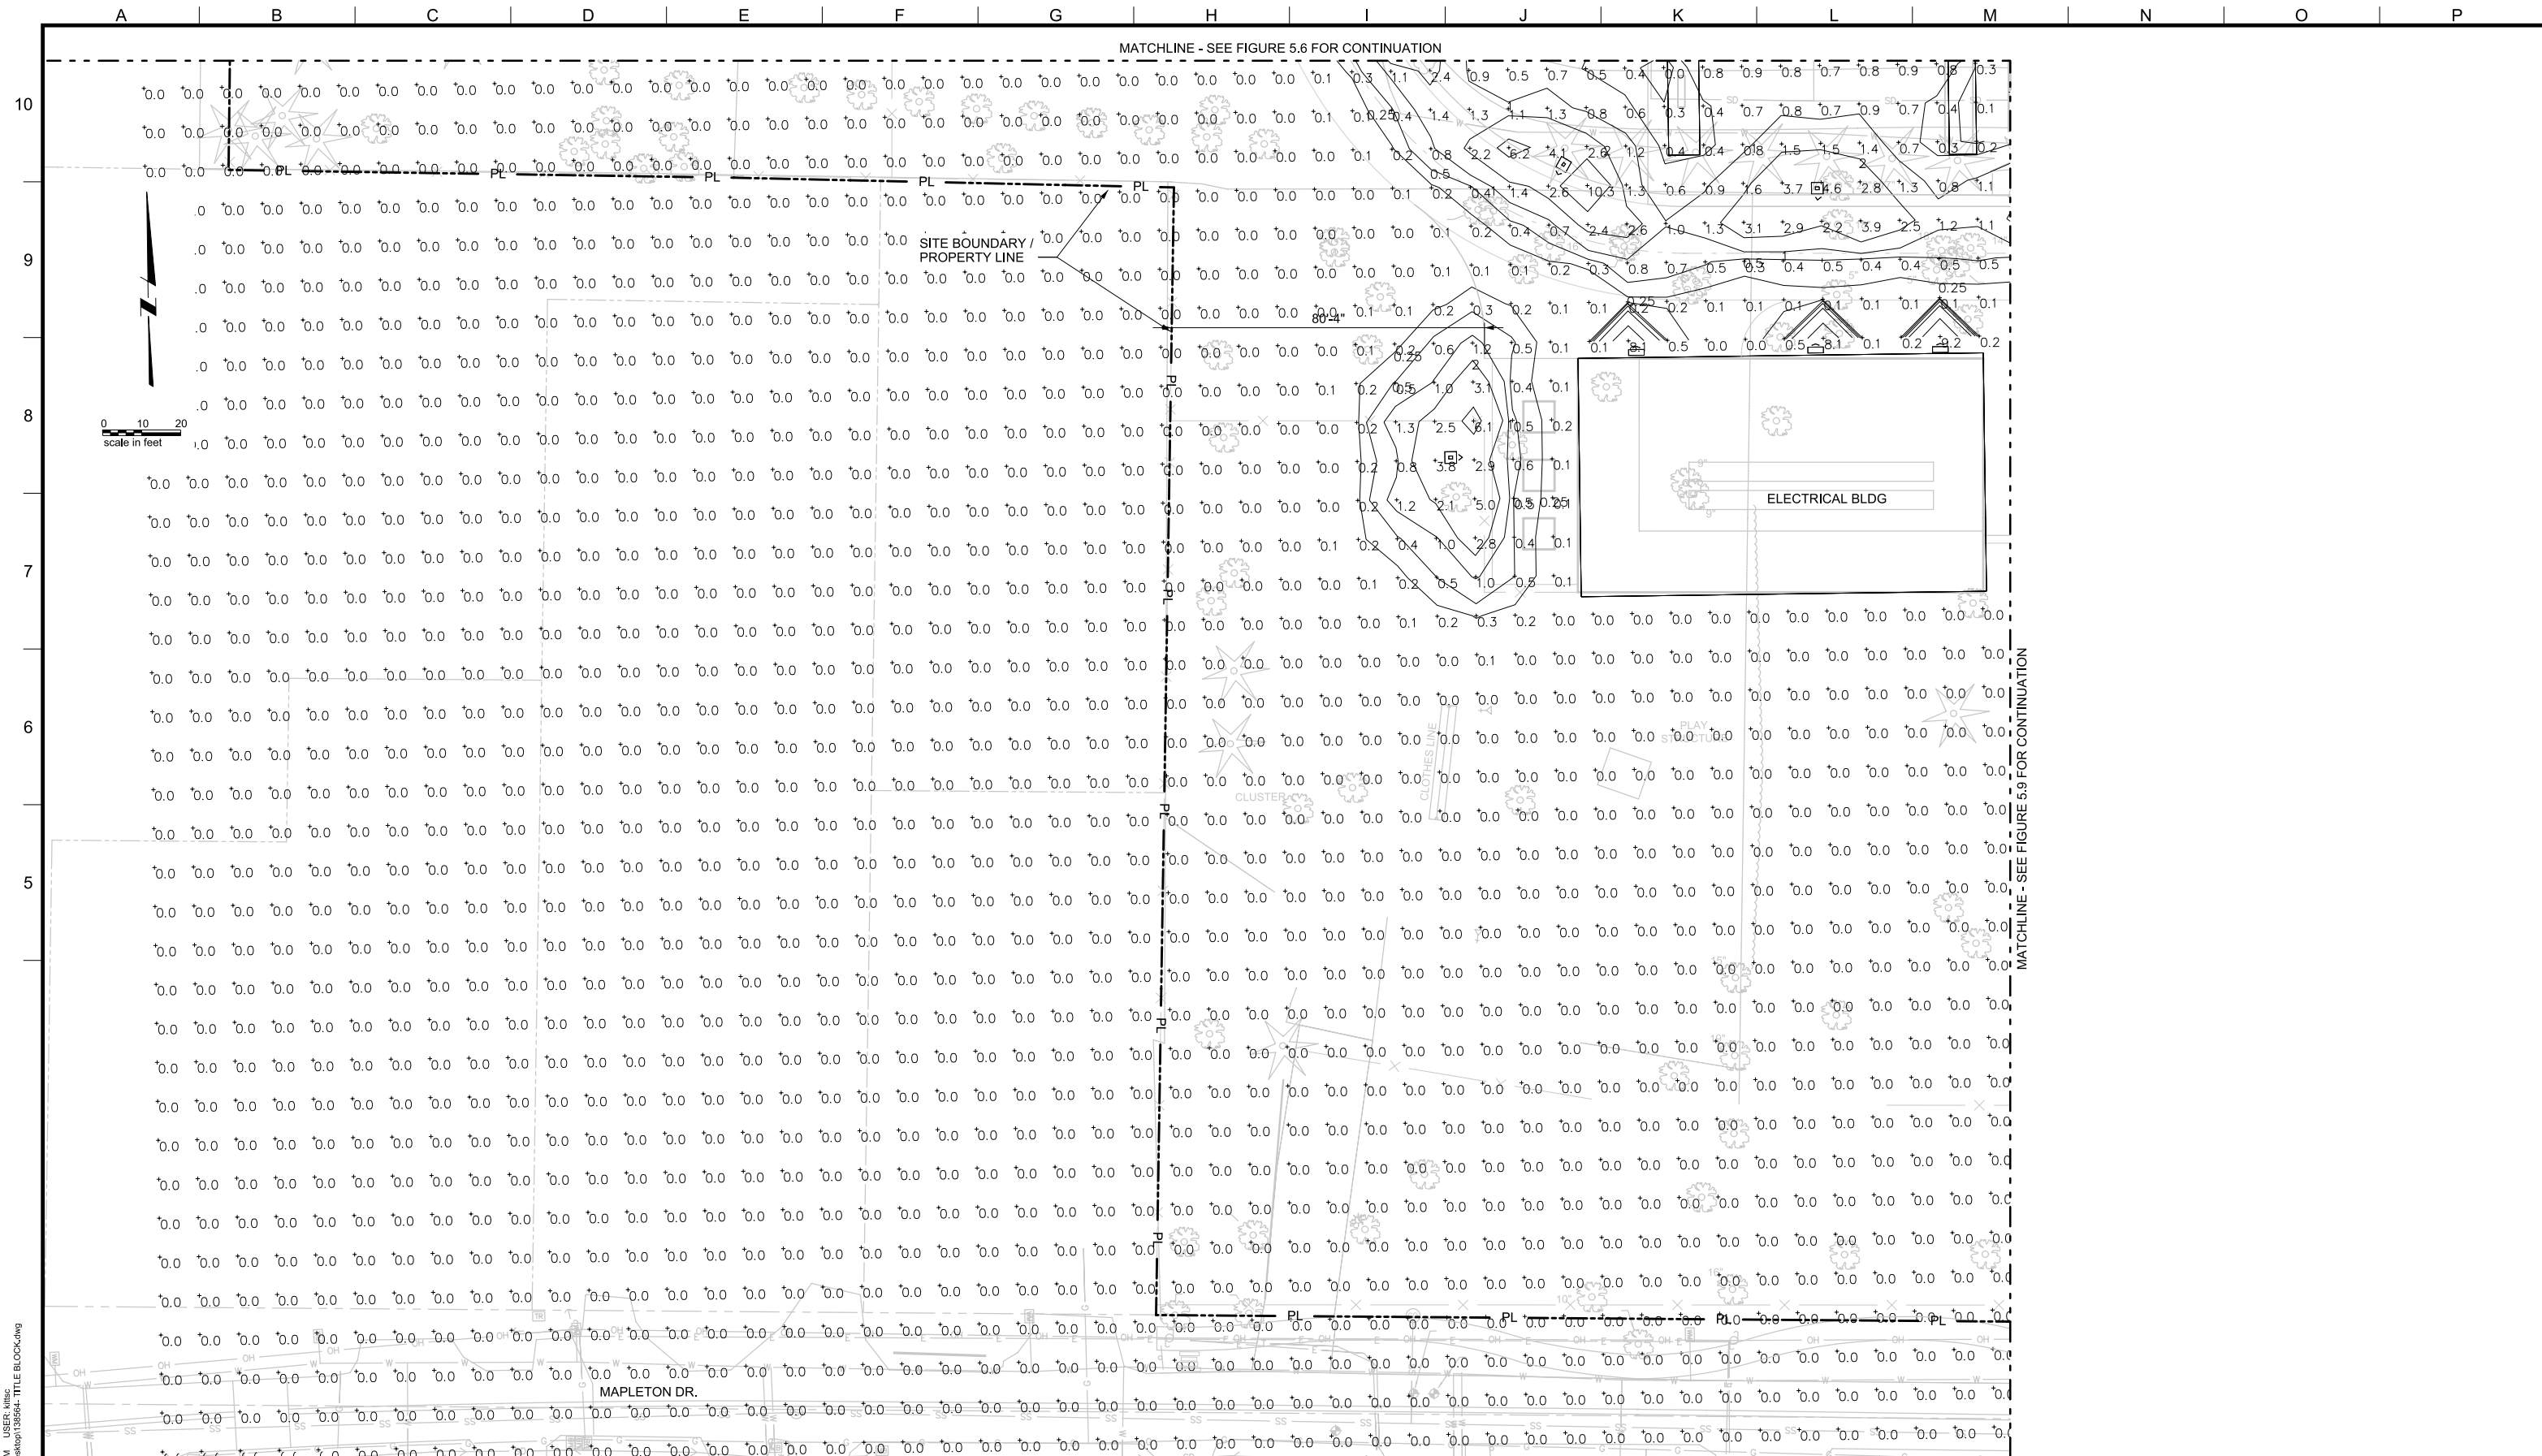


LAKE OSWEGO AND TIGARD WATER TREATMENT PLANT  
 DESIGN REVIEW AND CONDITIONAL USE  
**LIGHTING PLAN**  
 AREA A

FILENAME	
PROJECT NUMBER	
SCALE	1" = 20'
DRAWING/FIGURE NUMBER	5.6
#### OF	

MATCHLINE - SEE FIGURE 5.8 FOR CONTINUATION

MATCHLINE - SEE FIGURE 5.7 FOR CONTINUATION



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REV.	DESCRIPTION	BY	DATE	APP.

**OWNER:**  
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 380 A AVENUE  
 LAKE OSWEGO, OR 97034  
 PHONE: 503-635-0270



LAKE OSWEGO AND TIGARD WATER TREATMENT PLANT  
 DESIGN REVIEW AND CONDITIONAL USE  
**LIGHTING PLAN**  
 AREA B

FILENAME	
PROJECT NUMBER	
SCALE	1" = 20'
DRAWING/FIGURE NUMBER	5.7
#### OF	



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**MWH**  
 806 SW BROADWAY, SUITE 200  
 PORTLAND, OREGON 97205

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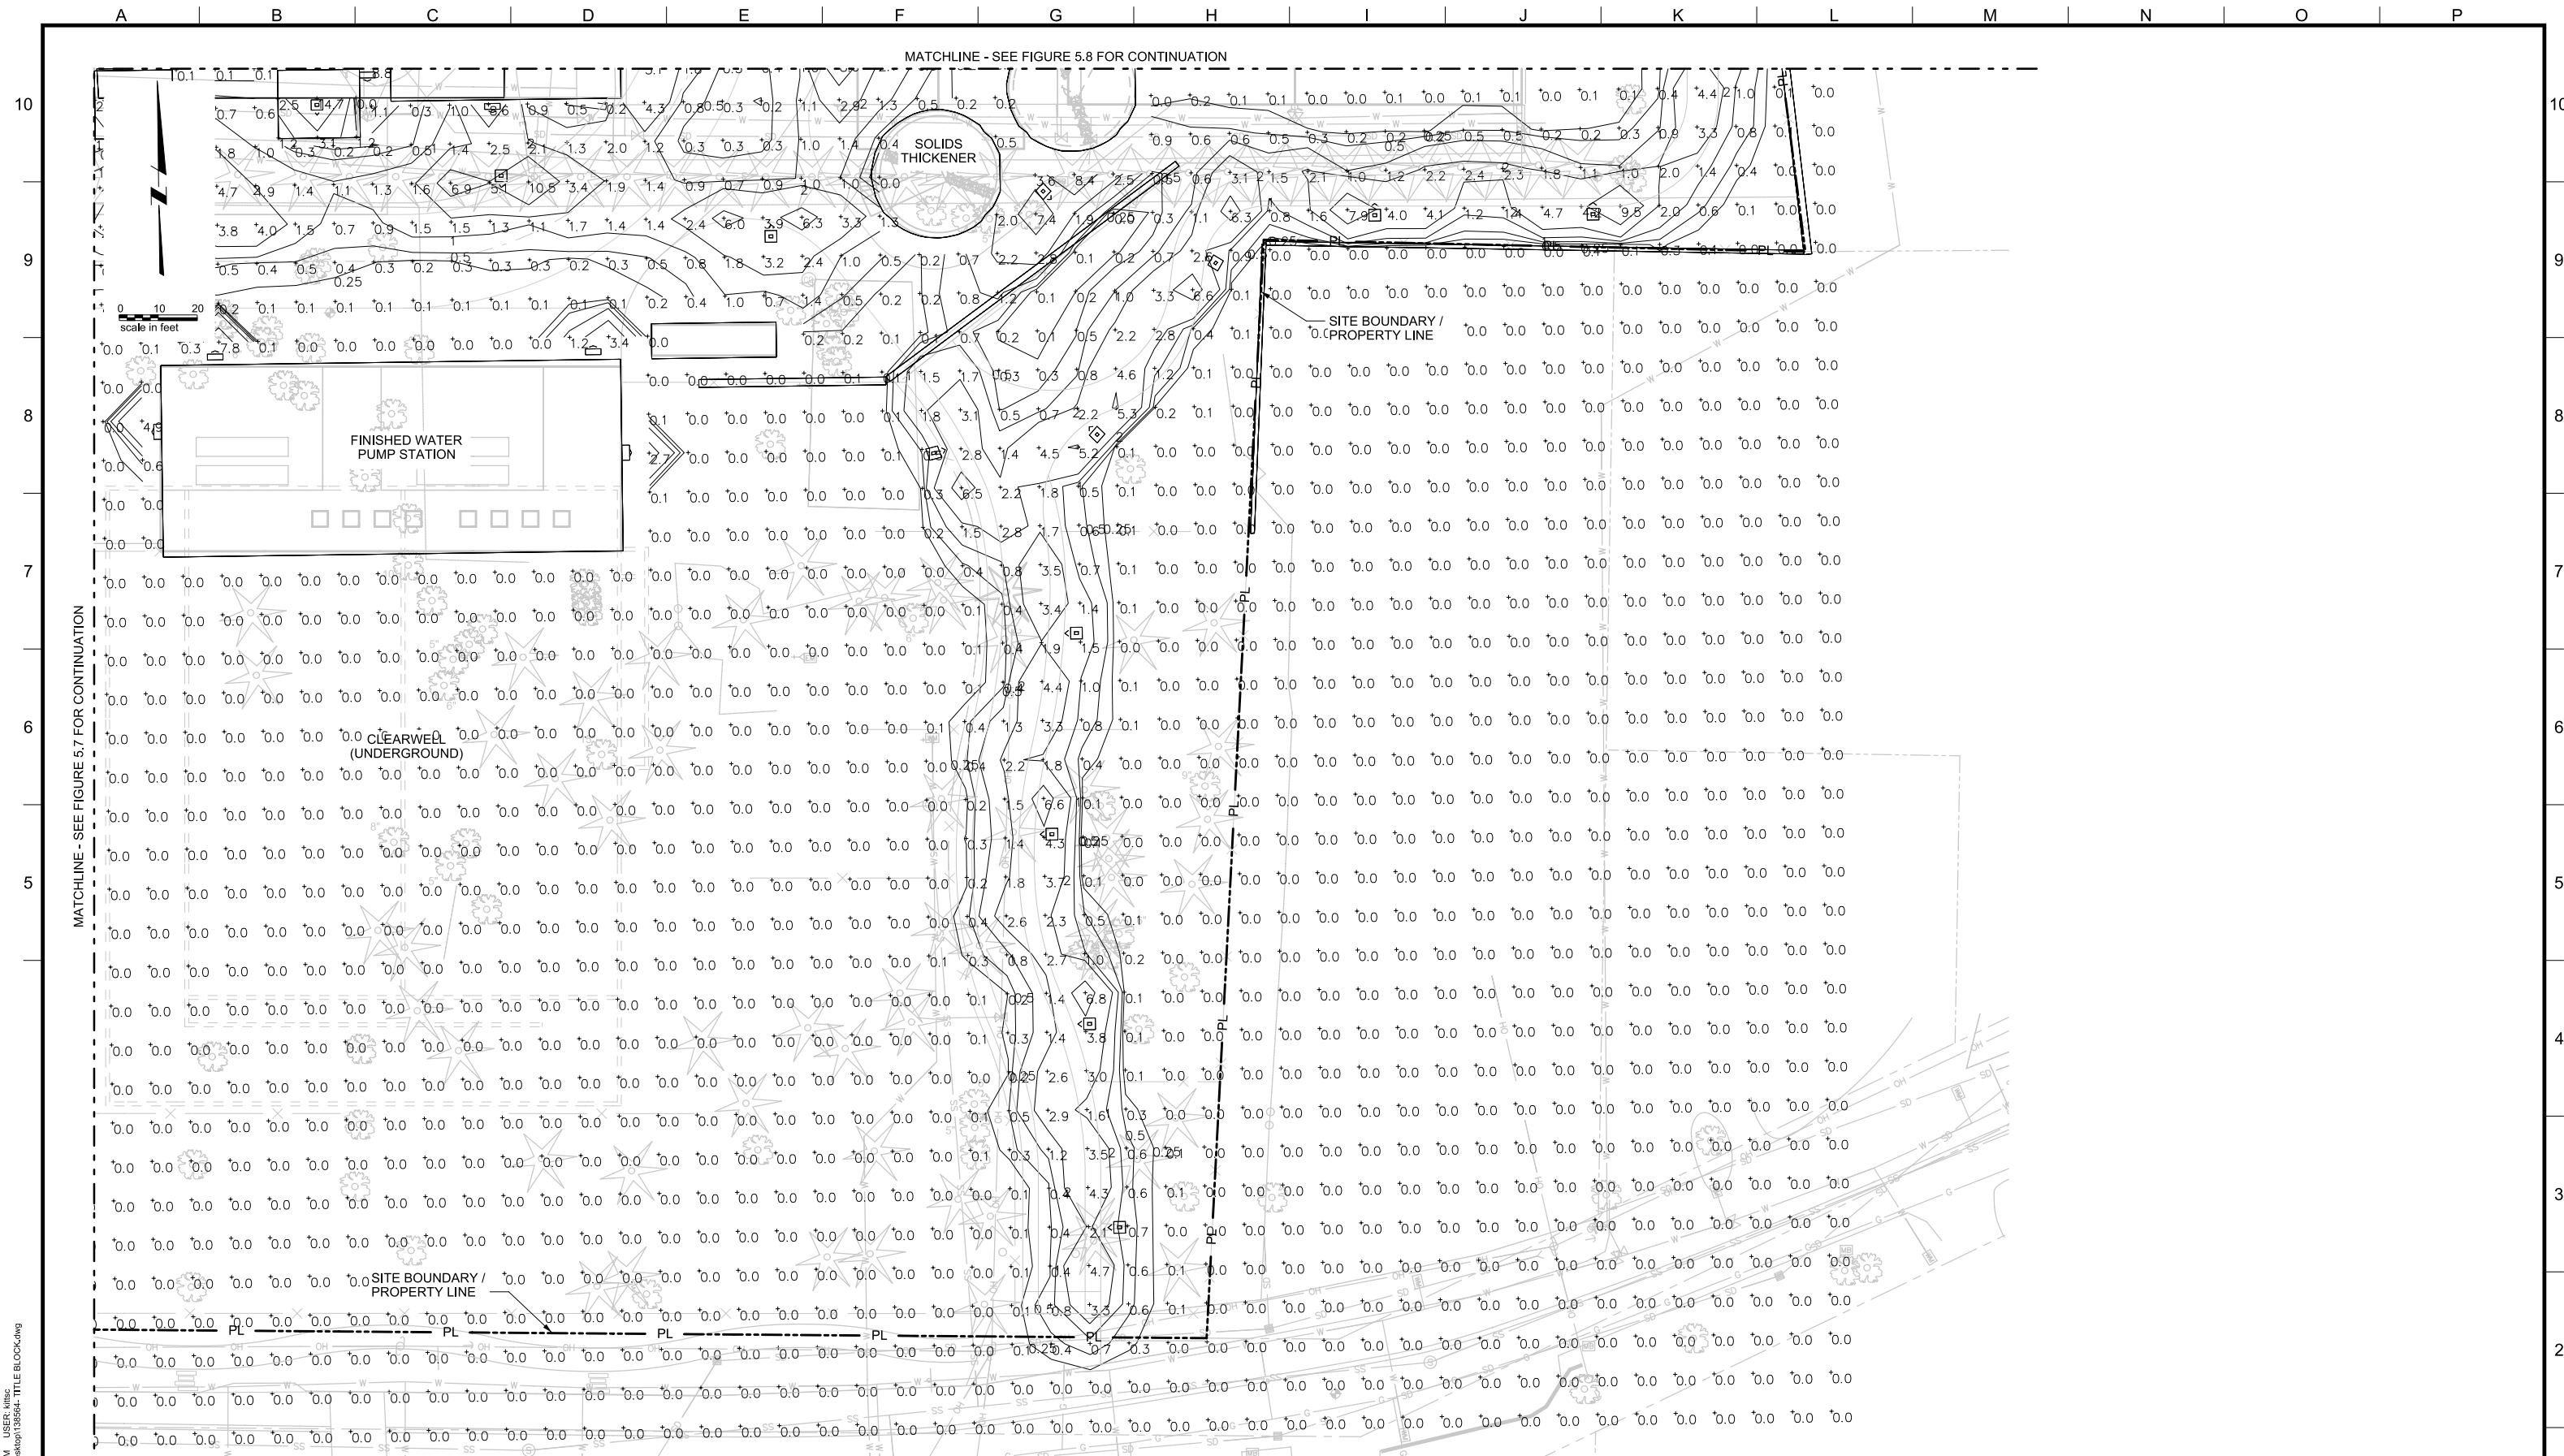
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REV.	DESCRIPTION	BY	APP.

**OWNER:**  
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 LAKE OSWEGO, OR 97034  
 PHONE: 503-635-0270



LAKE OSWEGO AND TIGARD WATER TREATMENT PLANT  
 DESIGN REVIEW AND CONDITIONAL USE  
**LIGHTING PLAN**  
 AREA C

FILENAME	
PROJECT NUMBER	
SCALE	1" = 20'
DRAWING/FIGURE NUMBER	5.8
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REVISIONS				
REV.	DESCRIPTION	BY		APP.

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 LAKE OSWEGO, OR 97034  
 PHONE: 503-635-0270



LAKE OSWEGO AND TIGARD WATER TREATMENT PLANT  
 DESIGN REVIEW AND CONDITIONAL USE  
**LIGHTING PLAN**  
 AREA D

FILENAME	
PROJECT NUMBER	
SCALE	1" = 20'
DRAWING/FIGURE NUMBER	5.9
### OF	



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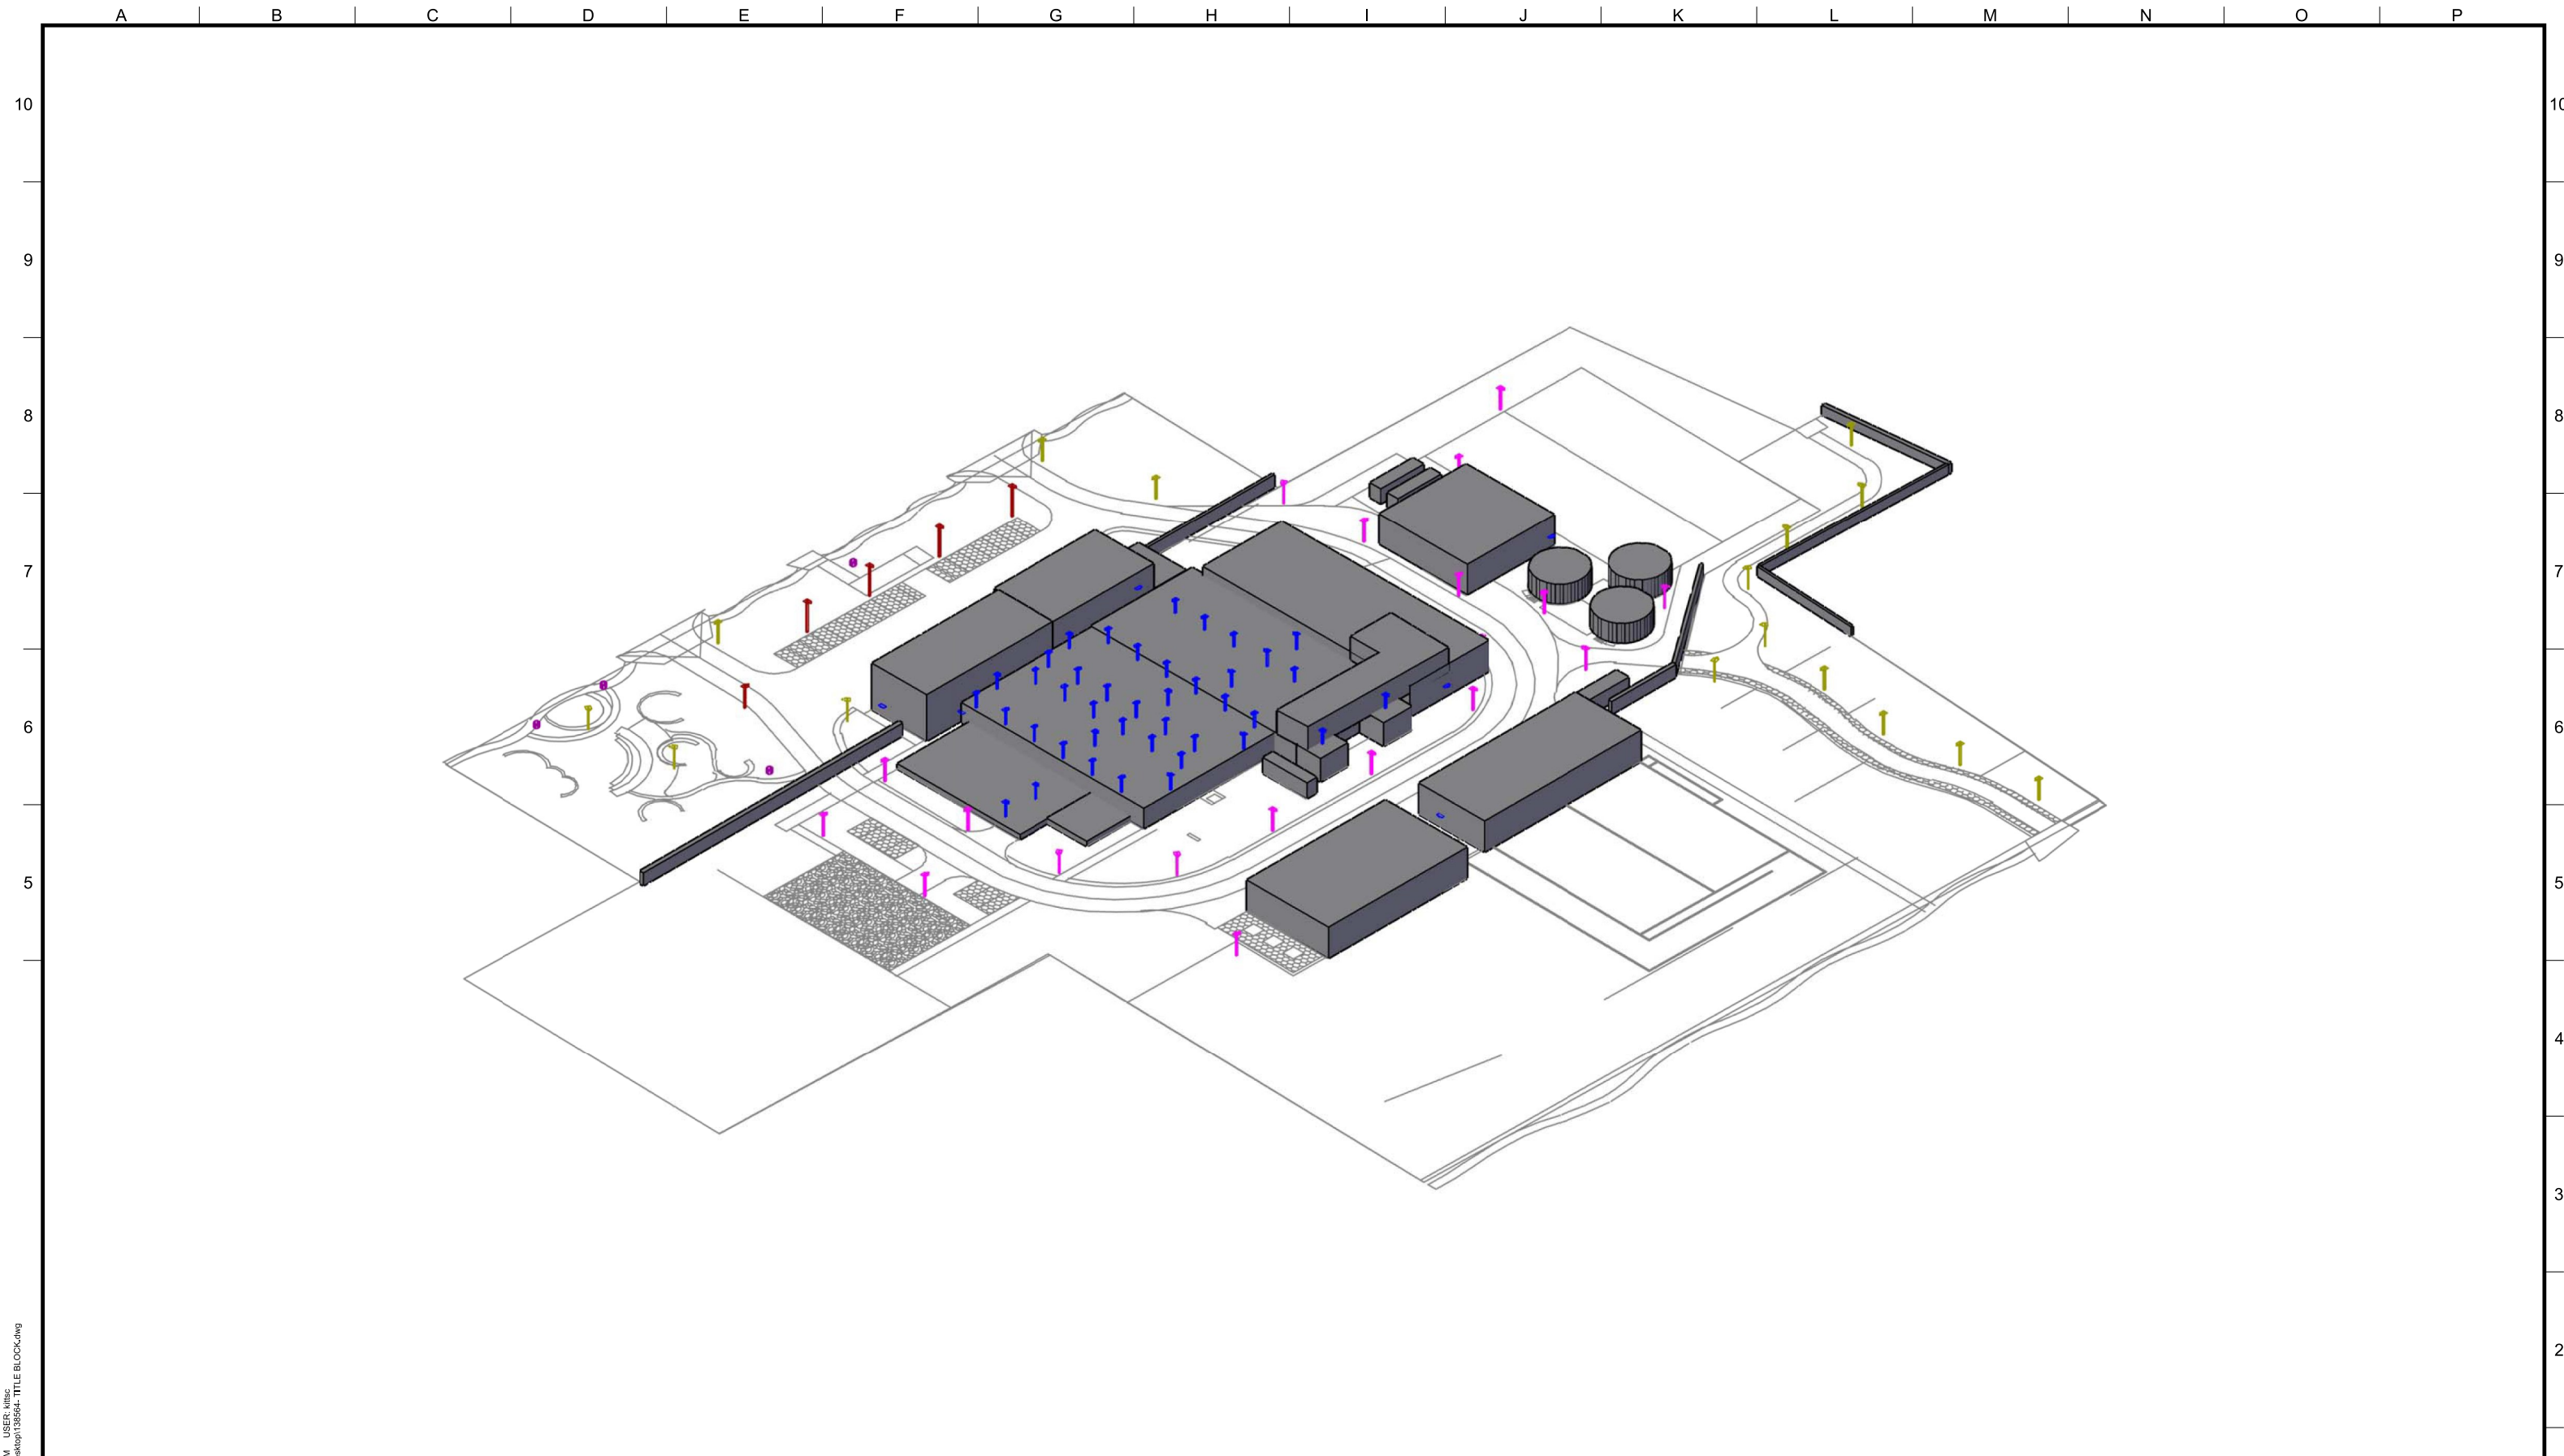
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 CITY OF LAKE OSWEGO  
 380 A AVENUE  
 LAKE OSWEGO, OR 97034  
 PHONE: 503-635-0270



LAKE OSWEGO AND TIGARD WATER TREATMENT PLANT  
 DESIGN REVIEW AND CONDITIONAL USE  
**LIGHTING PLAN**  
**LIGHT LOCATION PLAN**

FILENAME	
PROJECT NUMBER	
SCALE	1" = 50'
DRAWING/FIGURE NUMBER	5.10
### OF	

A B C D E F G H I J K L M N O P



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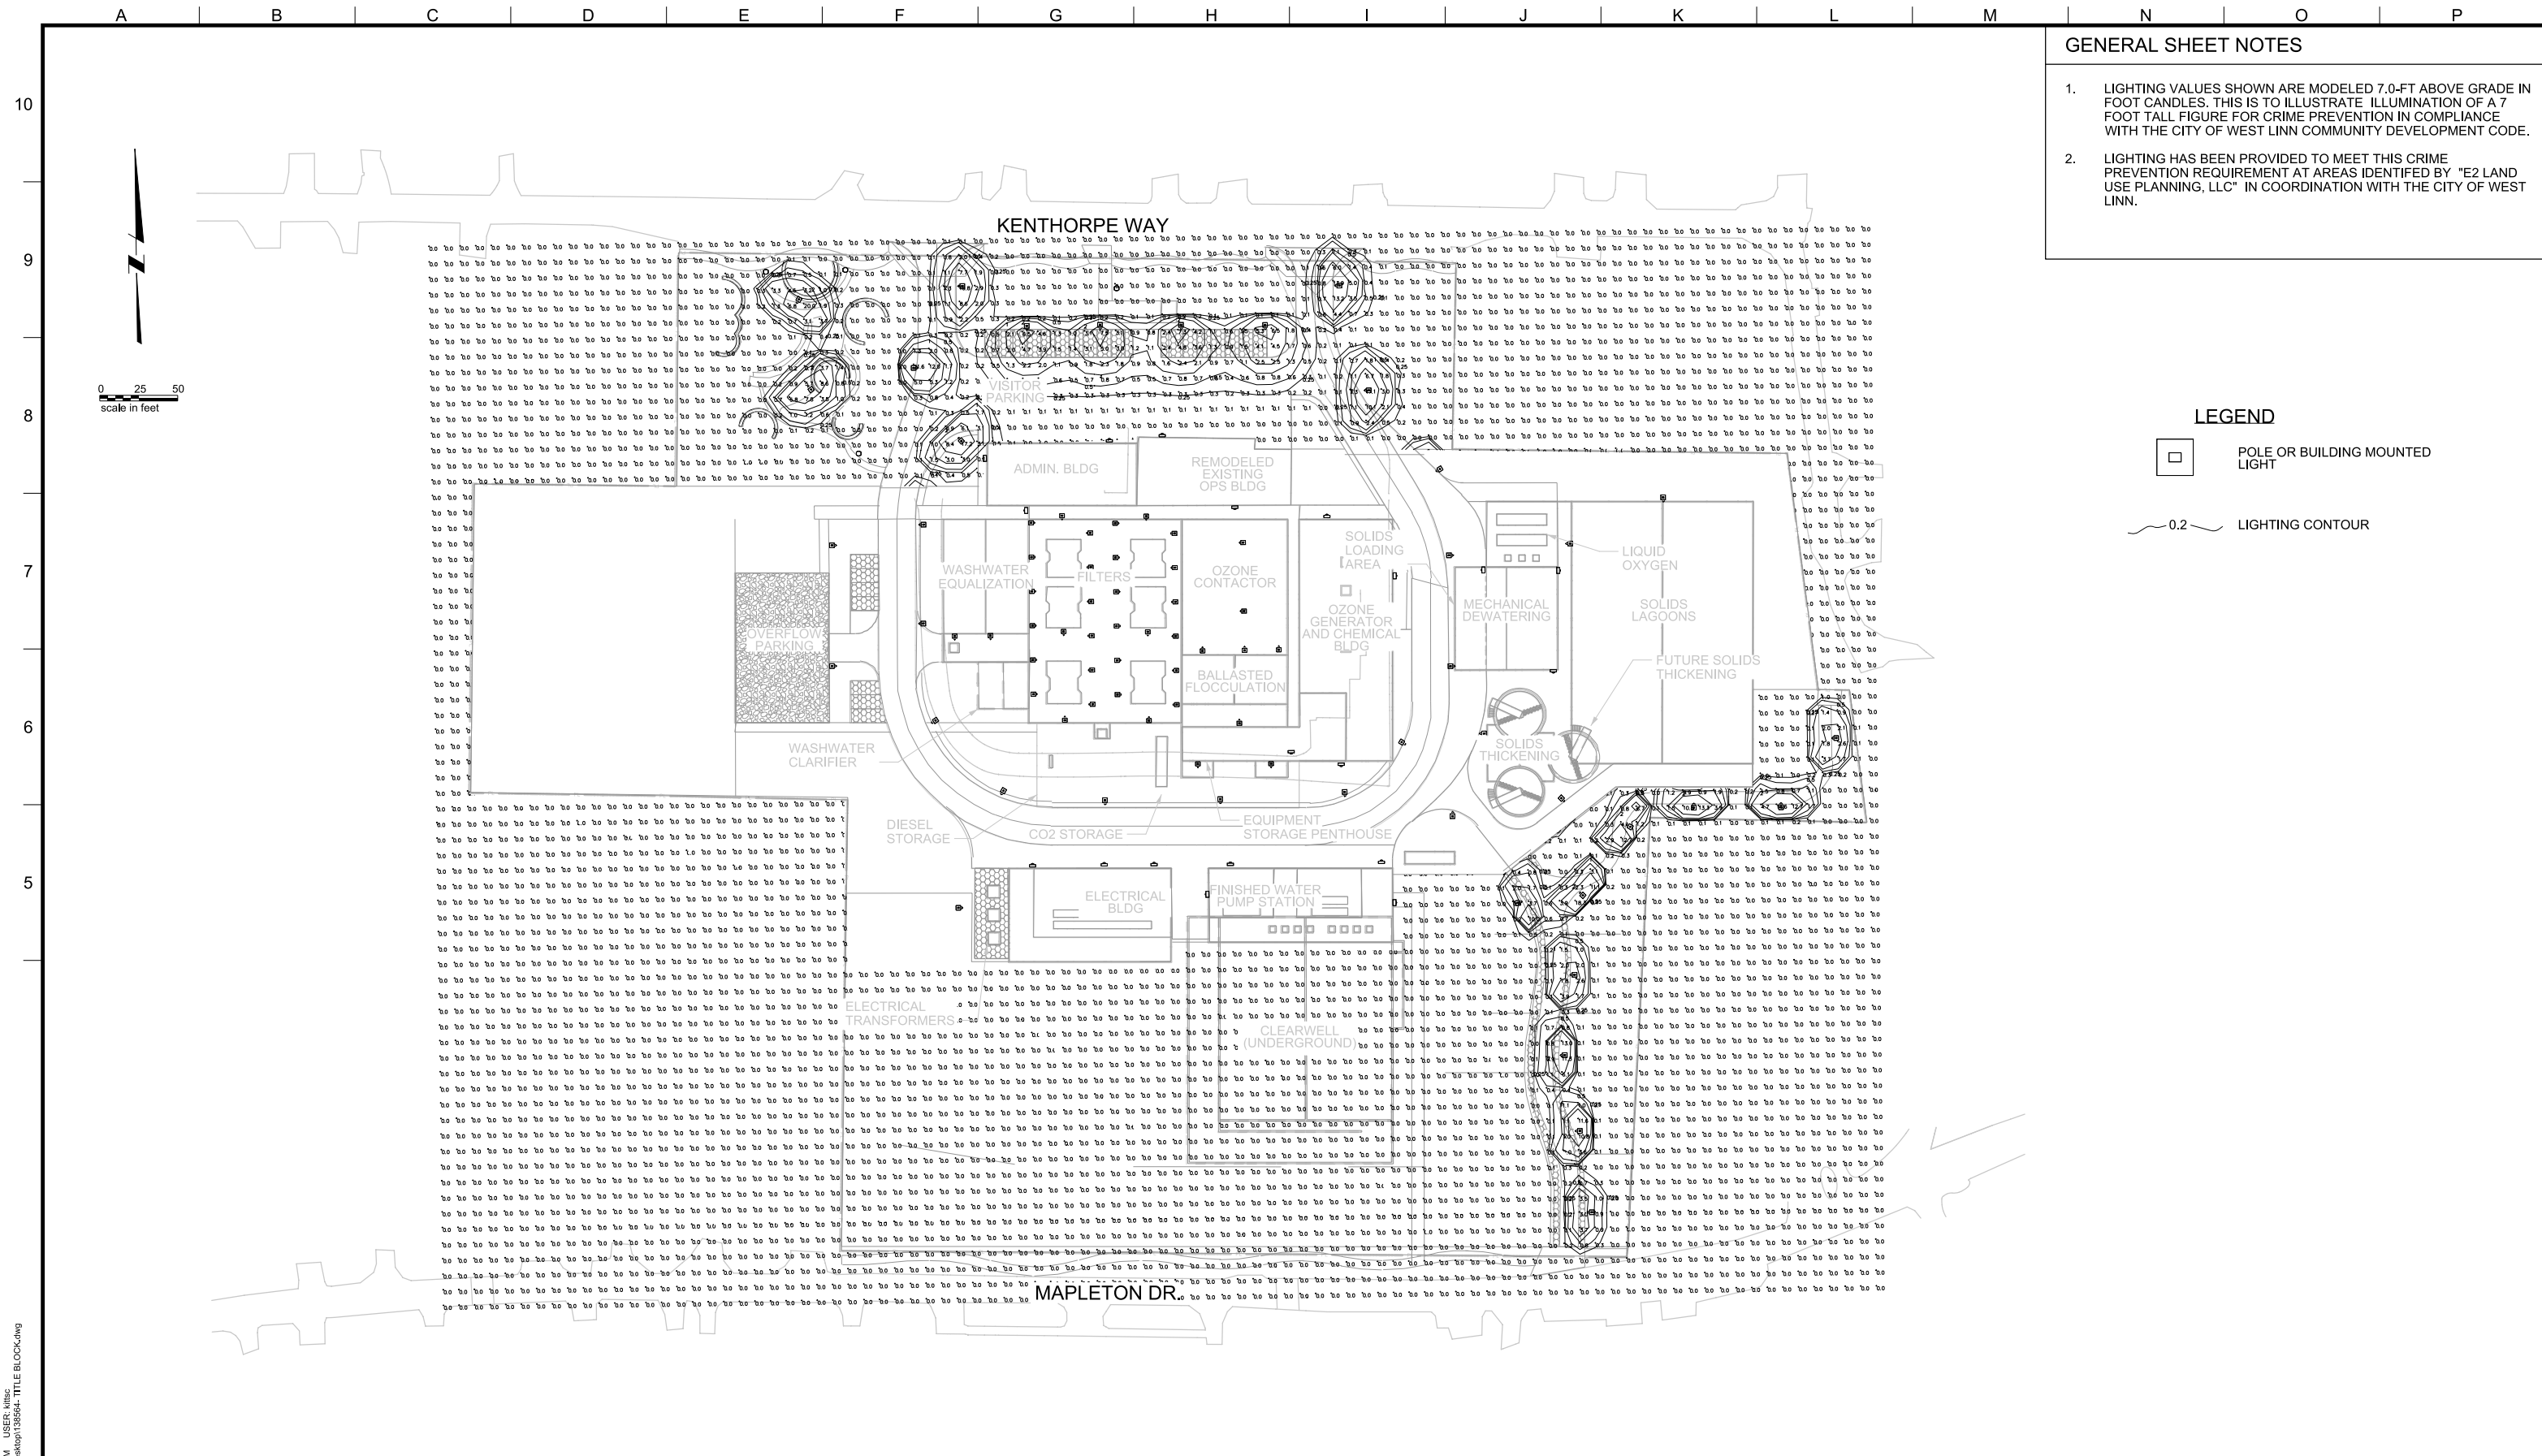
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REV.	DESCRIPTION	BY	DATE	APP.

**OWNER:**  
 CITY OF LAKE OSWEGO  
 380 A AVENUE  
 LAKE OSWEGO, OR 97034  
 PHONE: 503-635-0270




LAKE OSWEGO AND TIGARD WATER TREATMENT PLANT  
 DESIGN REVIEW AND CONDITIONAL USE  
**LIGHTING PLAN**  
**ISOMETRIC**

FILENAME	
PROJECT NUMBER	
SCALE	NONE
DRAWING/FIGURE NUMBER	5.11
### OF	1



- GENERAL SHEET NOTES**
1. LIGHTING VALUES SHOWN ARE MODELED 7.0-FT ABOVE GRADE IN FOOT CANDLES. THIS IS TO ILLUSTRATE ILLUMINATION OF A 7 FOOT TALL FIGURE FOR CRIME PREVENTION IN COMPLIANCE WITH THE CITY OF WEST LINN COMMUNITY DEVELOPMENT CODE.
  2. LIGHTING HAS BEEN PROVIDED TO MEET THIS CRIME PREVENTION REQUIREMENT AT AREAS IDENTIFIED BY "E2 LAND USE PLANNING, LLC" IN COORDINATION WITH THE CITY OF WEST LINN.

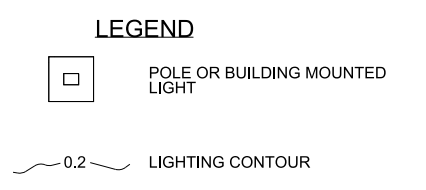

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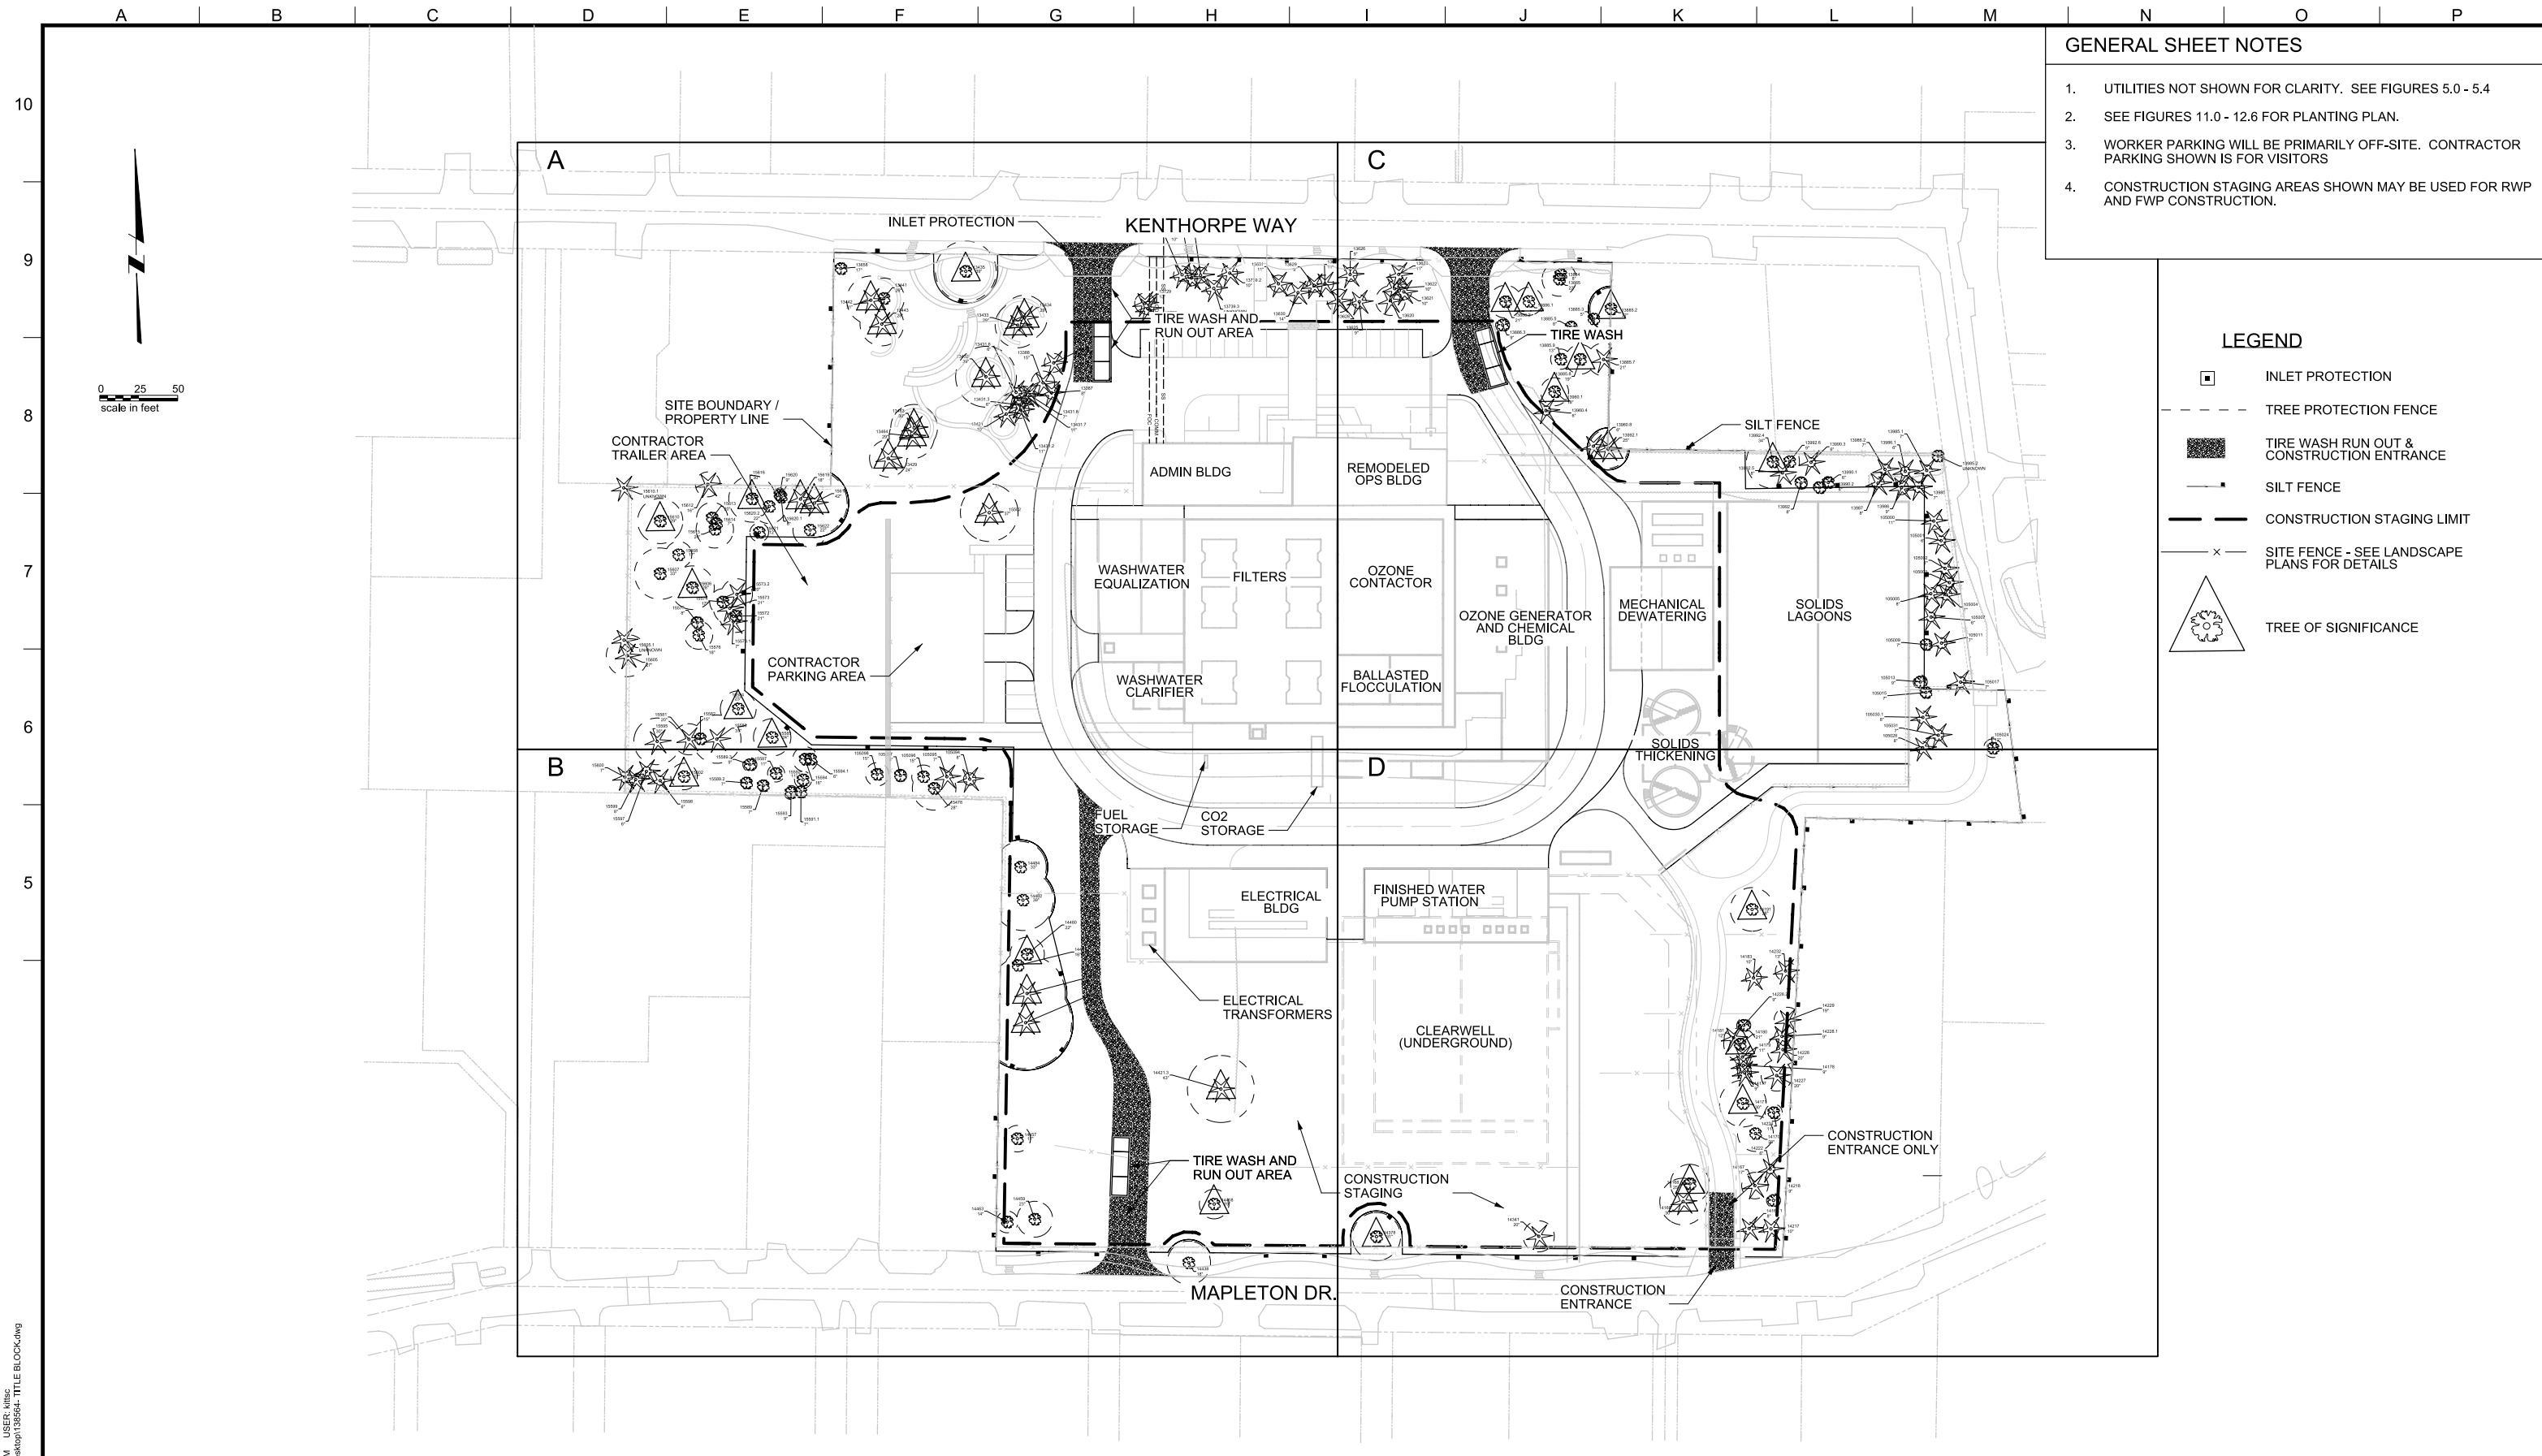
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 380 A AVENUE  
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 PHONE: 503-635-0270



LAKE OSWEGO AND TIGARD WATER TREATMENT PLANT  
 DESIGN REVIEW AND CONDITIONAL USE  
**LIGHTING PLAN**  
 OVERVIEW FOR CRIME PREVENTION

FILENAME	
PROJECT NUMBER	
SCALE	1" = 50'
DRAWING/FIGURE NUMBER	5.12
#### OF	





- GENERAL SHEET NOTES**
1. UTILITIES NOT SHOWN FOR CLARITY. SEE FIGURES 5.0 - 5.4
  2. SEE FIGURES 11.0 - 12.6 FOR PLANTING PLAN.
  3. WORKER PARKING WILL BE PRIMARILY OFF-SITE. CONTRACTOR PARKING SHOWN IS FOR VISITORS
  4. CONSTRUCTION STAGING AREAS SHOWN MAY BE USED FOR RWP AND FWP CONSTRUCTION.

- LEGEND**
- INLET PROTECTION
  - - - TREE PROTECTION FENCE
  - TIRE WASH RUN OUT & CONSTRUCTION ENTRANCE
  - SILT FENCE
  - - - CONSTRUCTION STAGING LIMIT
  - x - SITE FENCE - SEE LANDSCAPE PLANS FOR DETAILS
  - △ TREE OF SIGNIFICANCE

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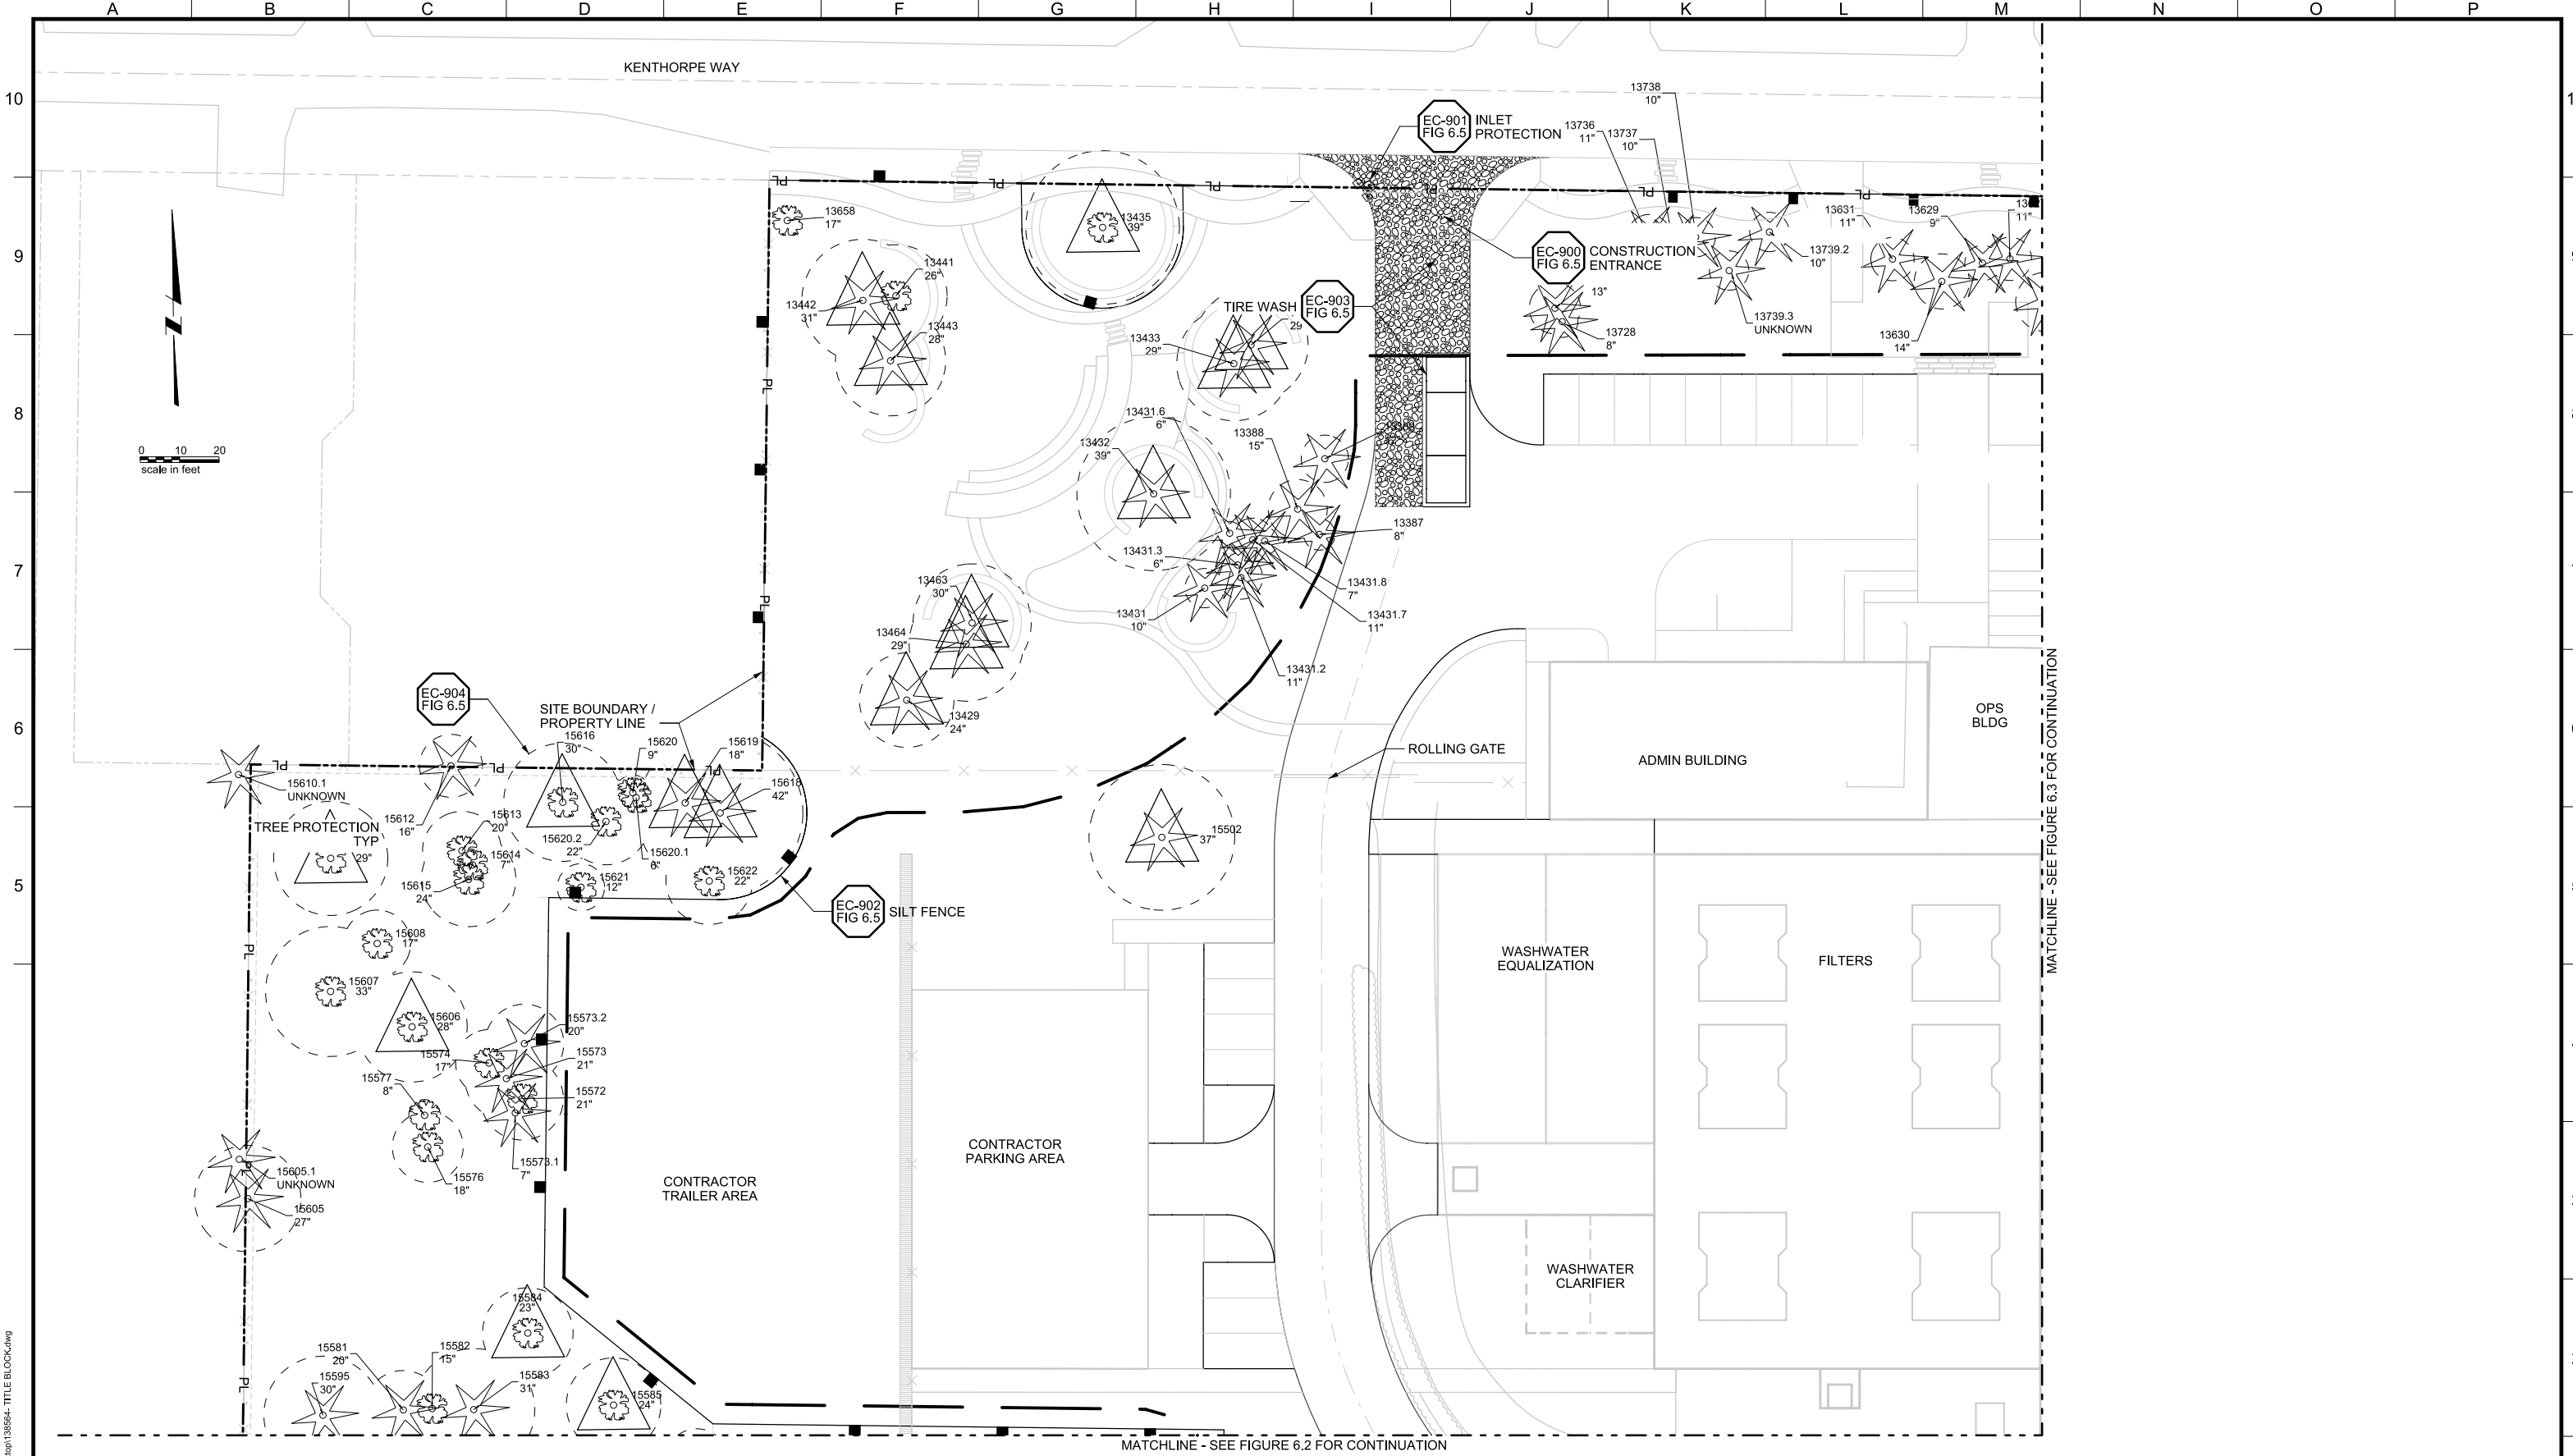
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REV.	DESCRIPTION	BY	DATE	APP.

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 380 A AVENUE  
 LAKE OSWEGO, OR 97034  
 PHONE: 503-635-0270



LAKE OSWEGO AND TIGARD WATER TREATMENT PLANT  
 DESIGN REVIEW AND CONDITIONAL USE  
**CONSTRUCTION MANAGEMENT OVERVIEW**

FILENAME	
PROJECT NUMBER	
SCALE	1" = 50'
DRAWING/FIGURE NUMBER	6.0
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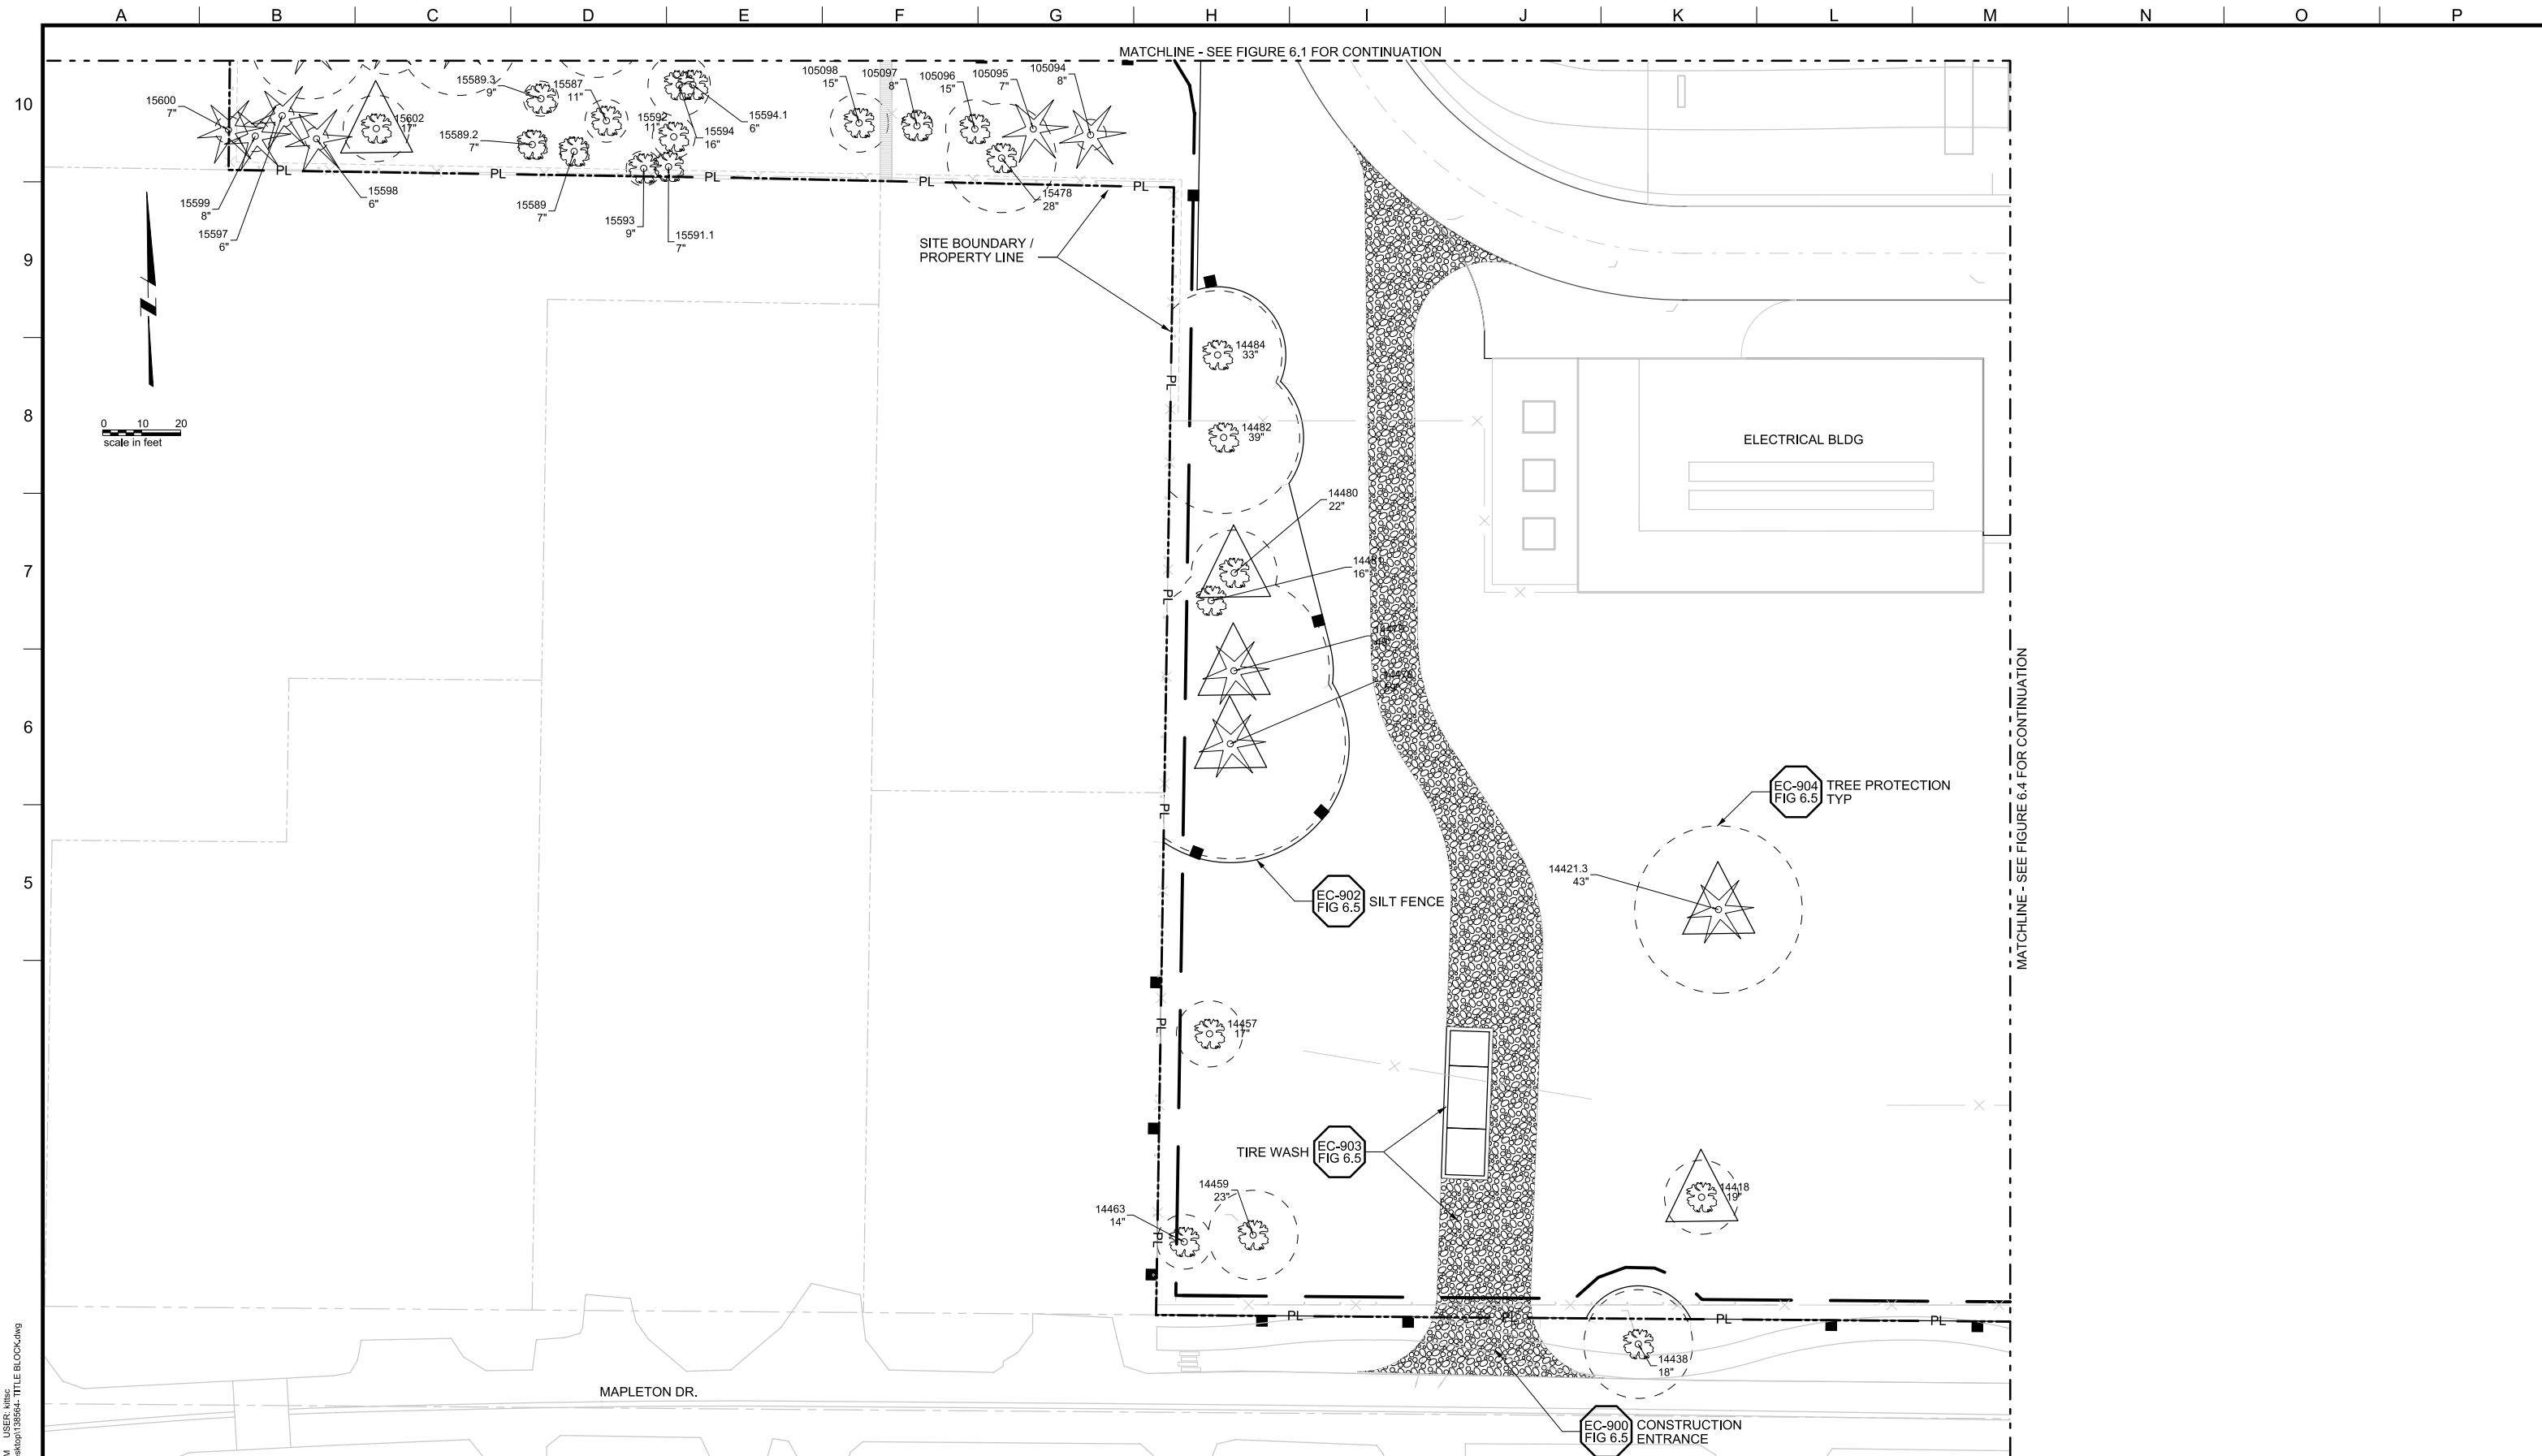
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LAKE OSWEGO AND TIGARD WATER TREATMENT PLANT  
 DESIGN REVIEW AND CONDITIONAL USE  
**CONSTRUCTION MANAGEMENT**  
 AREA A

FILENAME	
PROJECT NUMBER	
SCALE	1" = 20'
DRAWING/FIGURE NUMBER	6.1
### OF	



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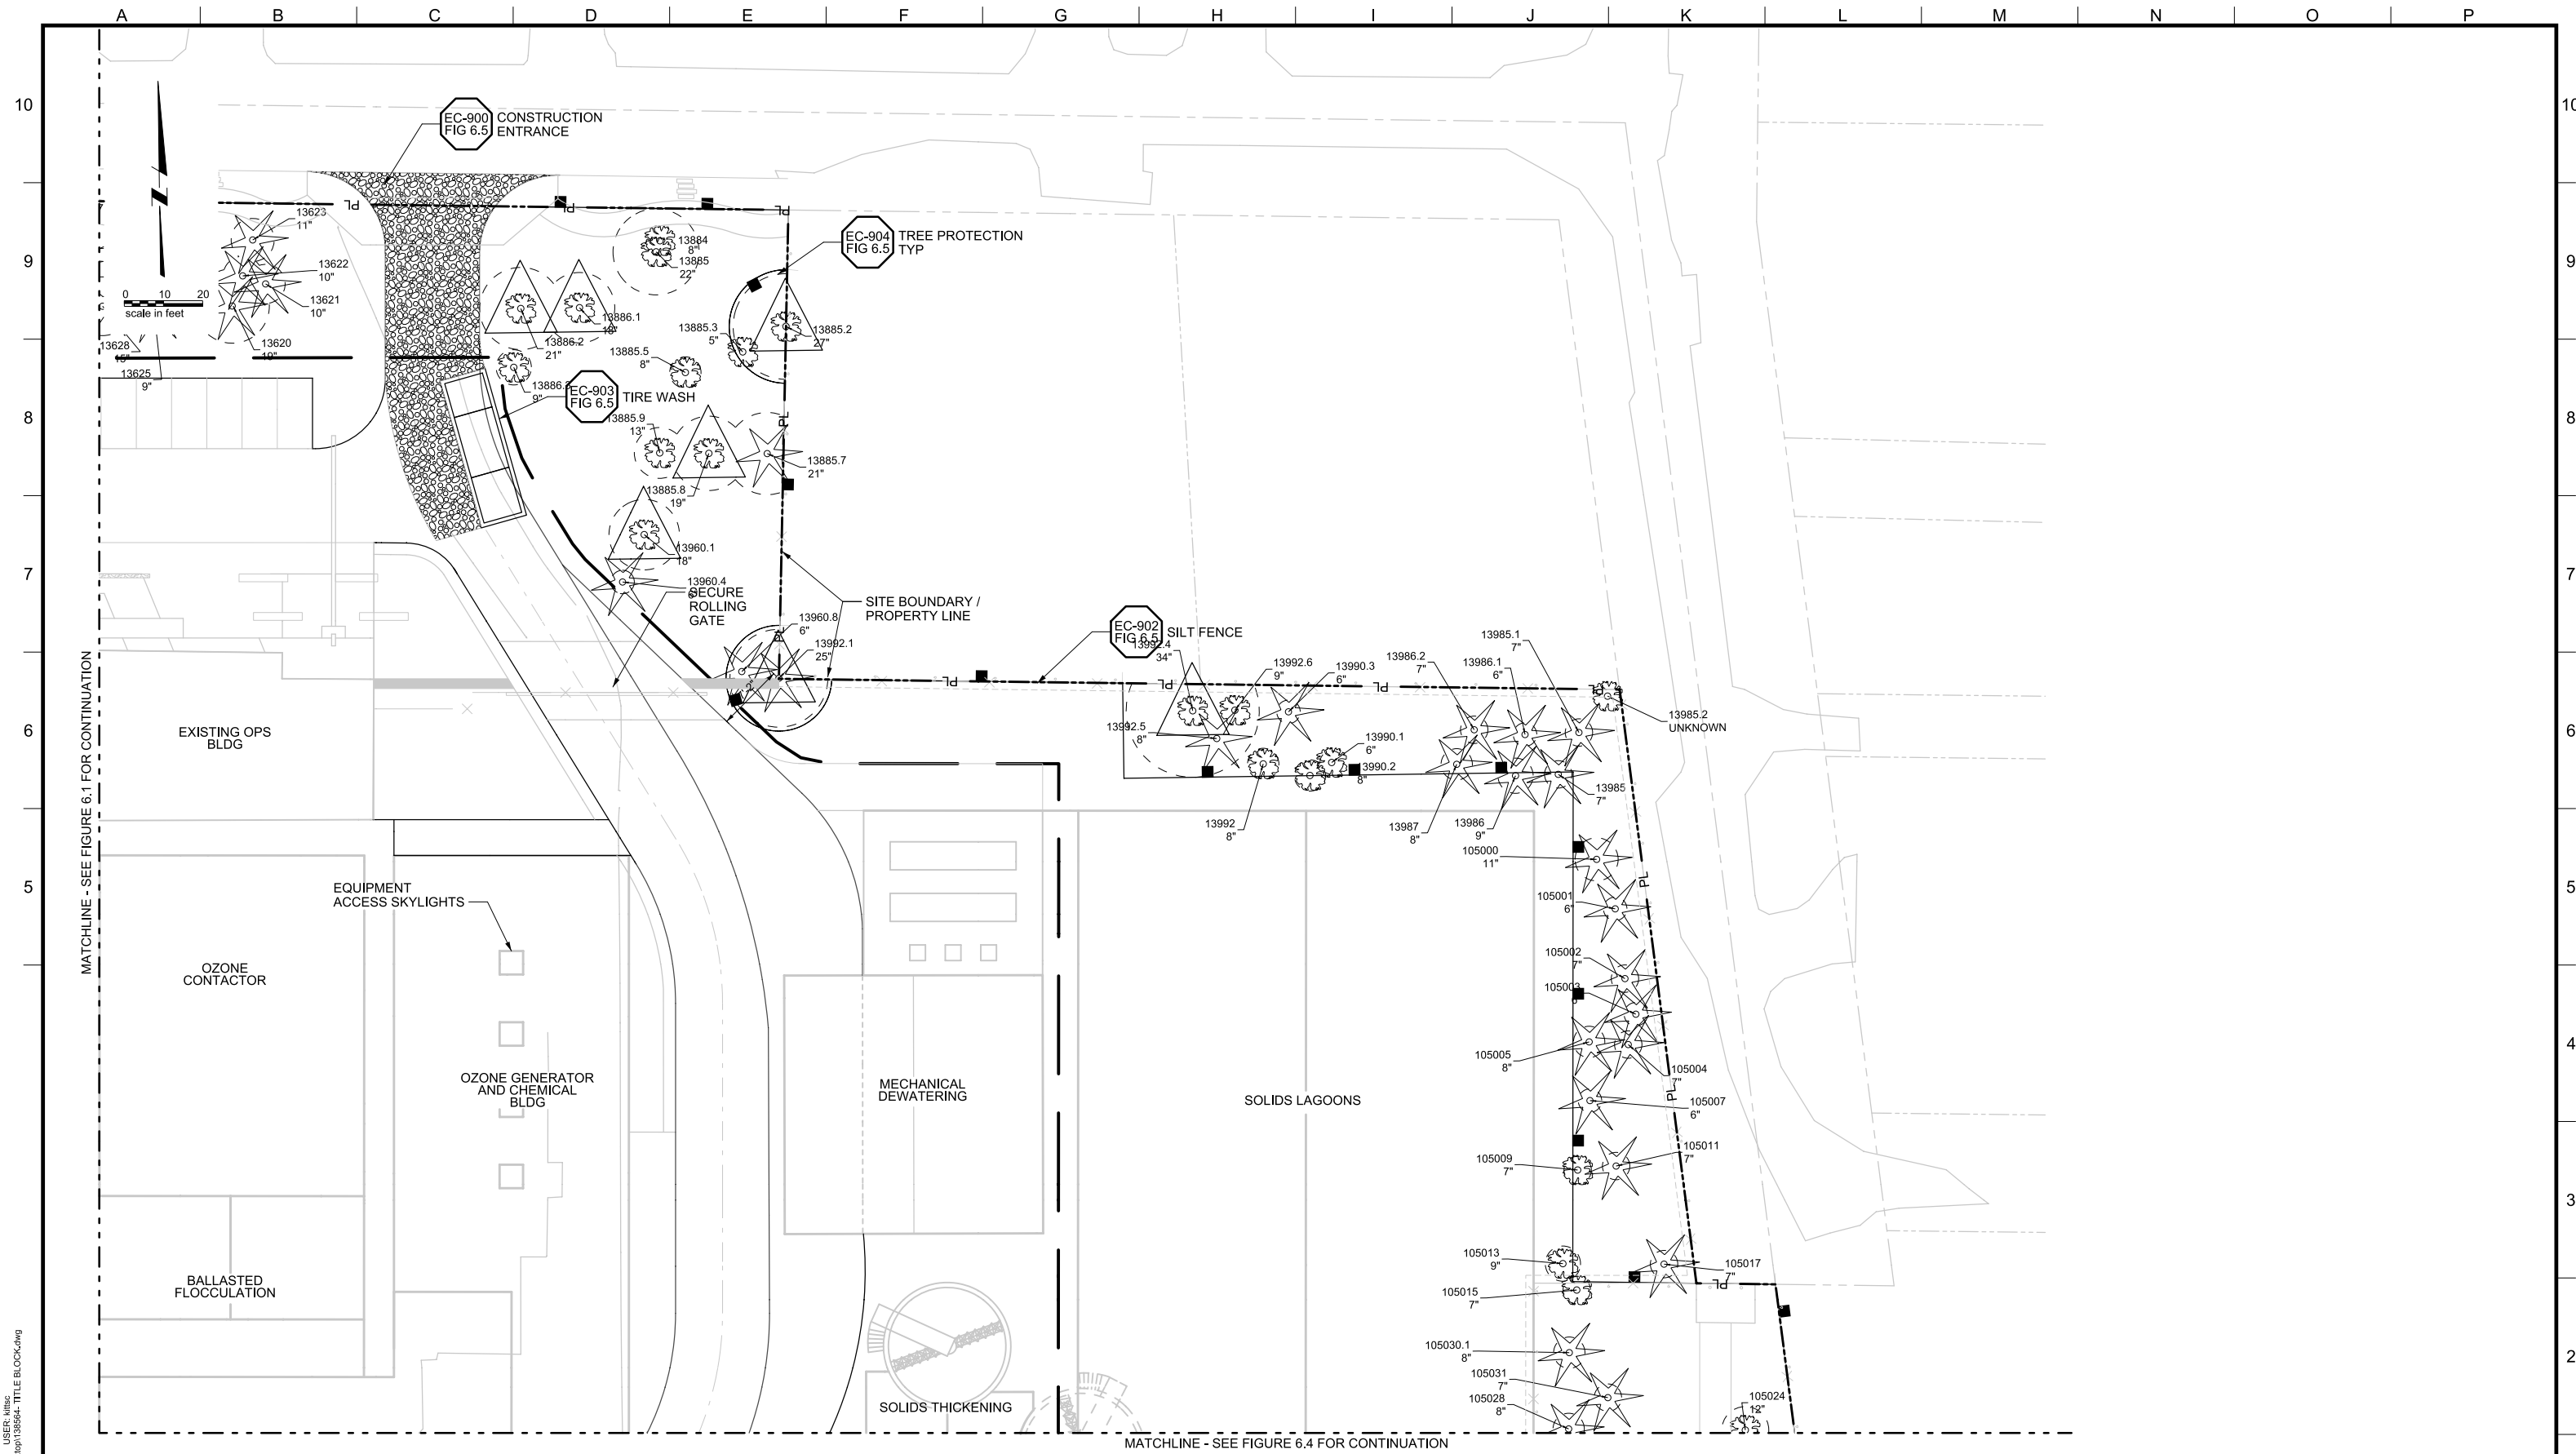
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 PHONE: 503-635-0270



LAKE OSWEGO AND TIGARD WATER TREATMENT PLANT  
 DESIGN REVIEW AND CONDITIONAL USE  
**CONSTRUCTION MANAGEMENT**  
 AREA B

FILENAME	
PROJECT NUMBER	
SCALE	1" = 20'
DRAWING/FIGURE NUMBER	6.2
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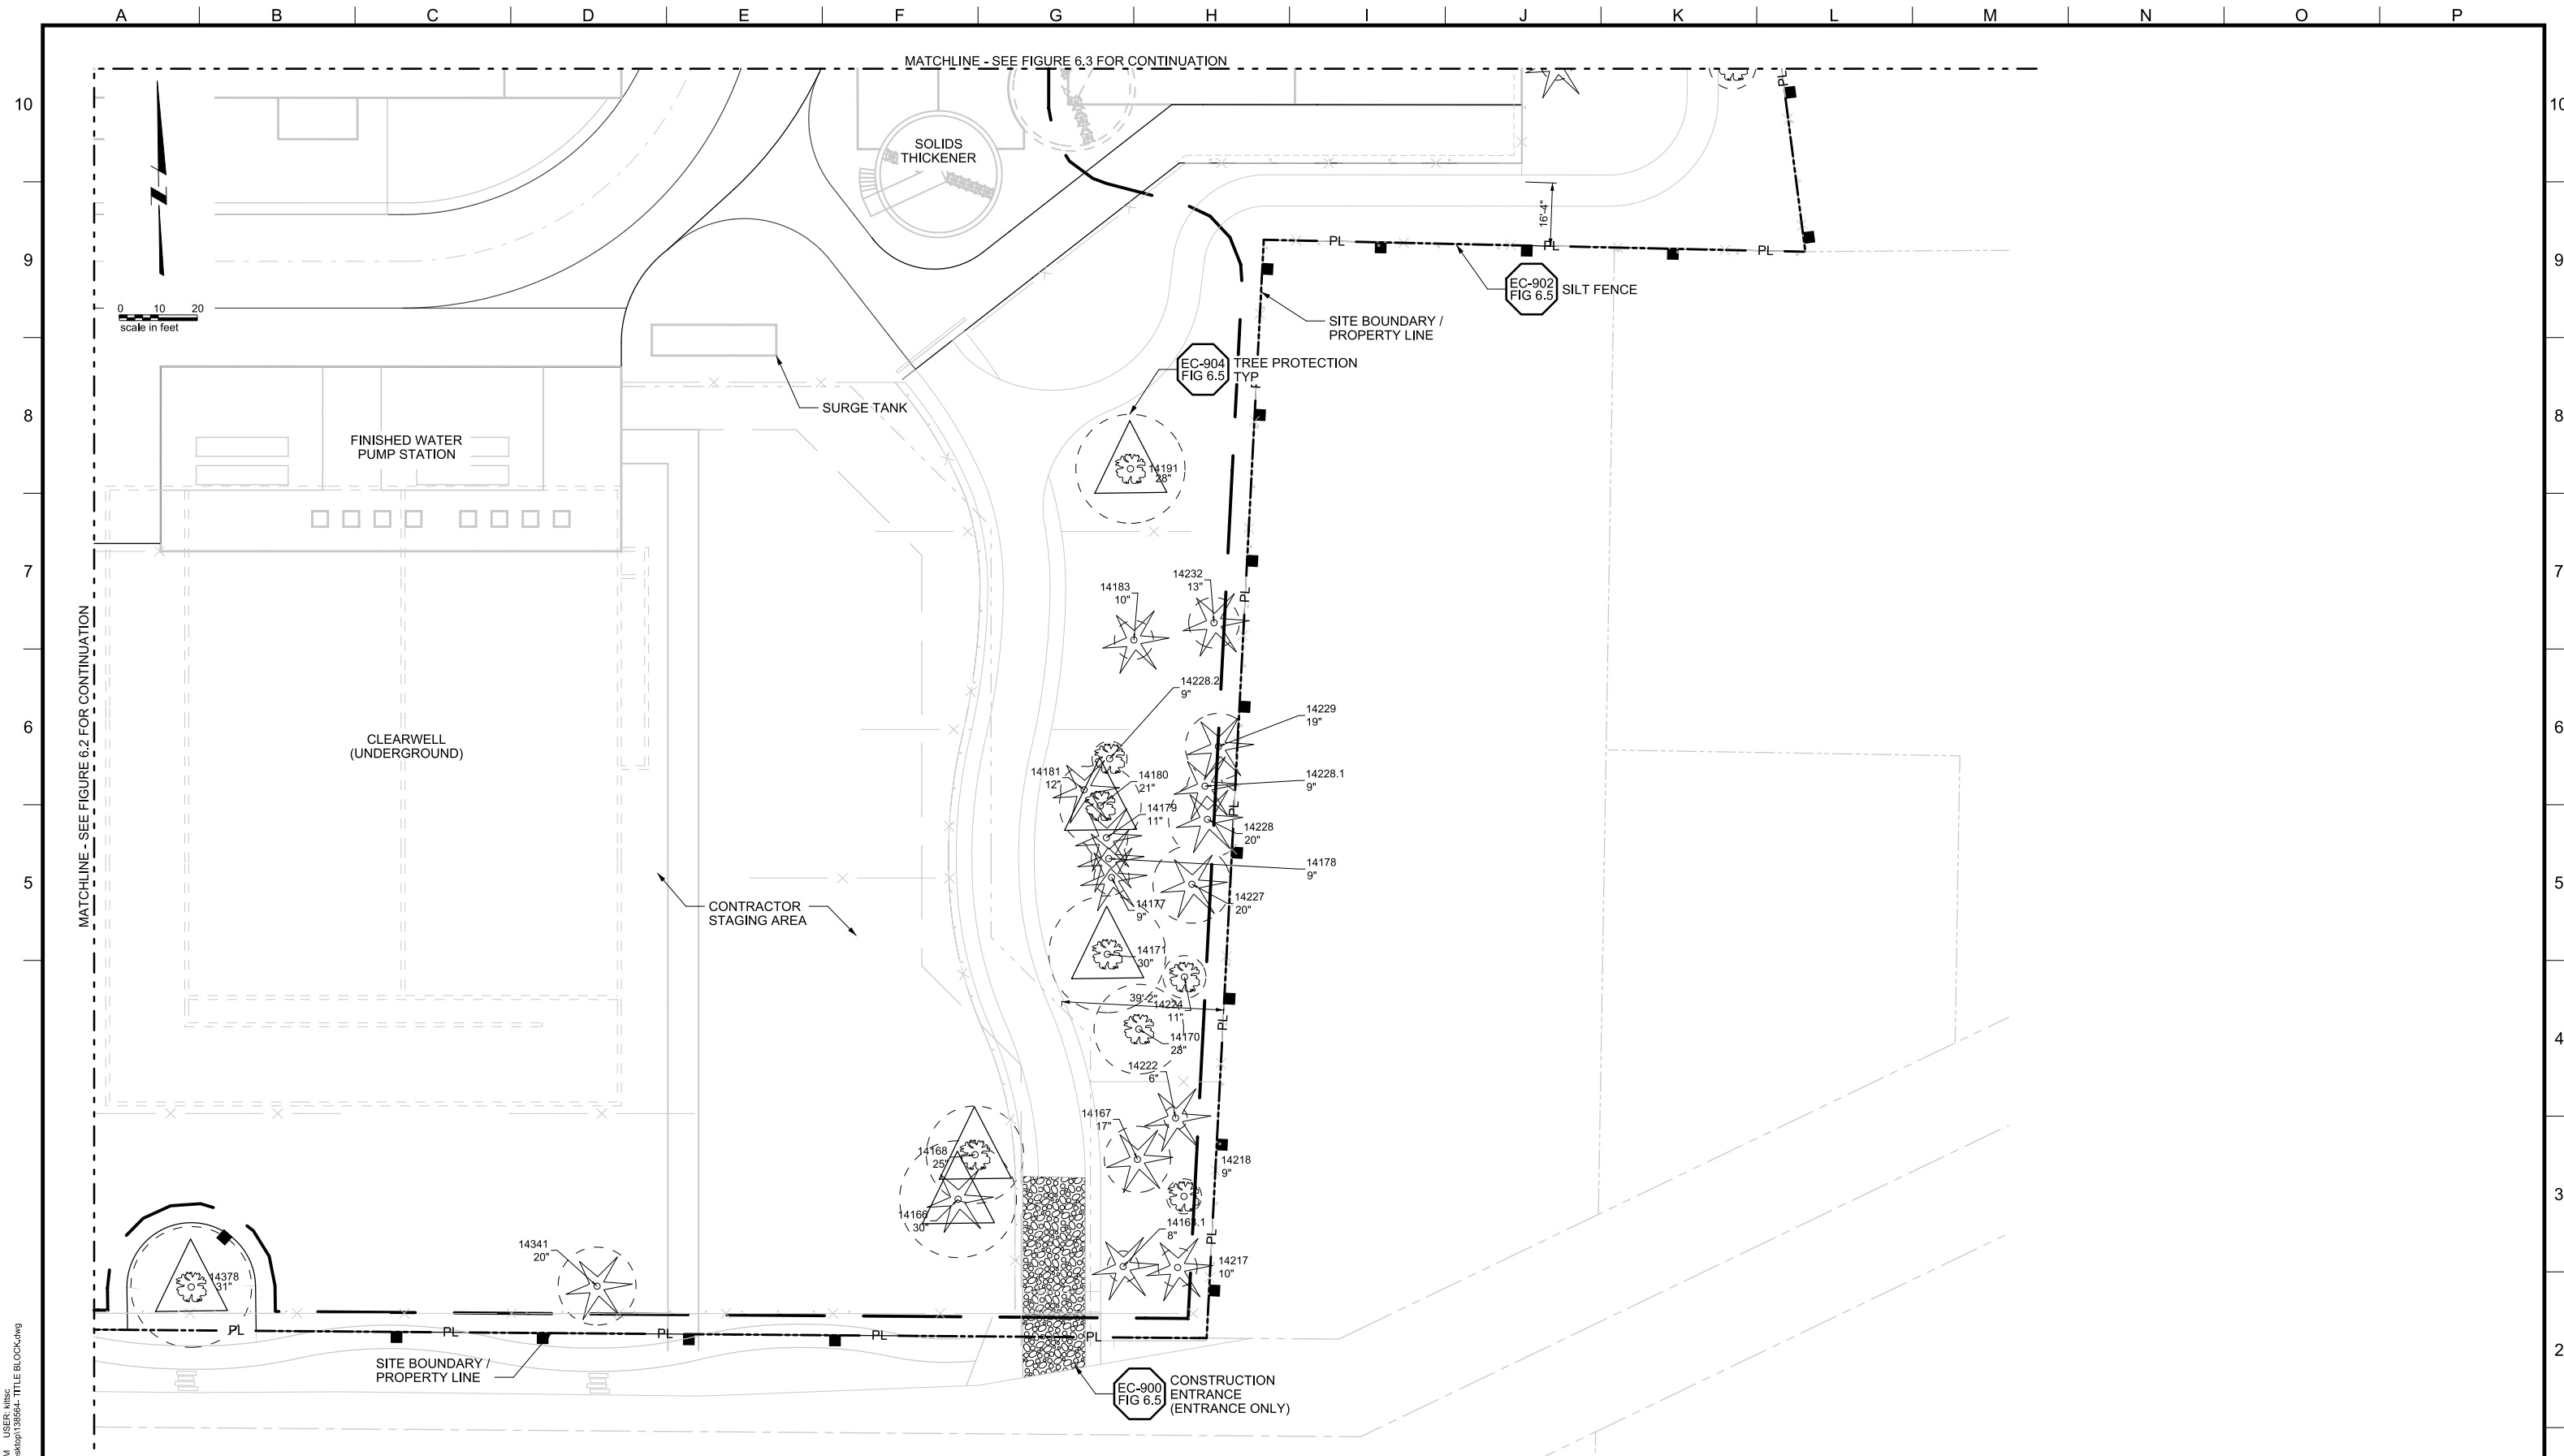
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 LAKE OSWEGO, OR 97034  
 PHONE: 503-635-0270



LAKE OSWEGO AND TIGARD WATER TREATMENT PLANT  
 DESIGN REVIEW AND CONDITIONAL USE  
 CONSTRUCTION MANAGEMENT  
 AREA C

FILENAME	
PROJECT NUMBER	
SCALE	1" = 20'
DRAWING/FIGURE NUMBER	6.3
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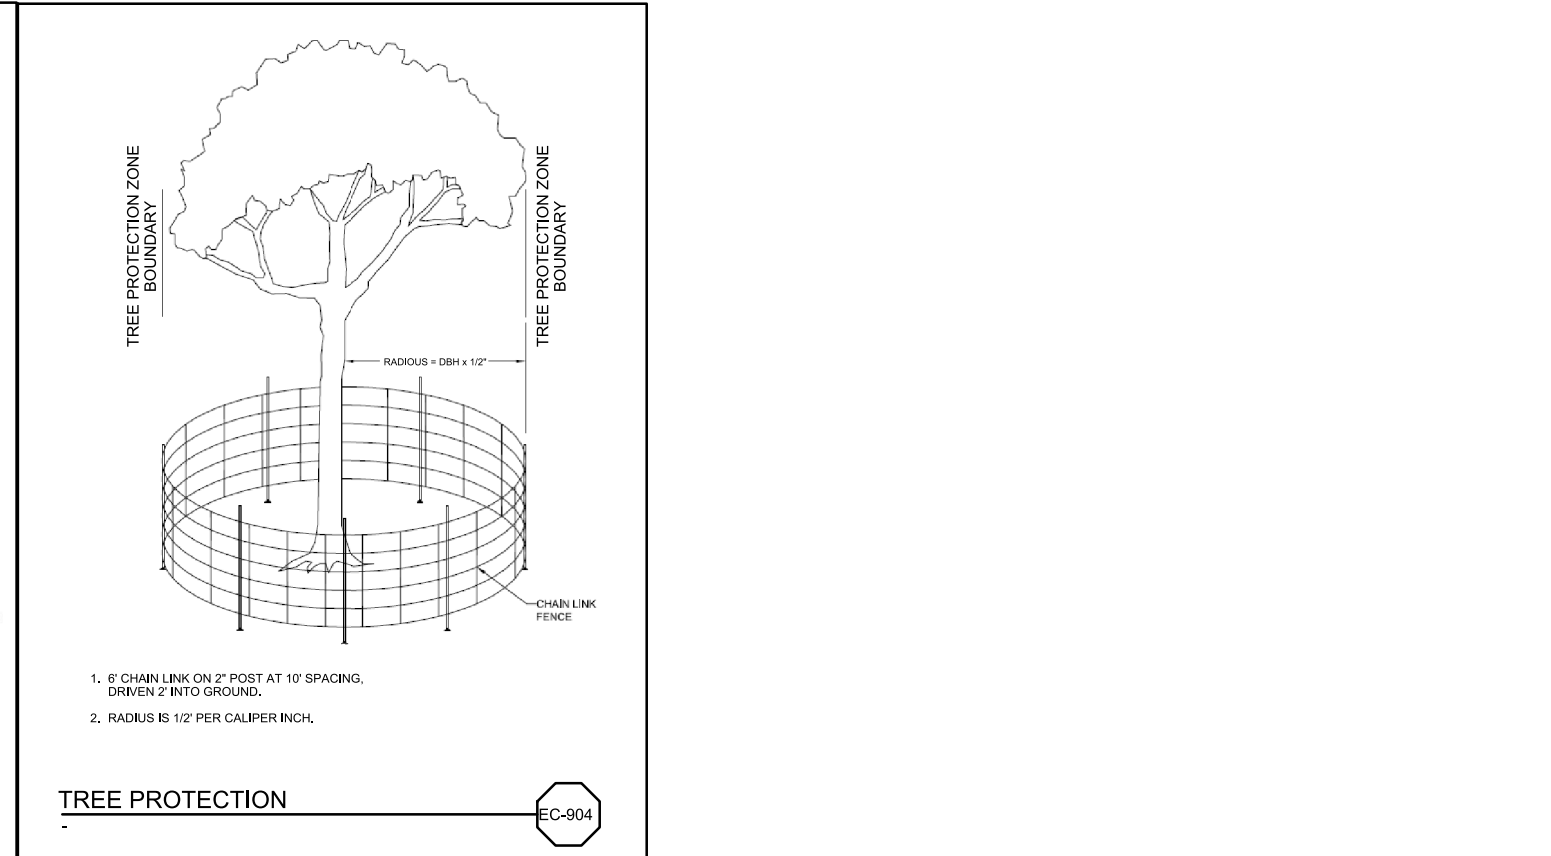
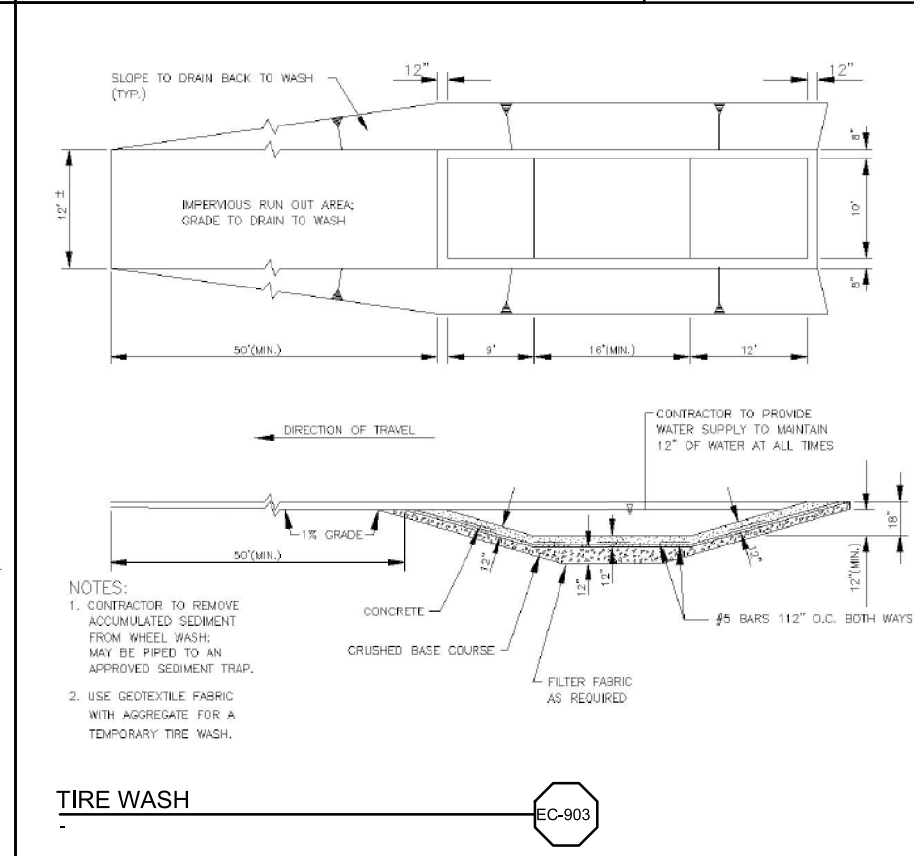
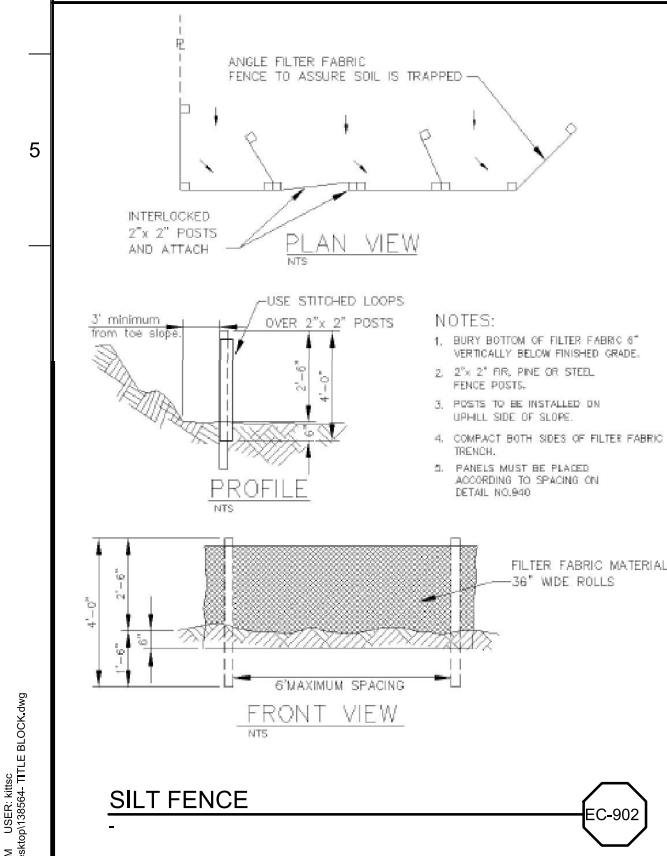
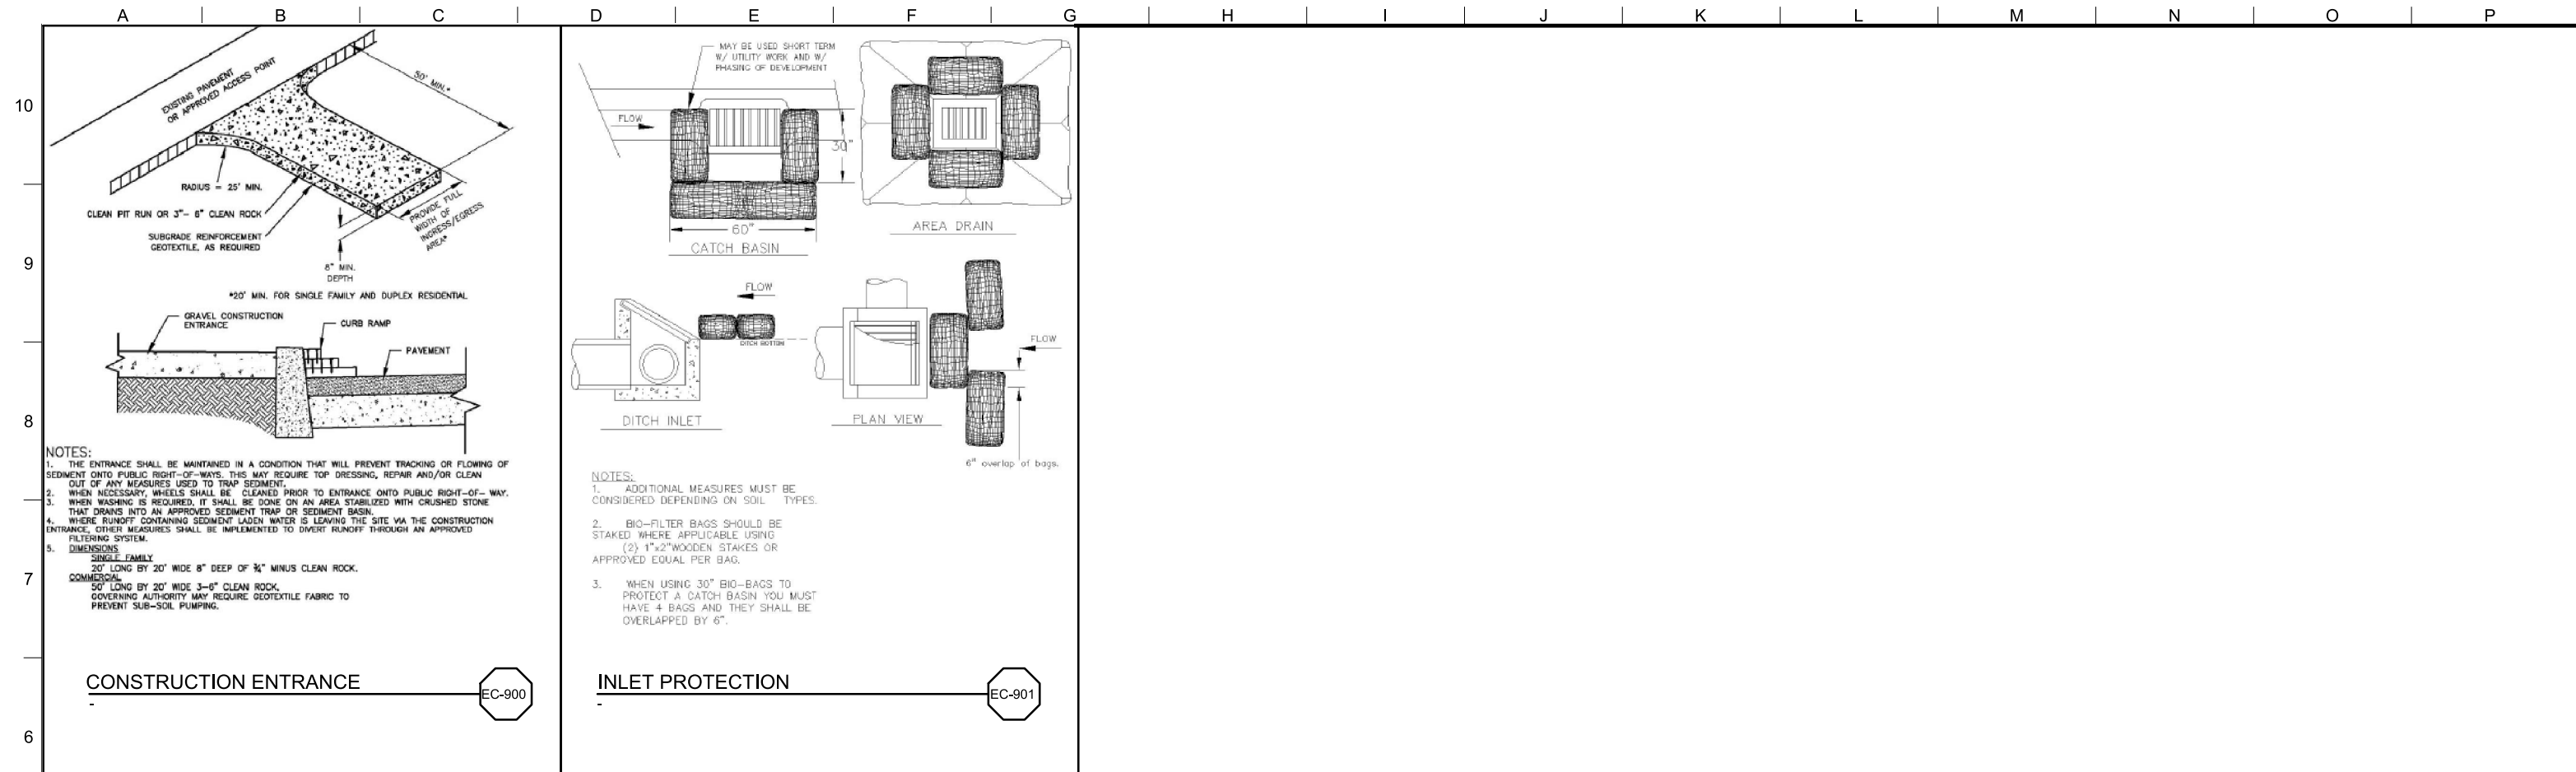
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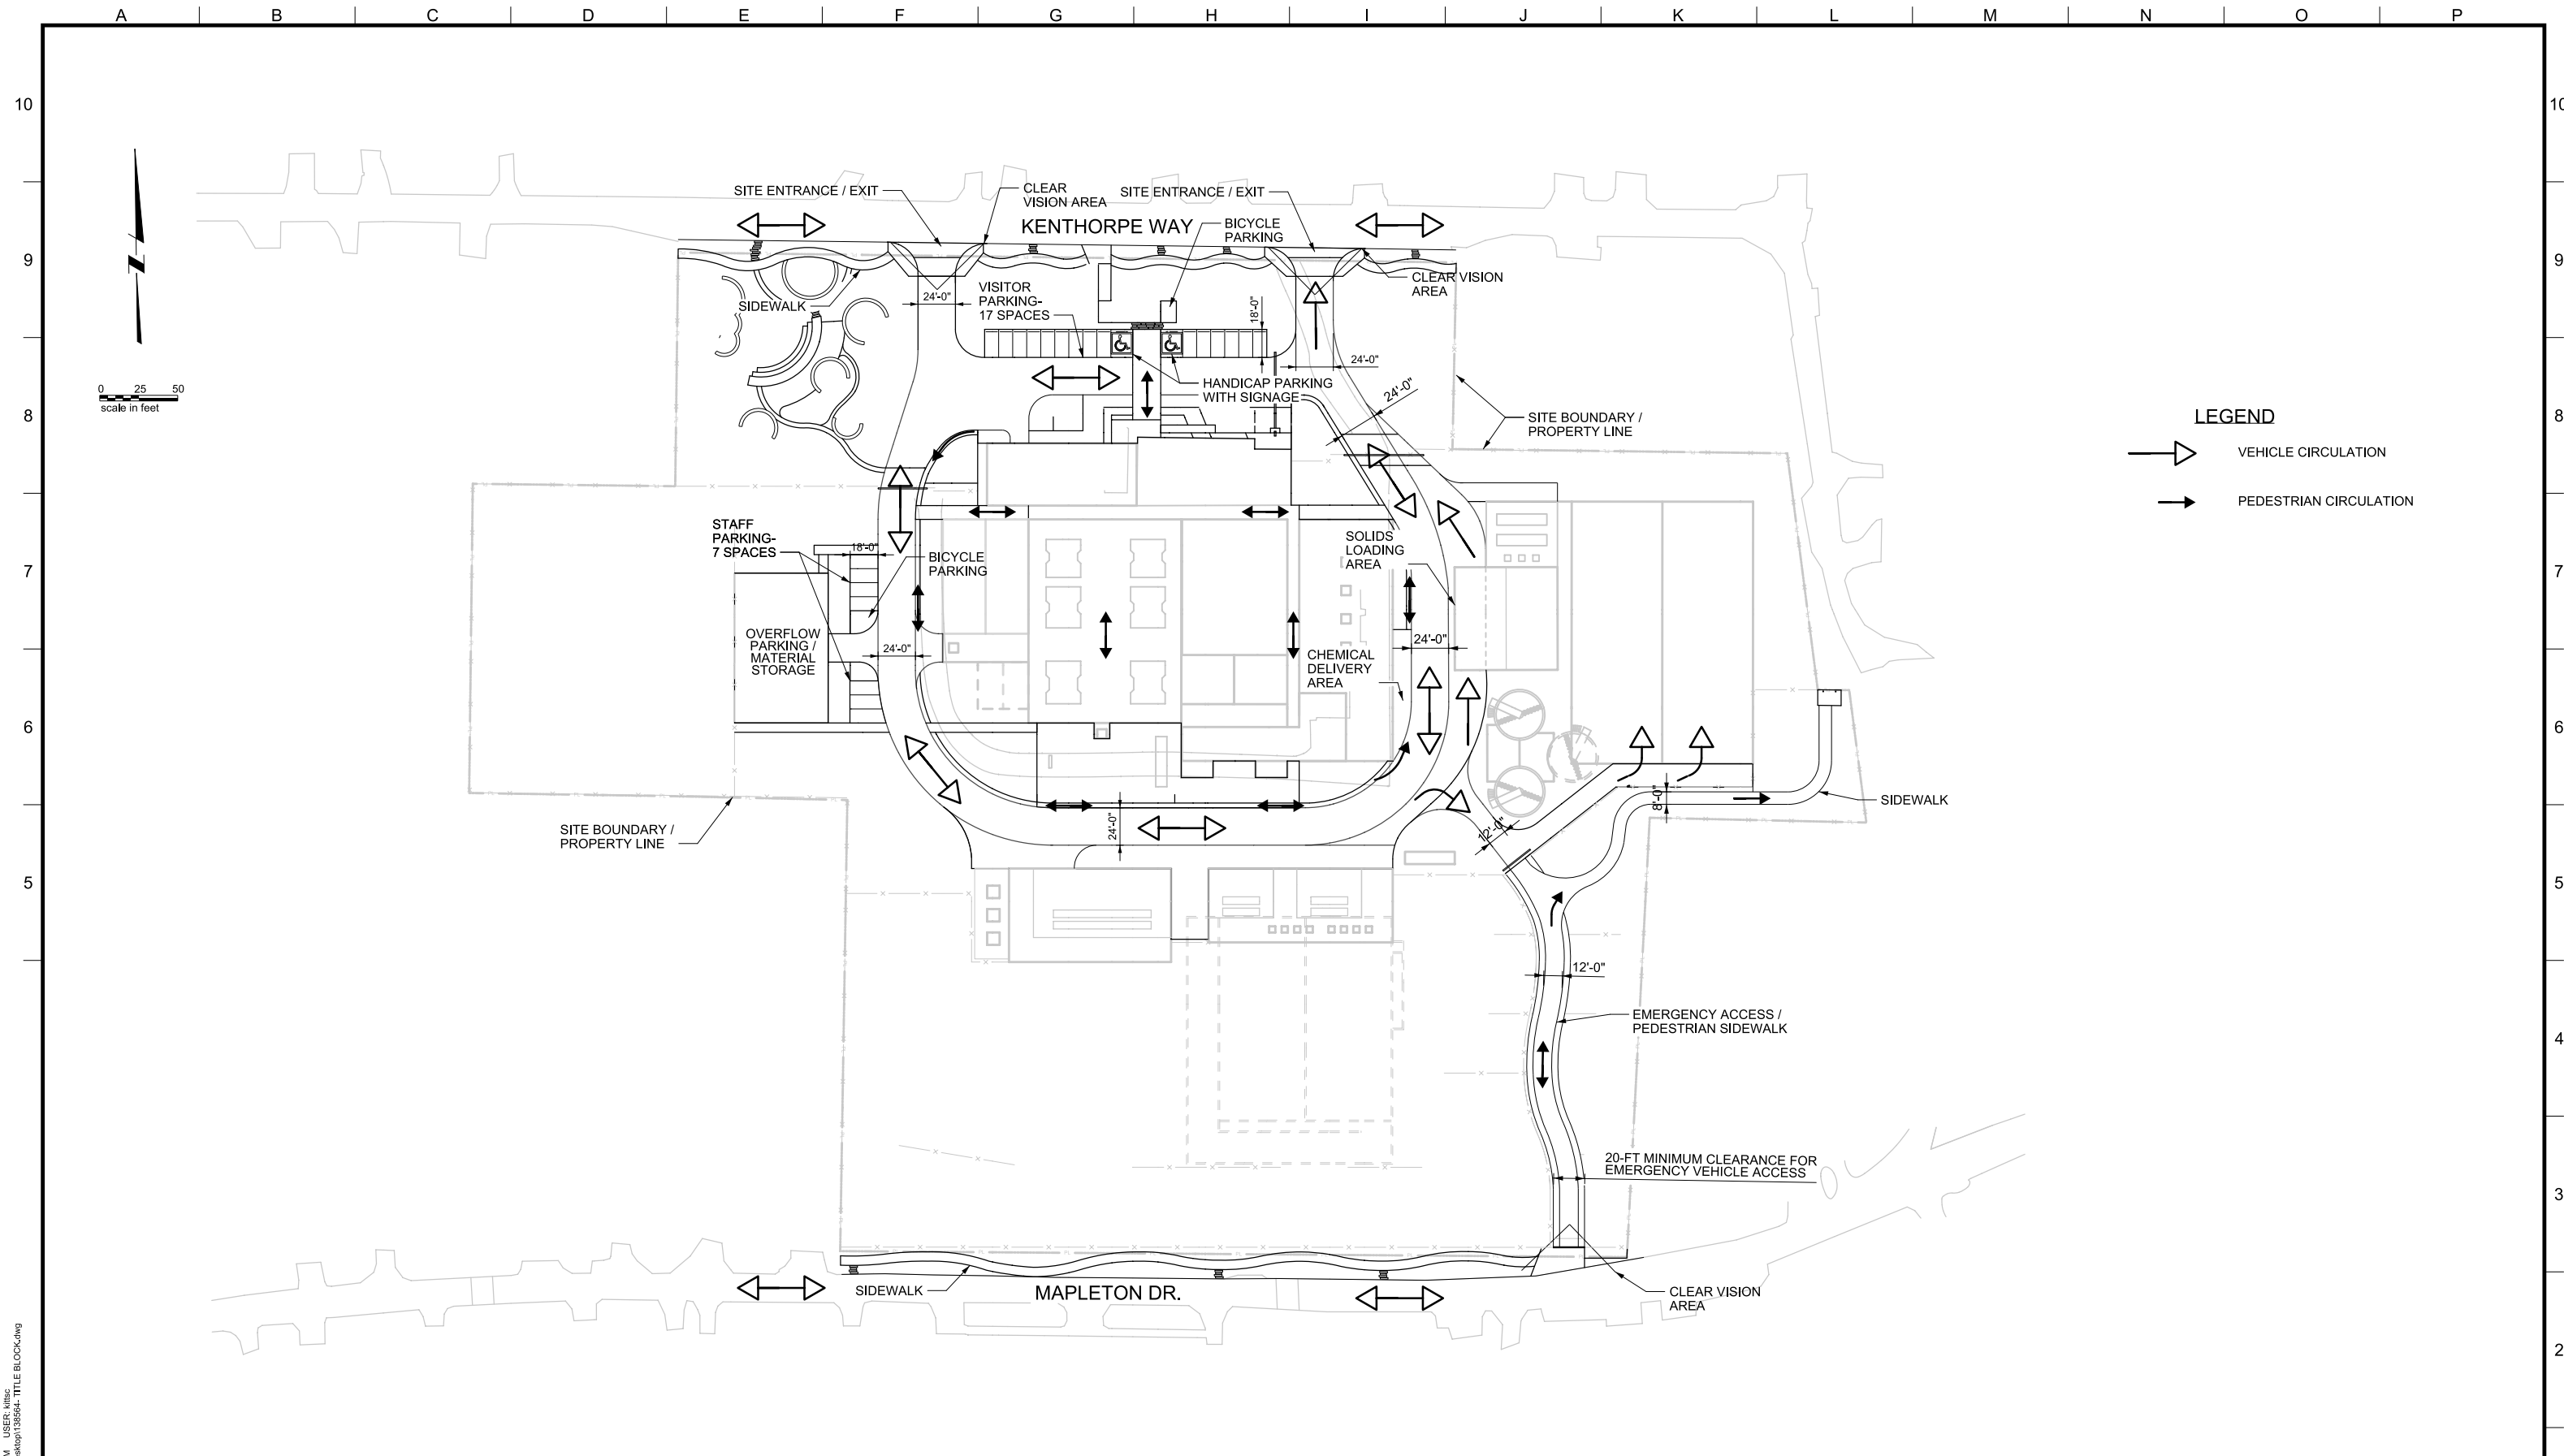


LAKE OSWEGO AND TIGARD WATER TREATMENT PLANT  
 DESIGN REVIEW AND CONDITIONAL USE  
**CONSTRUCTION MANAGEMENT**  
 AREA D

FILENAME	
PROJECT NUMBER	
SCALE	1" = 20'
DRAWING/FIGURE NUMBER	<b>6.4</b>
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<p><b>MWH</b> 806 SW BROADWAY, SUITE 200 PORTLAND, OREGON 97205</p>	<p>LINE IS 2 INCHES AT FULL SIZE (IF NOT 2" - SCALE ACCORDINGLY)</p> <p>DESIGNED: ####</p> <p>DRAWN: ####</p> <p>CHECKED: ####</p> <p>CHECKED: ####</p> <p>APPROVED: ####</p>	<p>REVISIONS</p> <table border="1"> <thead> <tr> <th>REV.</th> <th>DESCRIPTION</th> <th>BY</th> <th>APP.</th> </tr> </thead> <tbody> <tr> <td> </td> <td> </td> <td> </td> <td> </td> </tr> <tr> <td> </td> <td> </td> <td> </td> <td> </td> </tr> </tbody> </table>	REV.	DESCRIPTION	BY	APP.									<p>OWNER: CITY OF LAKE OSWEGO 380 A AVENUE LAKE OSWEGO, OR 97034 PHONE: 503-635-0270</p>	<p>Lake Oswego - Tigard Water Partnership sharing water - connecting communities</p>	<p>LAKE OSWEGO AND TIGARD WATER TREATMENT PLANT DESIGN REVIEW AND CONDITIONAL USE CONSTRUCTION MANAGEMENT DETAILS I</p>	<p>FILENAME PROJECT NUMBER SCALE NONE DRAWING/FIGURE NUMBER 6.5 XXX OF</p>
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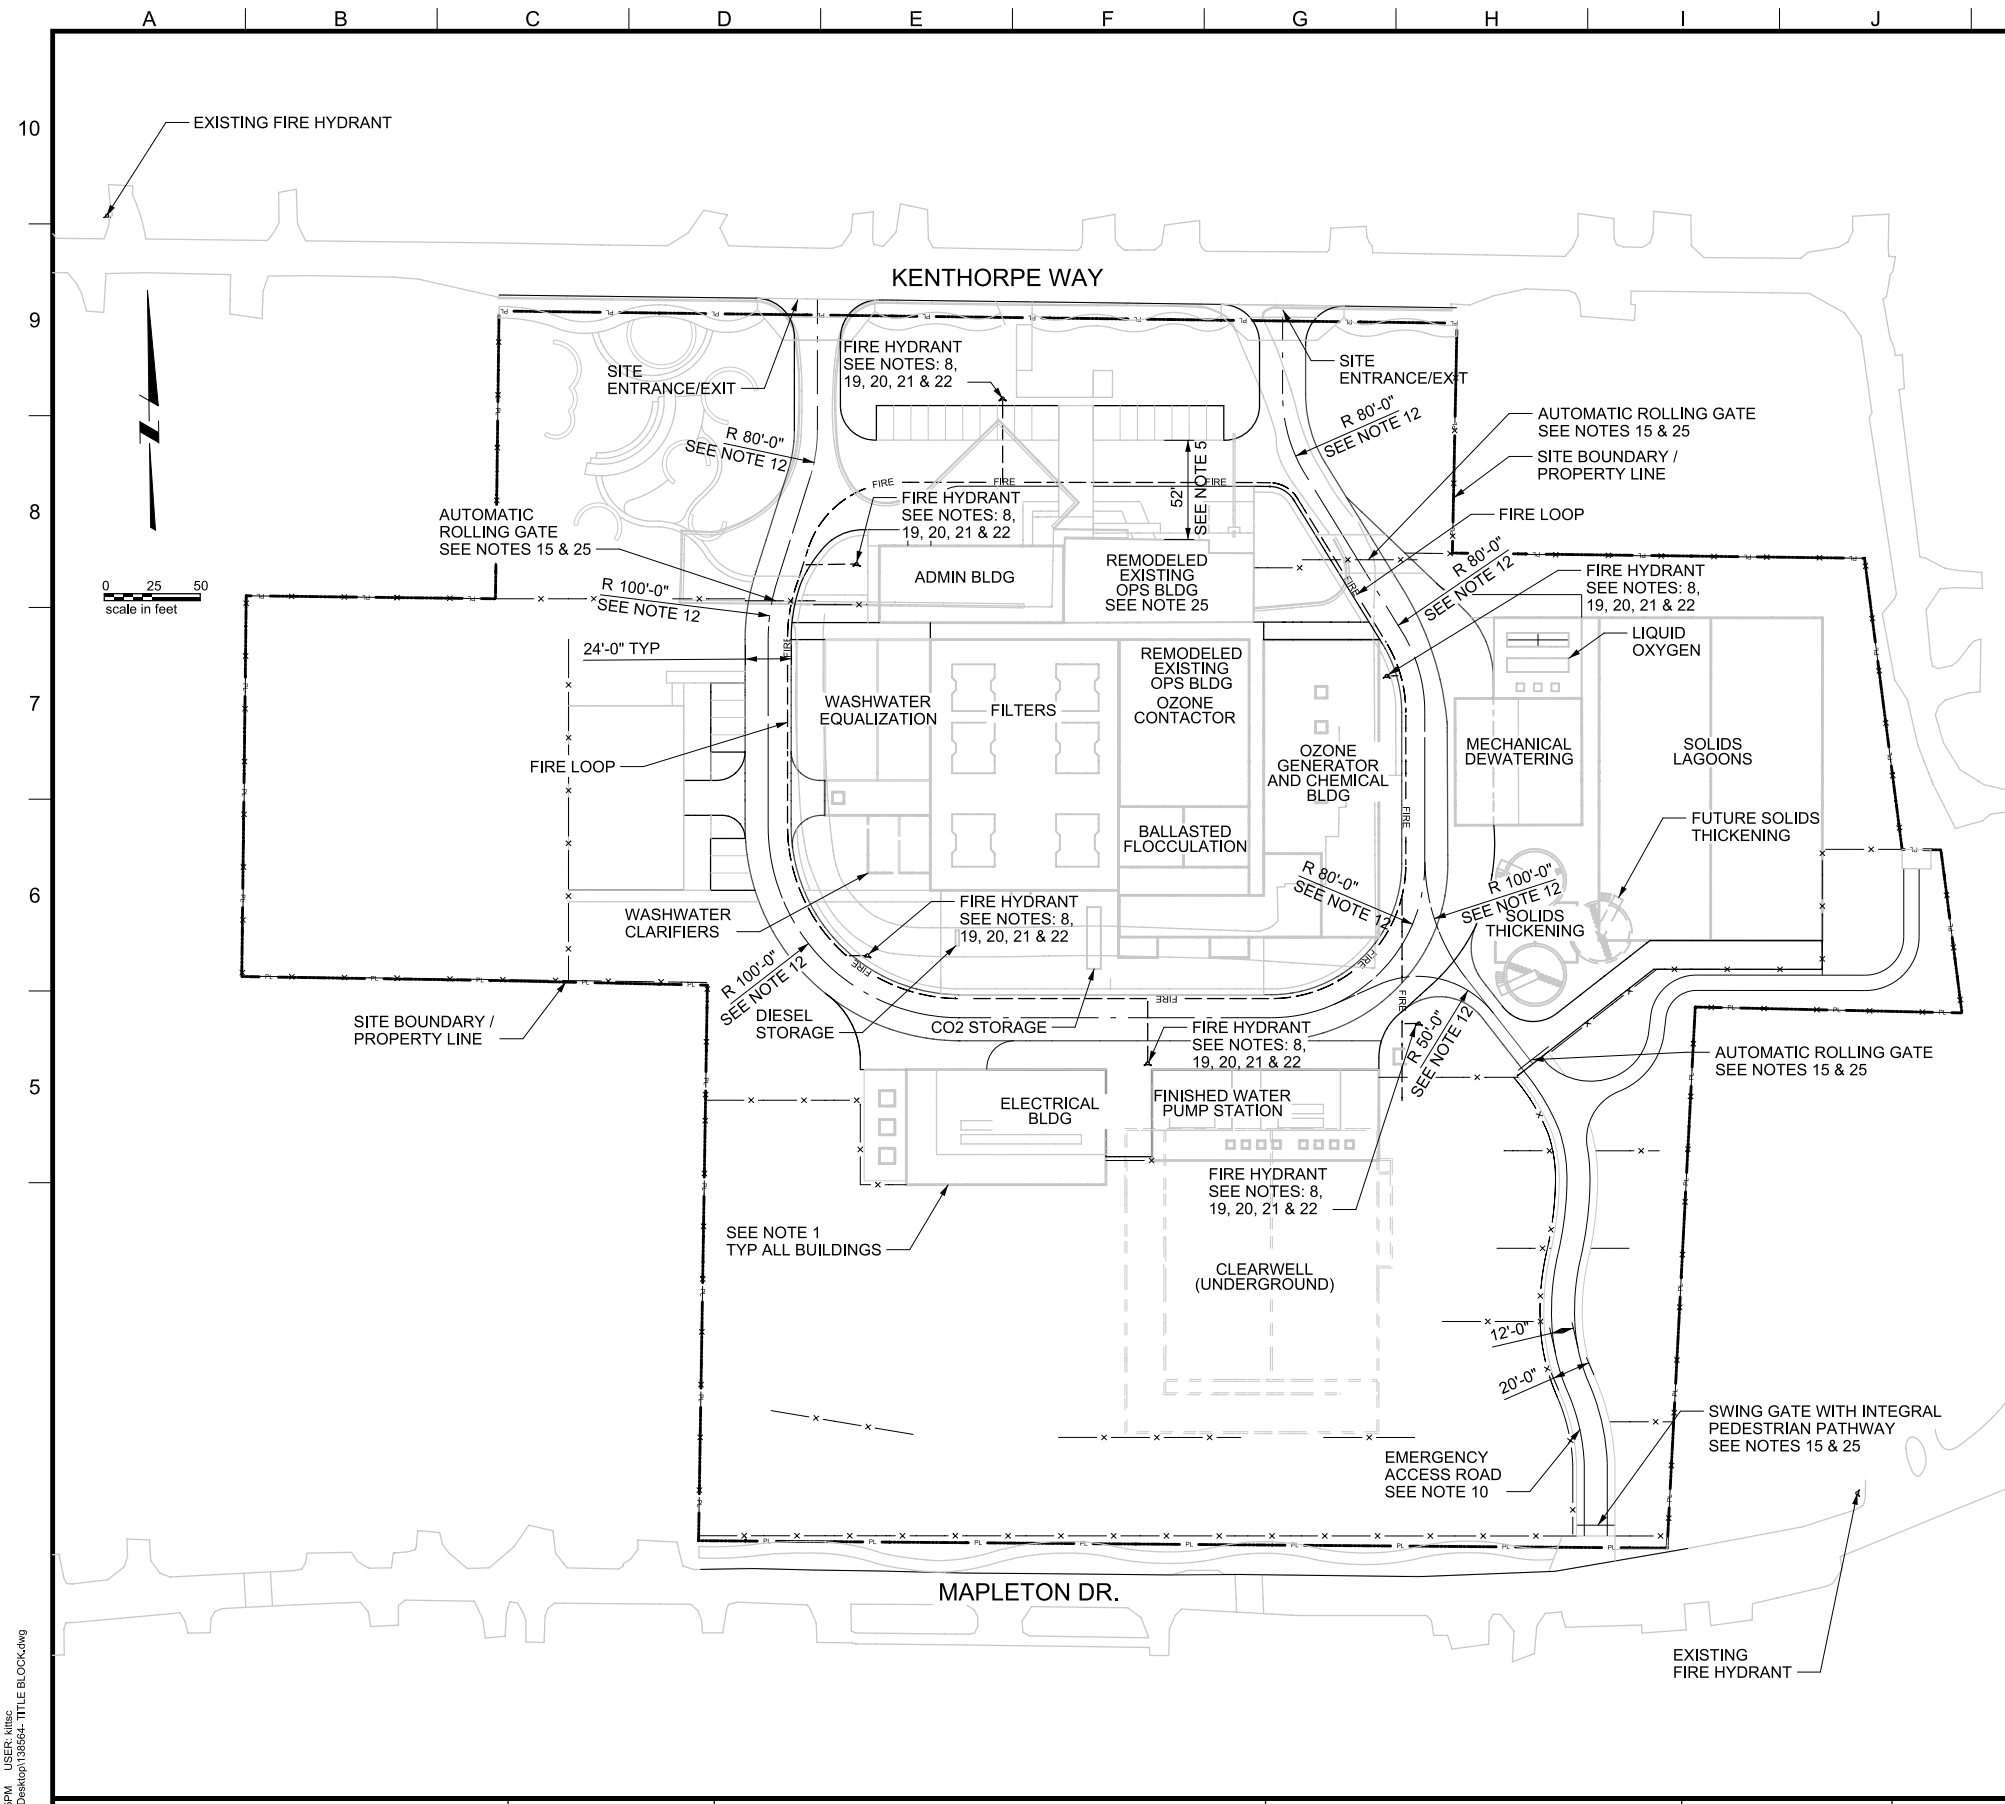
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REV.	DESCRIPTION	BY	DATE	APP.

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380 A AVENUE  
LAKE OSWEGO, OR 97034  
PHONE: 503-635-0270



LAKE OSWEGO AND TIGARD WATER TREATMENT PLANT  
DESIGN REVIEW AND CONDITIONAL USE  
**PEDESTRIAN AND VEHICLE  
CIRCULATION PLAN**

FILENAME	
PROJECT NUMBER	
SCALE	1" = 50'
DRAWING/FIGURE NUMBER	7.0
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- GENERAL SHEET NOTES
- THE FOLLOWING POINTS ARE RESPONSES TVFR CRITERIA SUMMARIZED IN A LETTER DATED OCT. 28, 2011
  - THE EXTERIOR OF WALLS SHALL BE LOCATED WITHIN 150 FT OF AN ACCESS ROAD, IN COMPLIANCE WITH OFC 503.1.1.
  - THE SITE DESIGN WILL NOT INCLUDE DEAD-END ROADS, THEREFORE OFC 503.2.5 DOES NOT APPLY.
  - THE PRELIMINARY AND FINAL DESIGN WILL DEMONSTRATE COMPLIANCE WITH OFC 503.1.1. THE OPERATIONS AND ADMINISTRATION BUILDINGS WILL BE SPRINKLED. THE DESIGN TEAM WILL WORK COLLABORATIVELY WITH TVFR RE: DETERMINATION OF THE NEED FOR SPRINKLING IN OTHER PROCESS AREAS, INCLUDING THE GALLERIES AND ELECTRICAL ROOMS.
  - THE MAXIMUM BUILDING HEIGHTS ARE CURRENTLY CONSIDERED TO BE: EXISTING OPERATIONS - 35 FT. ADMINISTRATION - 29 FT. MECHANICAL DEWATERING - 30 FT. FINISH WATER PUMP STATION - 30 FT. ELECTRICAL/MAINTENANCE BUILDING - 30 FT. CHEMICAL BUILDING - 32 FT. THOUGH NOT ANTICIPATED RESULT IN MAJOR MODIFICATIONS, THESE HEIGHTS ARE SUBJECT TO FURTHER REFINEMENT DURING DETAILED DESIGN. IN NO EVENT SHALL A BUILDING HEIGHT EXCEED 35 FT. THEREFORE, THE CURRENT SITE DESIGN WILL INCLUDE FIRE AND EMERGENCY ACCESS ROUTES FROM KENTHORPE WAY AND MAPLETON DRIVE. PRELIMINARY AND FINAL DESIGN WILL DEMONSTRATE COMPLIANCE WITH OFC D104.
  - THE VISITOR PARKING LOT ABUTTING THE ADMINISTRATION AND OPERATIONS BUILDINGS PROVIDES APPROXIMATELY 52 FT OF UNOBSTRUCTED ACCESS TO THE BUILDINGS. THE INTERNAL ACCESS ROADWAY WHICH PROVIDES ACCESS TO THE OTHER BUILDINGS 30 FT OR TALLER IS CURRENTLY PROPOSED TO BE 24 FT WIDE WITHOUT CURBS. ON EITHER SIDE OF THE INTERNAL ACCESS ROAD THERE IS A CLEAR AND UNOBSTRUCTED SPACE WHICH, WHEN ADDED TO THE PROPOSED 24 FT ACCESS ROAD WIDTH, WILL EXCEED THE 26 FT STANDARD IN ALL AREAS, HOWEVER IF THIS IS NOT ACCEPTABLE TO THE TVFR, THE INTERNAL ACCESS ROAD CAN BE DESIGNED TO MEET THE 26 FT ROAD WIDTH STANDARD PER OFC D105.
  - THE SITE WILL PROVIDE AN EMERGENCY ACCESS ROUTE ON BOTH KENTHORPE WAY AND MAPLETON DRIVE IN COMPLIANCE WITH OFC D104.3.
  - PER DISCUSSIONS WITH TVFR, THIS REQUIREMENT APPLIES TO RESIDENTIAL CONSTRUCTION WITH ROADSIDE PARKING AND IS NOT APPLICABLE TO THE WTP PROJECT.
  - THE FIRE HYDRANTS SHALL BE SPACED NO FURTHER THAN 500 FT APART AROUND THE PERIMETER OF THE INTERNAL ACCESS ROAD AND IN FRONT OF THE ADMINISTRATION AND OPERATIONS BUILDINGS PER OFC D103.1.
  - DEDICATED OFF-ROAD STAFF PARKING IS CURRENTLY INCLUDED IN THE SITE LAYOUT; NO PARKING ALONG THE INTERNAL ACCESS ROUTE WILL BE REQUIRED/ALLOWED. SEE NOTE 5 FOR DISCUSSION OF THE ROADWAY SHOULDER ALONG THE 24 FT WIDE PROPOSED ACCESS ROADWAY THAT PROVIDES >26 FT EFFECTIVE WIDTH THROUGHOUT THE PLANT. FOR THESE REASONS, NO "NO PARKING" SIGNS ARE CURRENTLY INCLUDED IN THE DESIGN.
  - THE KENTHORPE WAY ACCESS, VISITOR PARKING AREA AND INTERNAL ACCESS ROAD WILL COMPLY WITH OFC D102.1. THE EMERGENCY ACCESS ROAD FROM MAPLETON DRIVE WILL COMPLY WITH THIS STANDARD BY PROVIDING A 12 FT WIDE PAVED SURFACE AND TWO 4 FT SHOULDERS MADE OF PERVIOUS MATERIAL, SUCH AS "GRASS PAVE", THAT WILL COMPLY WITH THIS STANDARD. THE ENTIRE SOUTHERN EMERGENCY ACCESS ROAD WILL PROVIDE A 20 FT WIDE UNOBSTRUCTED ACCESS ROAD THAT IS CAPABLE OF SUPPORTING A 60,000 POUND LIVE LOAD.
  - THERE ARE NO BRIDGES ON SITE; THEREFORE OFC 503.2.6 IS NOT APPLICABLE.
  - THE TURNING RADI ON ALL DRIVEWAY APPROACHES AND ALONG THE INTERNAL ACCESS ROAD SHALL MEET OR EXCEED OFC 503.2.4 AND D103.3.
  - PER DISCUSSIONS WITH TVFR, OFC 503.3 APPLIES TO STREETS AND DOES NOT APPLY TO THE INTERNAL ACCESS ROAD OR VISITOR PARKING LOT.
  - THE GRADE ACROSS THE ENTIRE SITE DOES NOT EXCEED 2%; THEREFORE ORS 455.610(5), OFC 503.2.7 AND D103.2 ARE MET.
  - ACCESS TO THE INTERNAL COMPOUND AREA SHALL BE CONTROLLED BY AUTOMATIC ROLLING GATES. ACCESS TO THE EMERGENCY ACCESS ROAD OFF OF MAPLETON DRIVE WILL BE CONTROLLED BY A SWING GATE WITH AN INTEGRAL PEDESTRIAN PASSAGEWAY. PER OFC D103.5.
  - THE WTP PROVIDES ALL OF ITS OWN WATER FOR FIRE FLOW, AS WELL AS FOR CONSUMPTION. DURING THE DESIGN PHASE, THE APPLICANT SHALL PROVIDE FIRE FLOW CALCULATIONS FOR EACH BUILDING ON SITE, AND WILL SHARE DESIGN CALCULATIONS OF THE DISTRIBUTION PIPING TO DEMONSTRATE COMPLIANCE WITH IFC B105.3.
  - FIRE HYDRANTS WILL BE PROVIDED ON-SITE AND AROUND THE PERIMETER OF THE INTERNAL ACCESS ROAD AND IN FRONT OF THE ADMINISTRATION AND OPERATIONS BUILDINGS PER OFC 508.5.1.
  - LOCATION OF EACH FIRE HYDRANT ON-SITE IN COMPLIANCE WITH APPENDIX C, TABLE C 105.1.
  - NO FIRE HYDRANT WILL BE MORE THAN 15 FT AWAY FROM AN APPROVED ACCESS ROAD PER OFC C102.1.
  - IDENTIFY AND MARK FIRE HYDRANTS WITH BLUE MARKERS ADJACENT TO THE SIDE OF THE CENTERLINE OF THE ACCESS ROADWAY THAT THE FIRE HYDRANT IS LOCATED ON, IN ACCORDANCE WITH OFC 510.1.
  - PROTECT FIRE HYDRANTS WITH APPROVED MEANS, IN ACCORDANCE WITH OFC 508.5.6.
  - A 3 FT CLEAR SPACE SHALL BE MAINTAINED AROUND THE CIRCUMFERENCE OF EACH FIRE HYDRANT, IN ACCORDANCE WITH OFC 508.5.5.
  - INDIVIDUAL FDC'S SHALL BE PROVIDED FOR EACH BUILDING THAT CONTAINS A SPRINKLER SYSTEM. ALL FDC'S WILL BE LOCATED AT THE FRONT OF EITHER THE EXISTING OPERATIONS BUILDING OR THE NEW ADMINISTRATION BUILDING. EACH SPRINKLED BUILDING WILL CONTAIN A SPRINKLER RISER, LOCATED NEAR THE PRIMARY ENTRANCE, IN ACCORDANCE WITH OFC 912.2.
  - IN ORDER TO PROVIDE CONTINUOUS FLOW OF FRESH POTABLE WATER FROM THE WTP DURING CONSTRUCTION, THE PROJECT WILL INVOLVE THE SEQUENTIAL DEMOLITION AND CONSTRUCTION OF EACH OF THE NEW PROPOSED FACILITIES. EACH ELEMENT OF DEMOLITION AND CONSTRUCTION HAS BEEN DESIGNED TO ENSURE APPROVED FIRE ACCESS ROADS AND WATER SUPPLIES CAN BE CONSISTENTLY MAINTAINED THROUGHOUT, IN COMPLIANCE WITH OFC 1410.1 AND 1412.1.
  - THE KNOX BOX WILL BE LOCATED NEAR THE FRONT DOOR OF EITHER THE EXISTING OPERATIONS BUILDING OR NEW ADMINISTRATION BUILDING. KNOX SWITCHES WILL BE INCORPORATED INTO EACH ELECTRICALLY ACTUATED ROLLING GATE, A "DAISY CHAIN" PAD LOCK WILL CONTROL ALL MANUAL GATES ON THE SITE, INCLUDING THE PROPOSED PIPE GATE AT MAPLETON DRIVE IN COMPLIANCE WITH OFC 506.
  - BUILDING NOMENCLATURE AND LETTERING WILL BE GENERATED IN ACCORDANCE WITH OFC 505.1. FOR EXAMPLE, BUILDINGS COULD BE SIGNED AS BUILDING A, BUILDING B, ETC. OR, THE APPLICANT COULD ERECT A BUILDING LOCATION MAP NEAR THE PRIMARY ENTRYWAY INTO THE OPERATIONS BUILDING. THE APPLICANT WILL WORK IN COLLABORATION WITH TVFR AND THE CITY OF WEST LINN TO CREATE AND INSTALL BUILDING ORIENTATION LABELING THAT BOTH MEETS TVFR REQUIREMENTS AS WELL AS WEST LINN LAND USE STANDARDS.
  - WITHIN BUILDING INTERIOR, FIRE PROTECTION EQUIPMENT SHALL BE INSTALLED CONSISTENT WITH OFC 510.1.
  - TVFR REQUESTS THAT THE APPLICANT PROVIDE A COMPLETED HMIS FOR REVIEW AND TENTATIVE APPROVAL AT THE TIME OF LAND USE APPLICATION. AS A CONDITION OF LAND USE APPROVAL, TVFR REQUESTS THAT THE APPLICANT PREPARE A HMMP, IF NECESSARY, DURING THE DESIGN PROCESS. TVFR REQUESTS THAT THE APPLICANT ENGAGE TVFR IN ONE OR MORE PARTNERING MEETINGS TO REVIEW THE TYPE, AMOUNT, LOCATION, STORAGE, CONTAINMENT AND TRANSPORT OF HAZARDOUS MATERIALS SO THAT THE SITE MAY BE DESIGNED TO BE AS SAFE AS IS REASONABLY PRACTICAL.
  - THE APPLICANT WILL PROVIDE TVFR WITH A FULL SET OF PRELIMINARY PLANS FOR REVIEW AND COMMENT DURING THE LAND USE APPLICATION PROCESS AND WILL PROVIDE THE TVFR WITH MORE DETAILED DESIGN DRAWINGS AND PLANS DURING THE SUBSEQUENT DESIGN PROCESS.

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LINE IS 2 INCHES  
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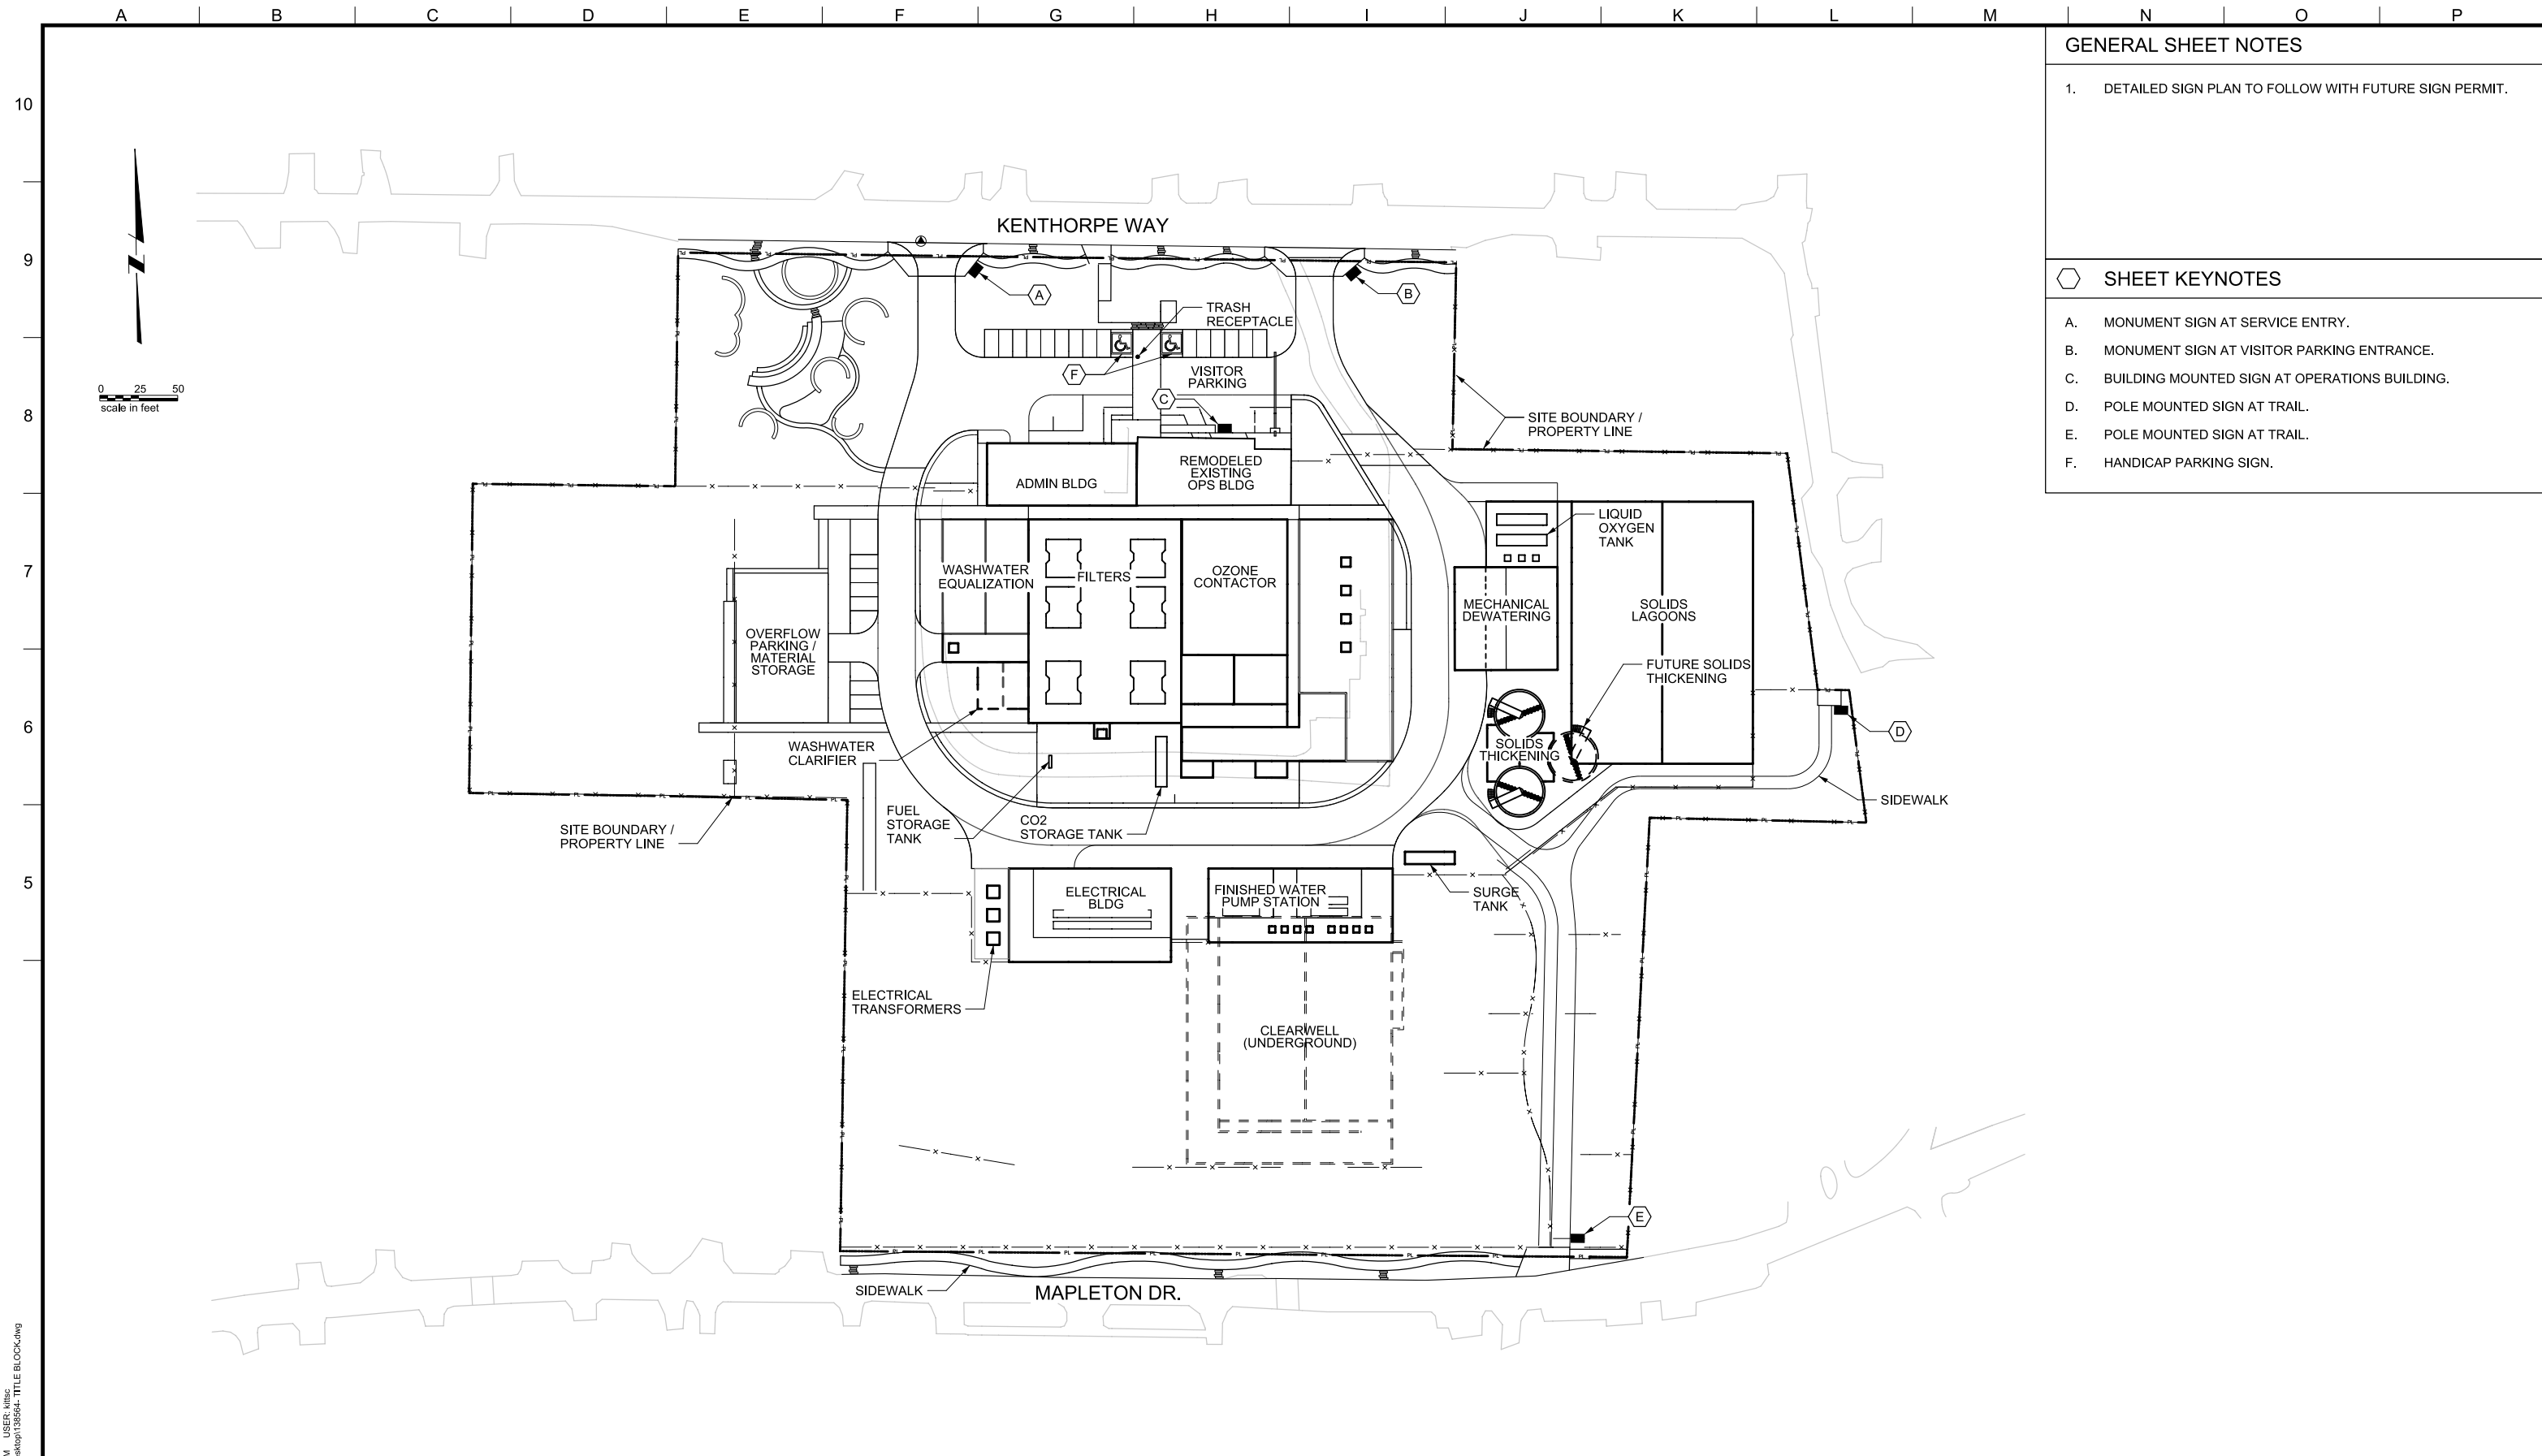
**OWNER:**  
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 LAKE OSWEGO, OR 97034  
 PHONE: 503-635-0270



LAKE OSWEGO AND TIGARD WATER TREATMENT PLANT  
 DESIGN REVIEW AND CONDITIONAL USE  
**FIRE AND EMERGENCY ACCESS PLAN**

FILENAME	
PROJECT NUMBER	
SCALE	1" = 50'
DRAWING/FIGURE NUMBER	7.1
#### OF	





**GENERAL SHEET NOTES**

1. DETAILED SIGN PLAN TO FOLLOW WITH FUTURE SIGN PERMIT.

**SHEET KEYNOTES**

- A. MONUMENT SIGN AT SERVICE ENTRY.
- B. MONUMENT SIGN AT VISITOR PARKING ENTRANCE.
- C. BUILDING MOUNTED SIGN AT OPERATIONS BUILDING.
- D. POLE MOUNTED SIGN AT TRAIL.
- E. POLE MOUNTED SIGN AT TRAIL.
- F. HANDICAP PARKING SIGN.

PLOT DATE: September 10, 2008 - 1:55PM USER: Mtlisc  
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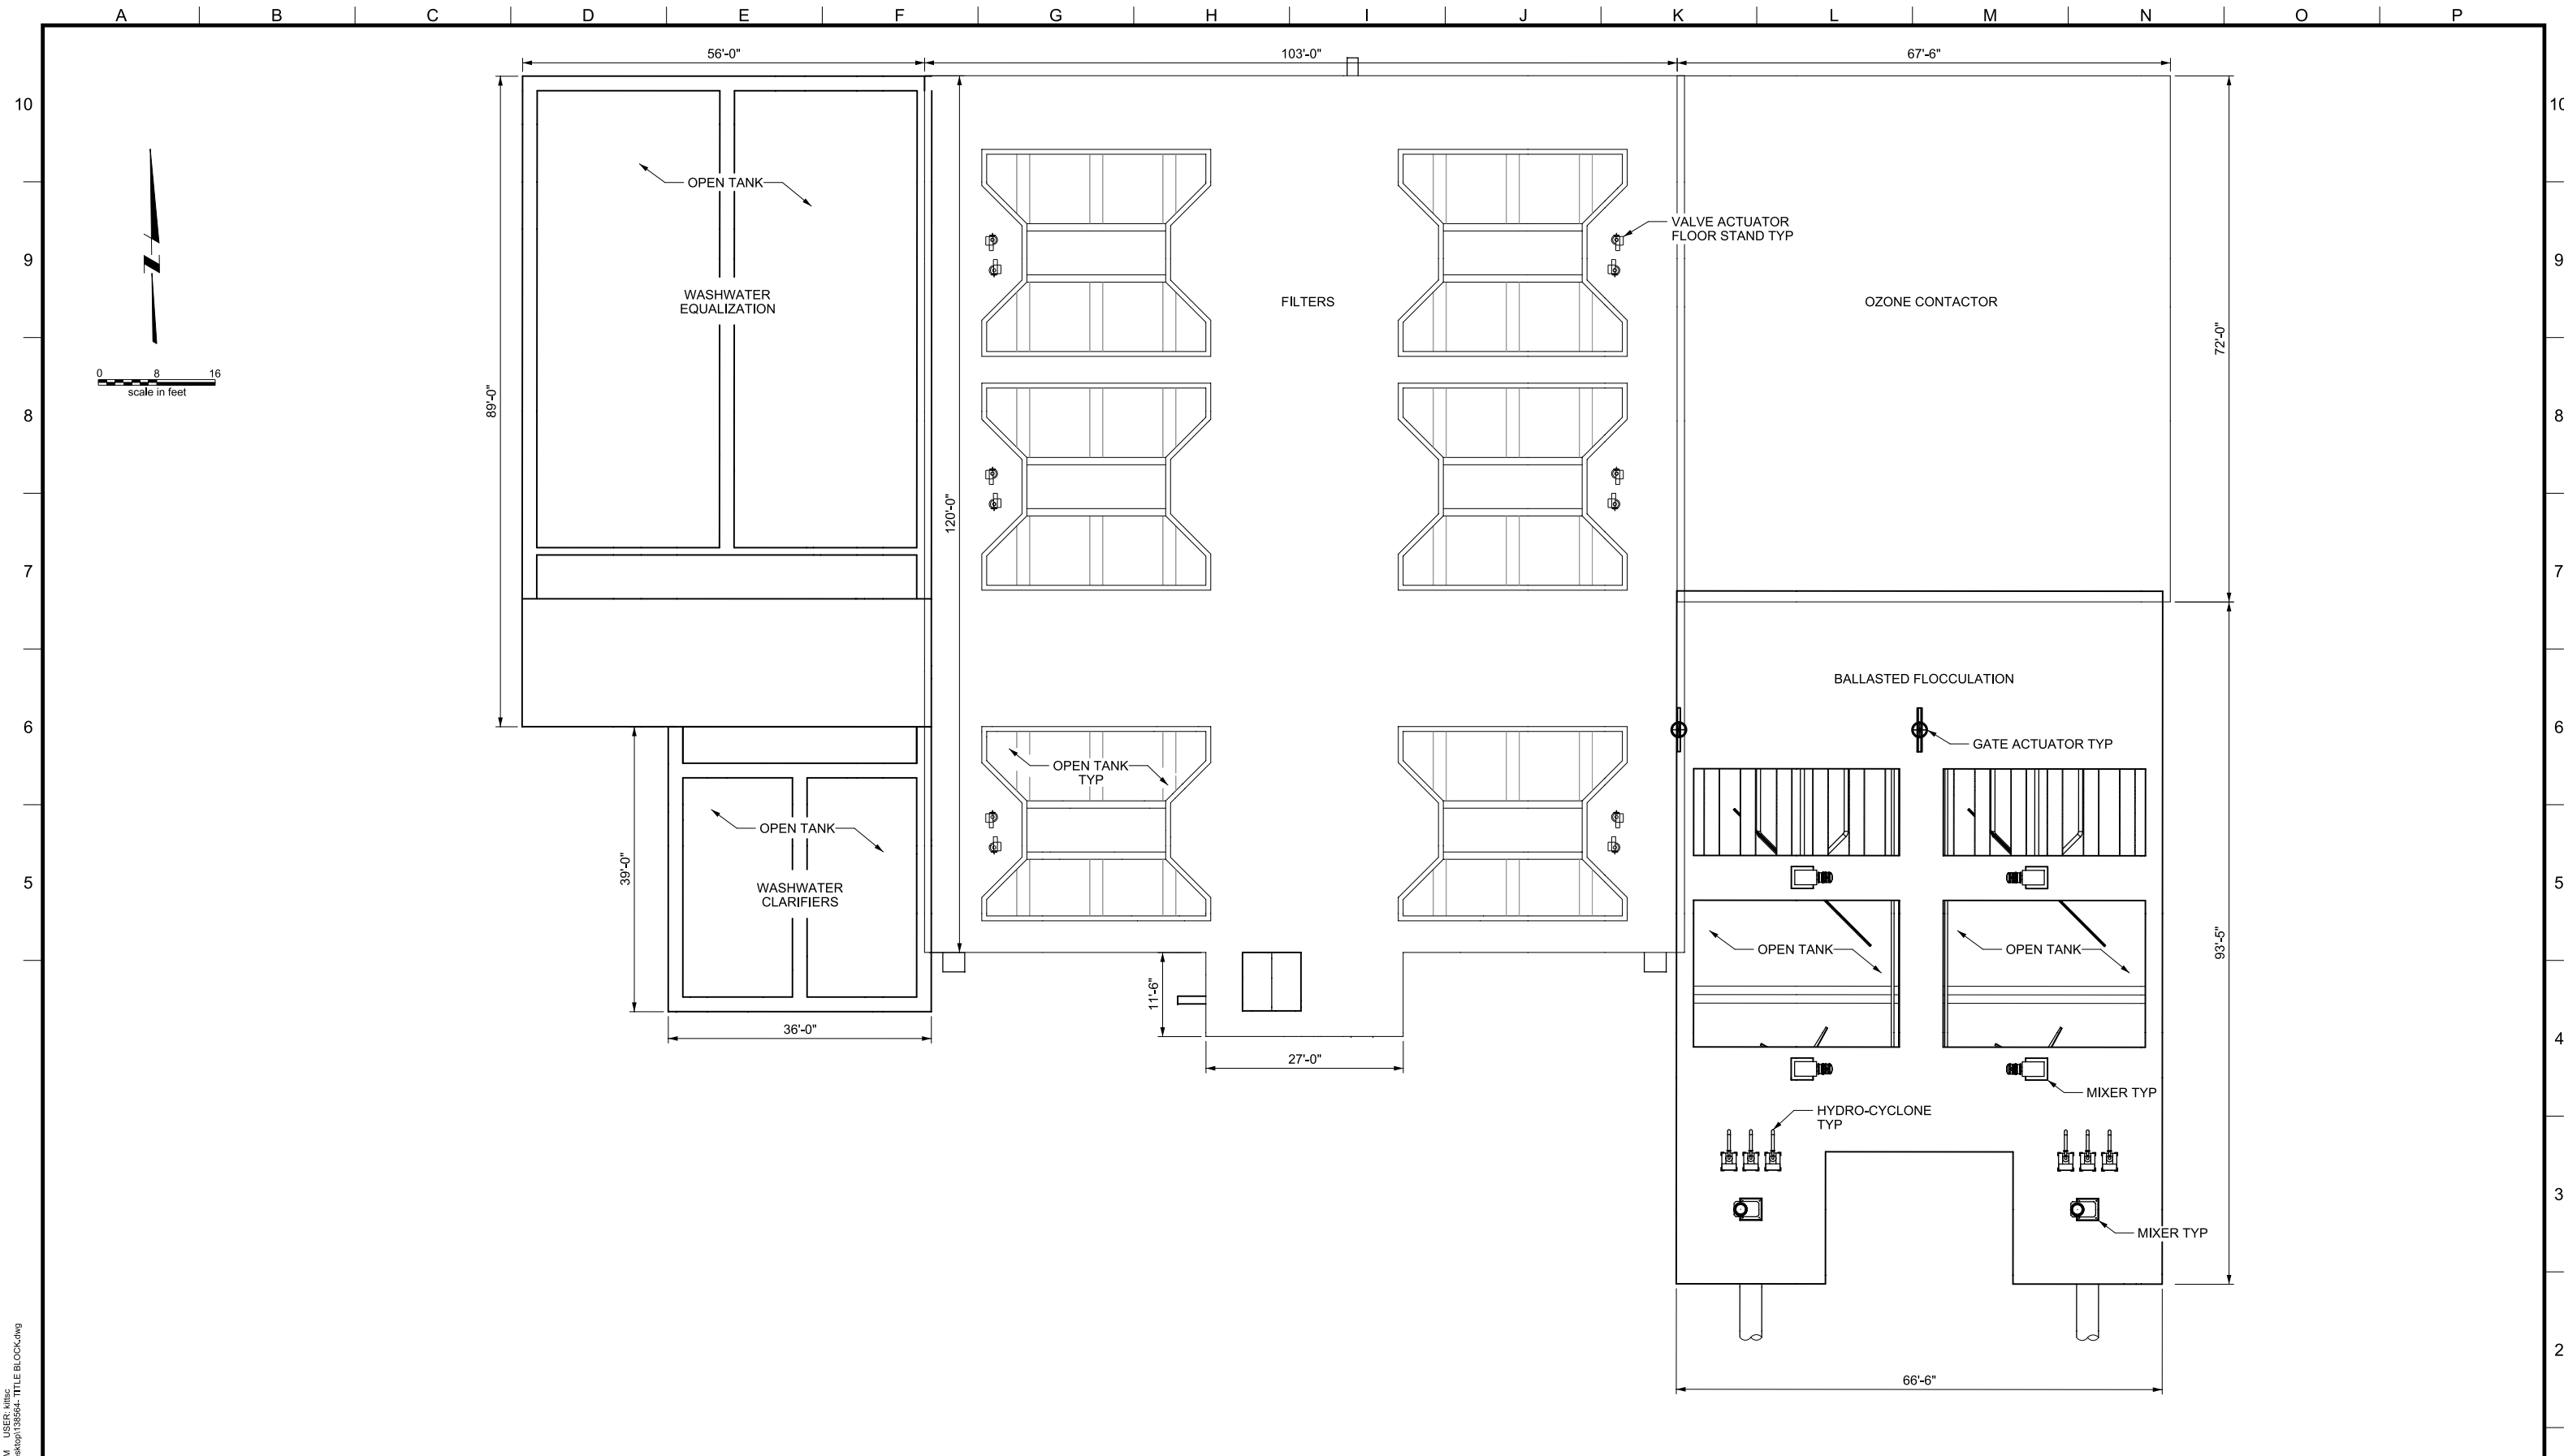
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REV.	DESCRIPTION	BY	DATE	APP.

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LAKE OSWEGO AND TIGARD WATER TREATMENT PLANT  
 DESIGN REVIEW AND CONDITIONAL USE  
**PRELIMINARY SIGN LOCATION PLAN**

FILENAME	
PROJECT NUMBER	
SCALE	1" = 50'
DRAWING/FIGURE NUMBER	8.0
### OF	



PLOT DATE: September 10, 2008 - 1:55PM USER: mltbc FILE: C:\Documents and Settings\mltbc\Desktop\138594\_TITLE\_BLOCK.dwg



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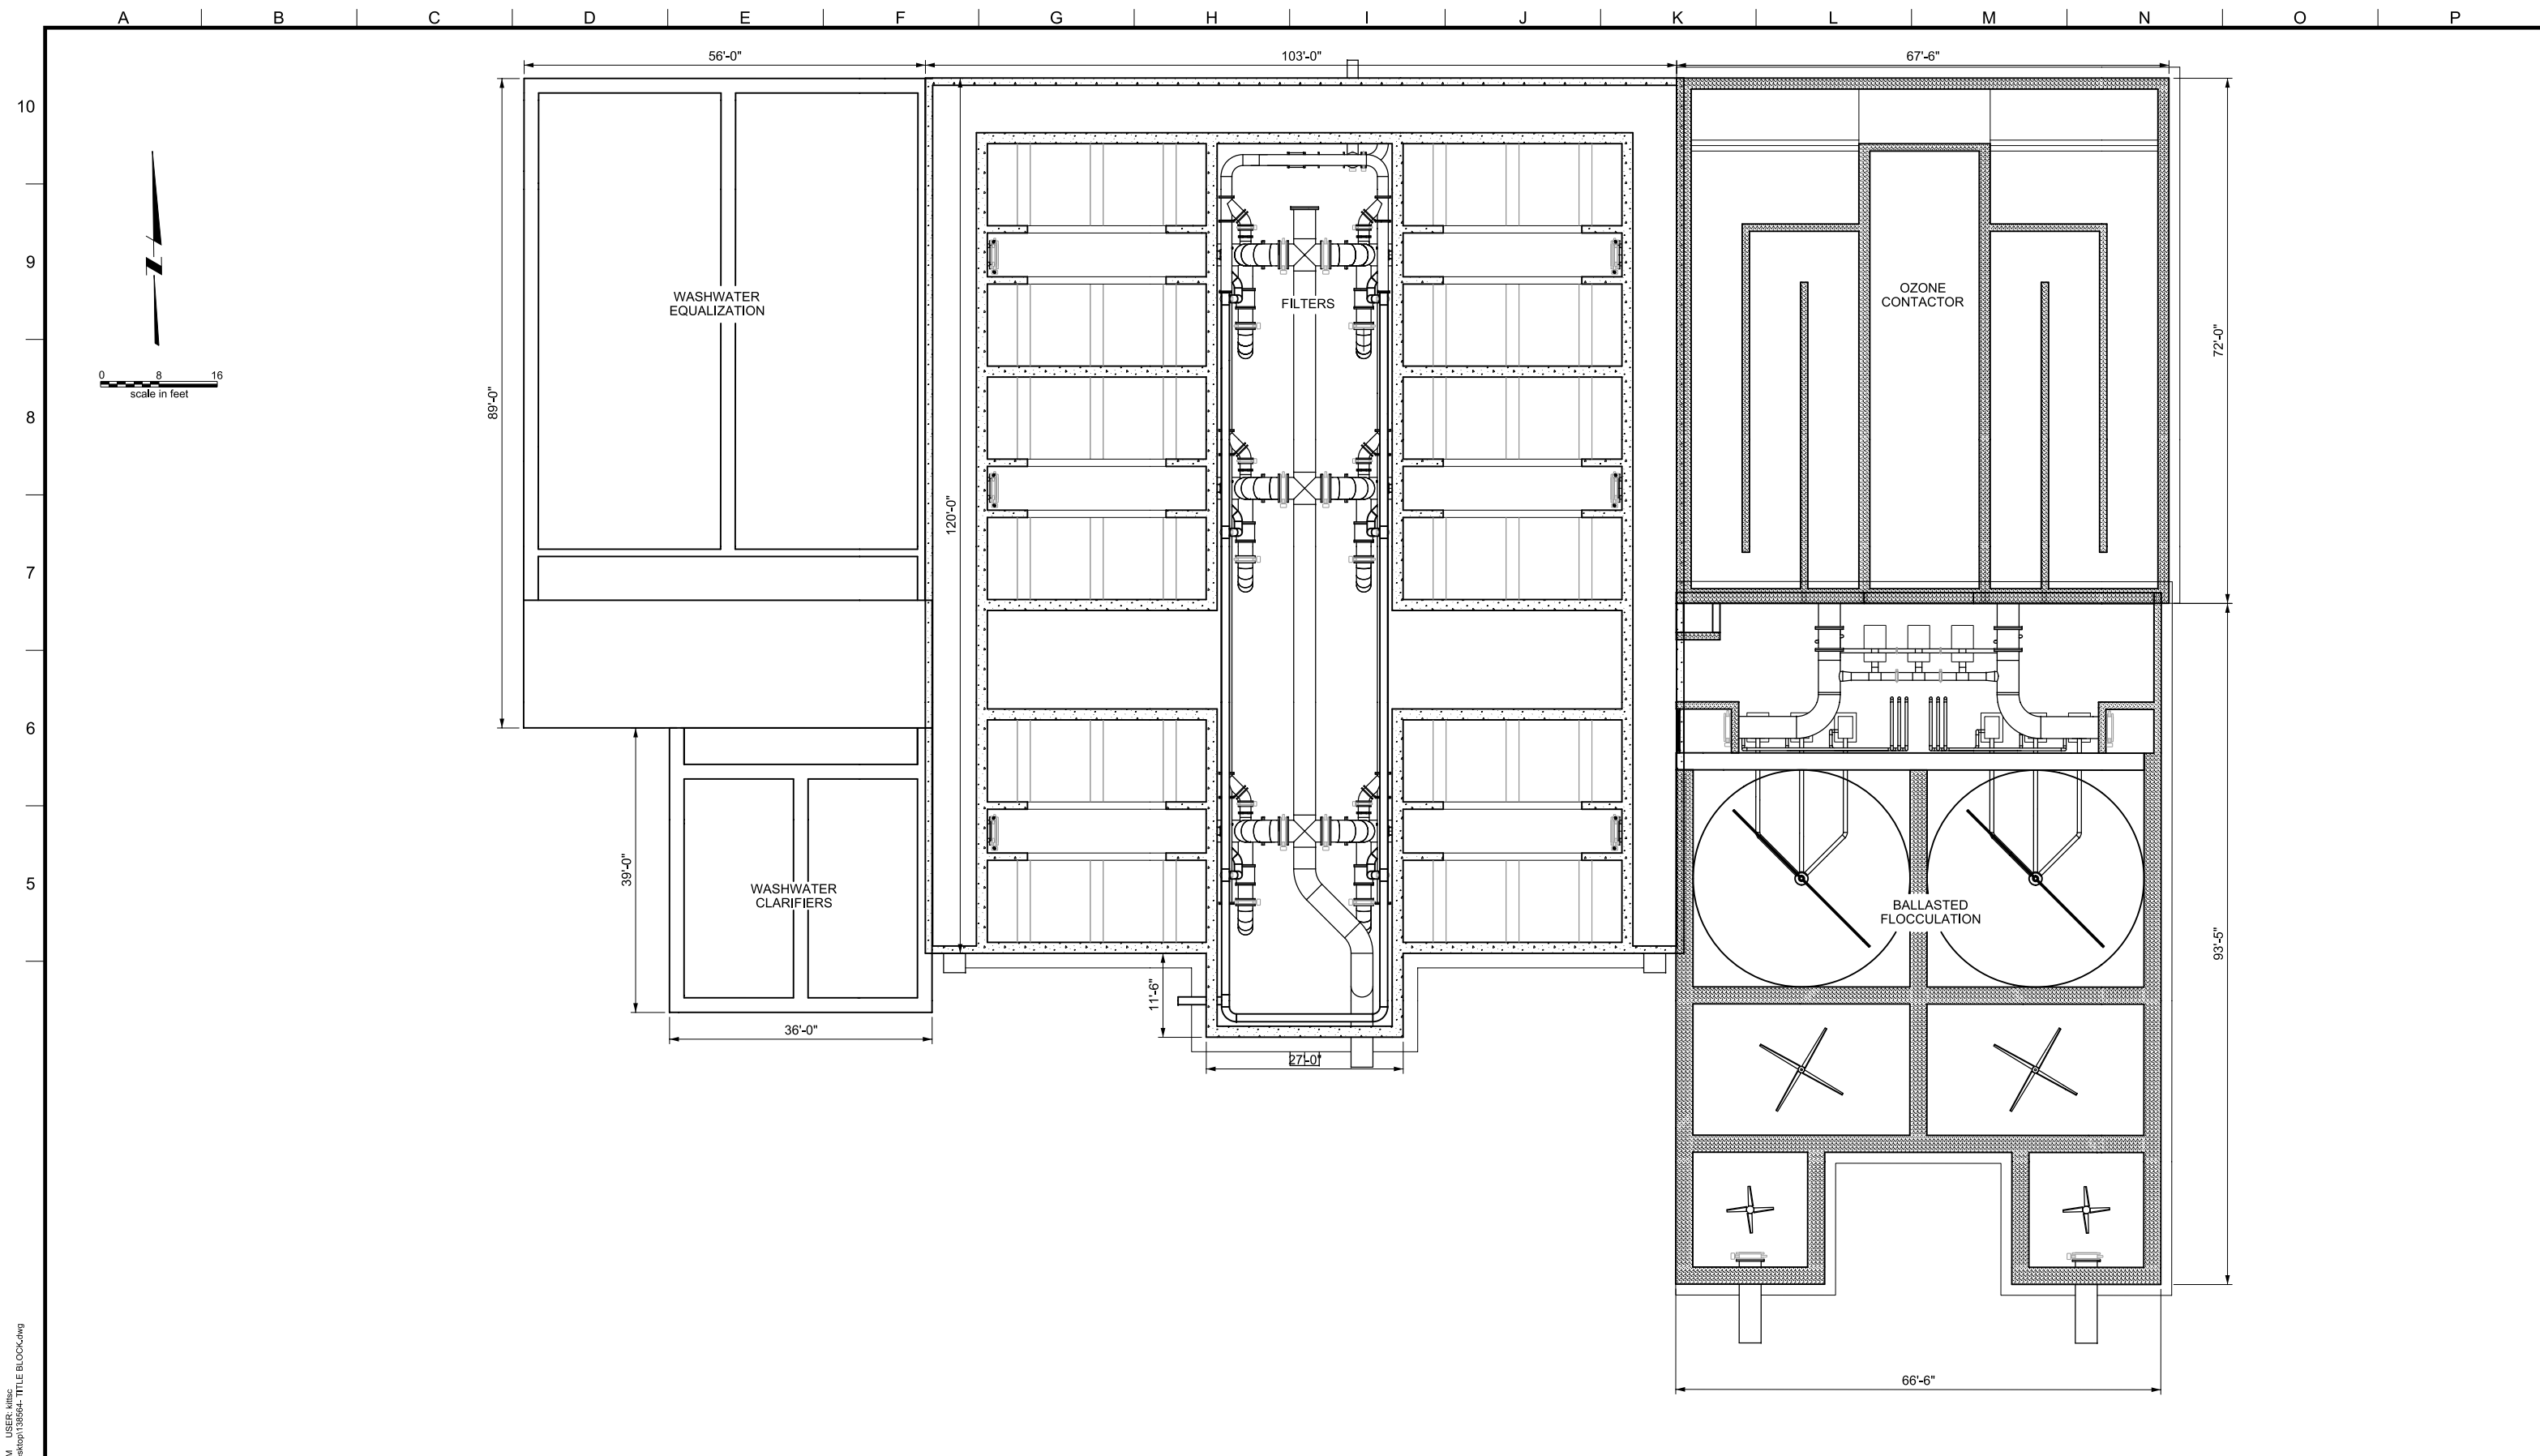
REVISIONS				
REV.	DESCRIPTION	BY	DATE	APP.

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LAKE OSWEGO AND TIGARD WATER TREATMENT PLANT  
 DESIGN REVIEW AND CONDITIONAL USE  
**PROCESS AREAS  
 TOP PLAN**

FILENAME	
PROJECT NUMBER	
SCALE	3/32" = 1'
DRAWING/FIGURE NUMBER	9.0
### OF	



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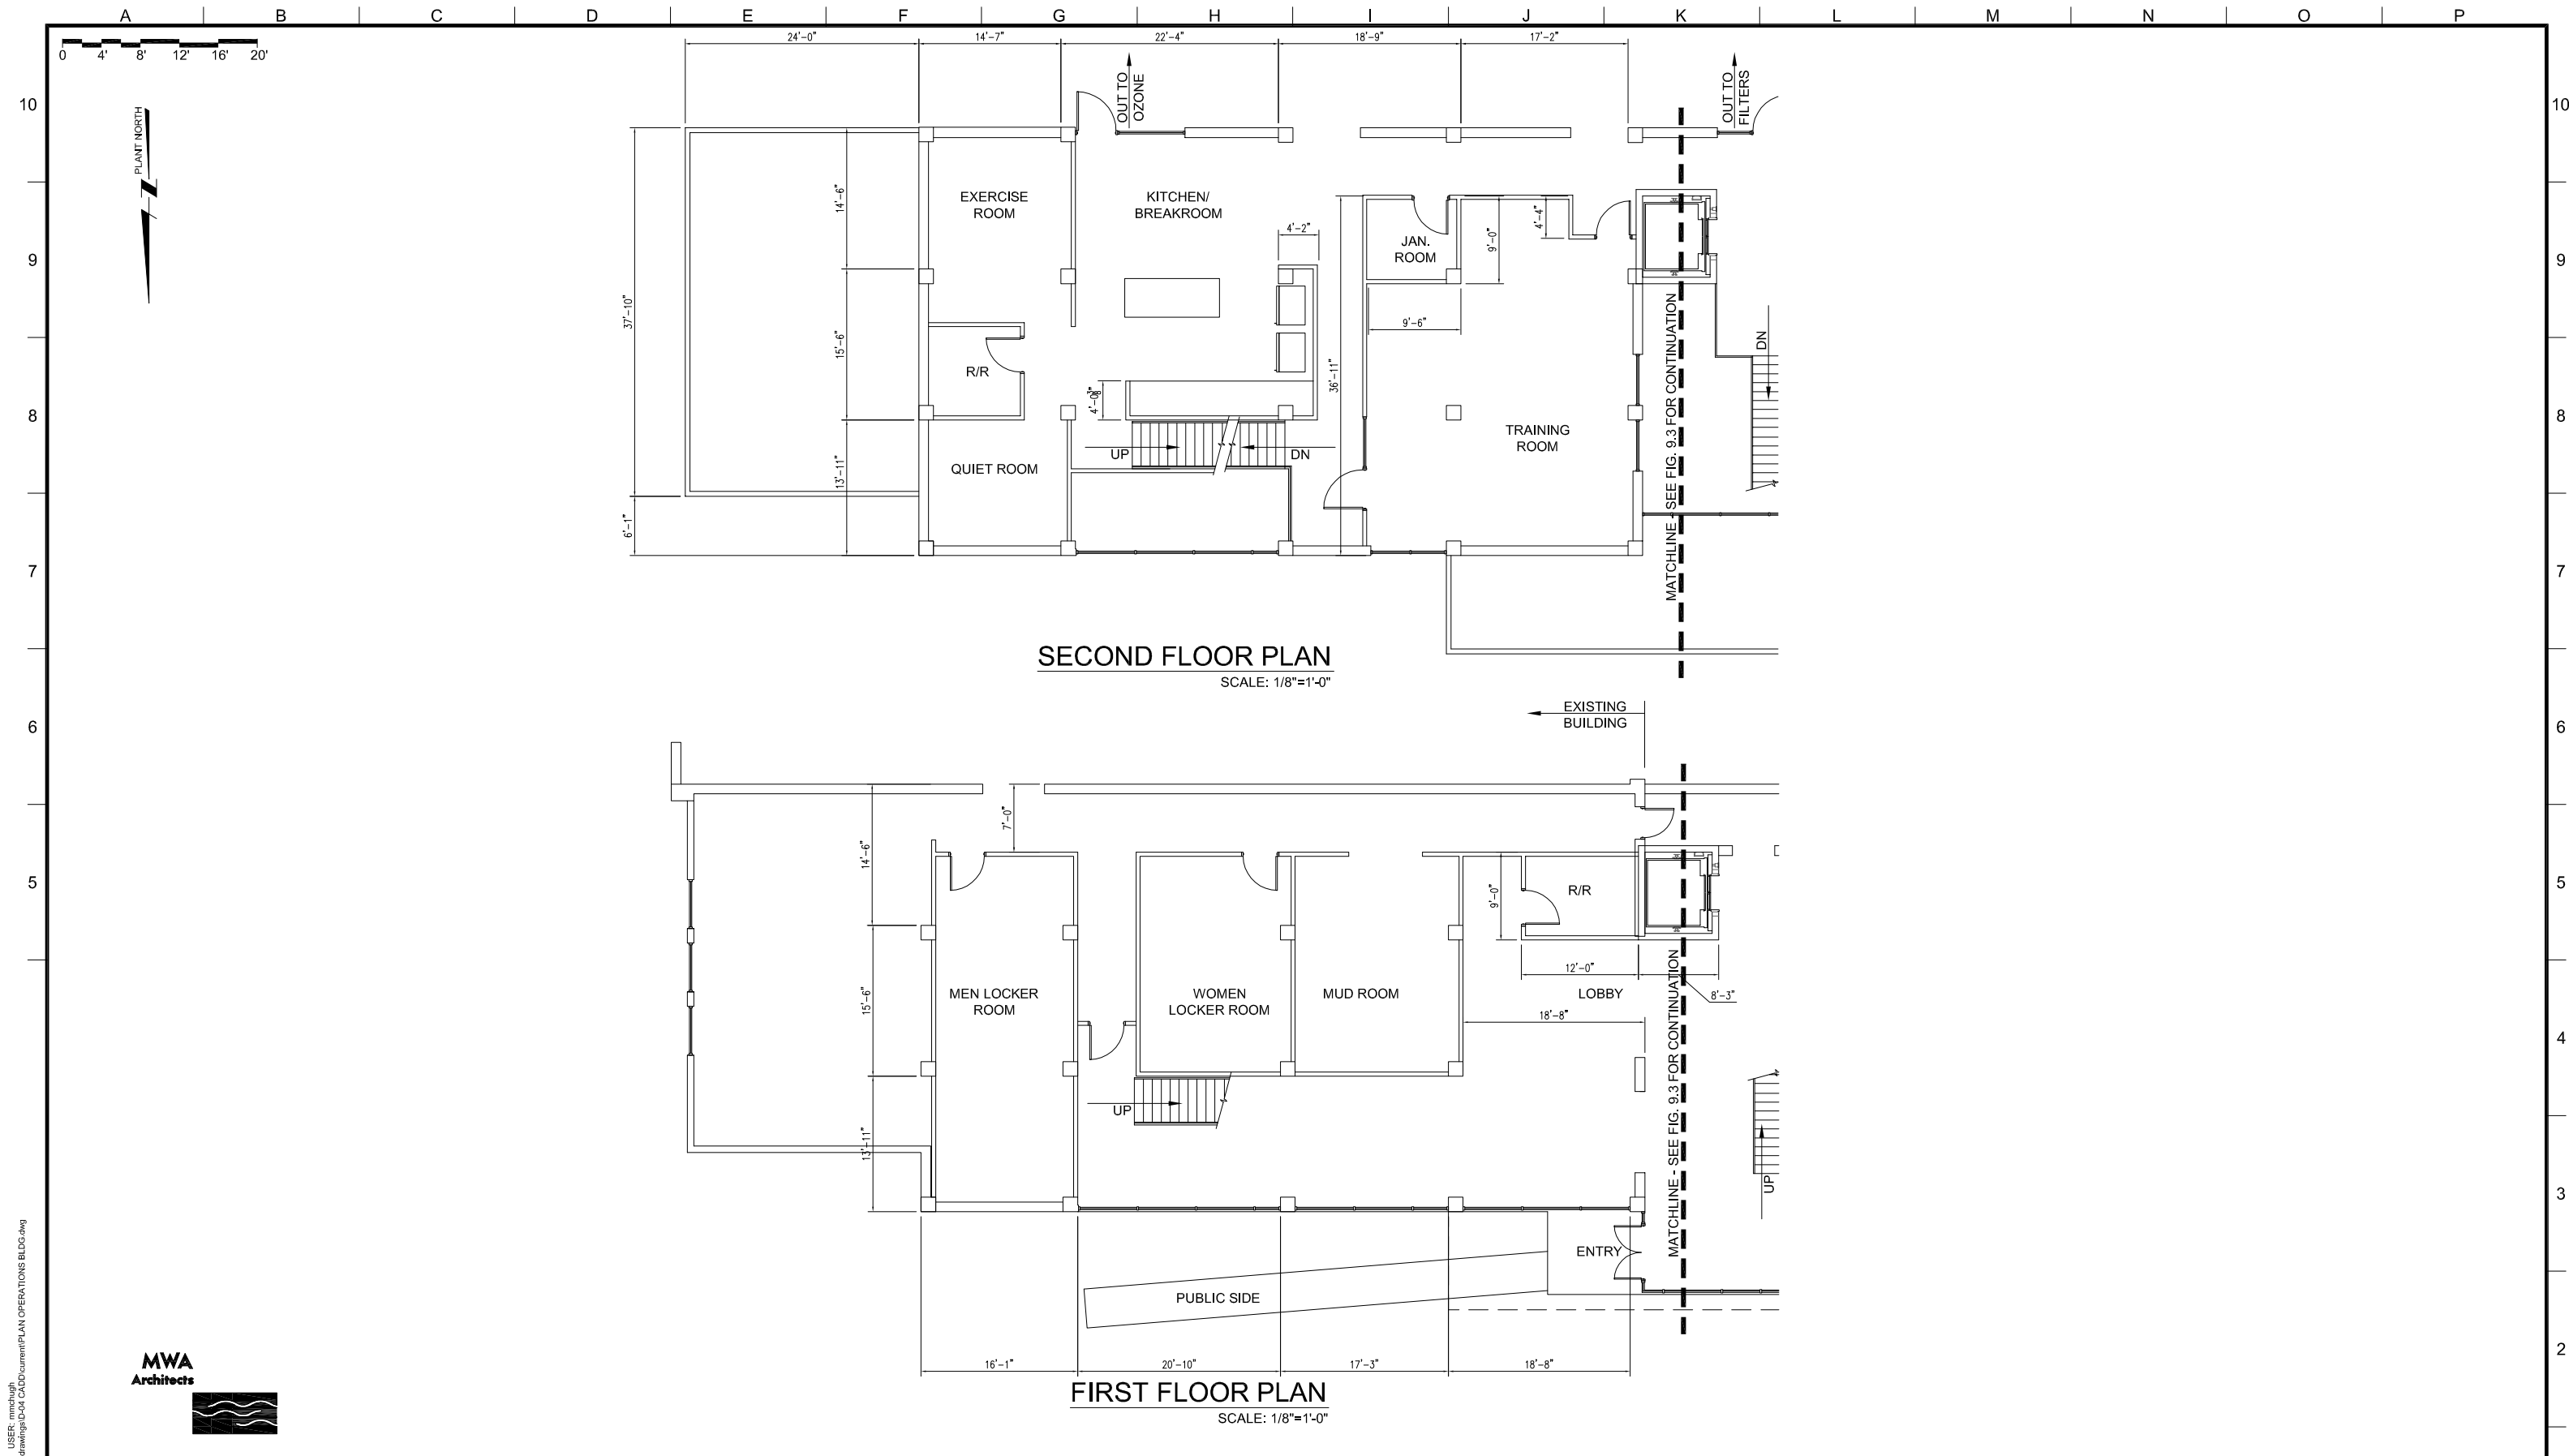
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REV.	DESCRIPTION	BY	DATE	APP.

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 PHONE: 503-635-0270



LAKE OSWEGO AND TIGARD WATER TREATMENT PLANT  
 DESIGN REVIEW AND CONDITIONAL USE  
**PROCESS AREAS  
 BOTTOM PLAN**

FILENAME	
PROJECT NUMBER	
SCALE	3/32" = 1'
DRAWING/FIGURE NUMBER	9.1
### OF	



PLOT DATE: January 13, 2012 - 9:19AM  
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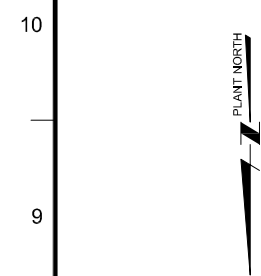
LAKE OSWEGO AND TIGARD WATER TREATMENT PLANT  
 DESIGN REVIEW AND CONDITIONAL USE  
 ARCHITECTURAL FLOOR PLANS  
 OPERATIONS

FILENAME	
PROJECT NUMBER	
SCALE AS SHOWN	
DRAWING/FIGURE NUMBER	9.2
OF	

A B C D E F G H I J K L M N O P

A B C D E F G H I J K L M N O P

0 4' 8' 12' 16' 20'



10

9

8

7

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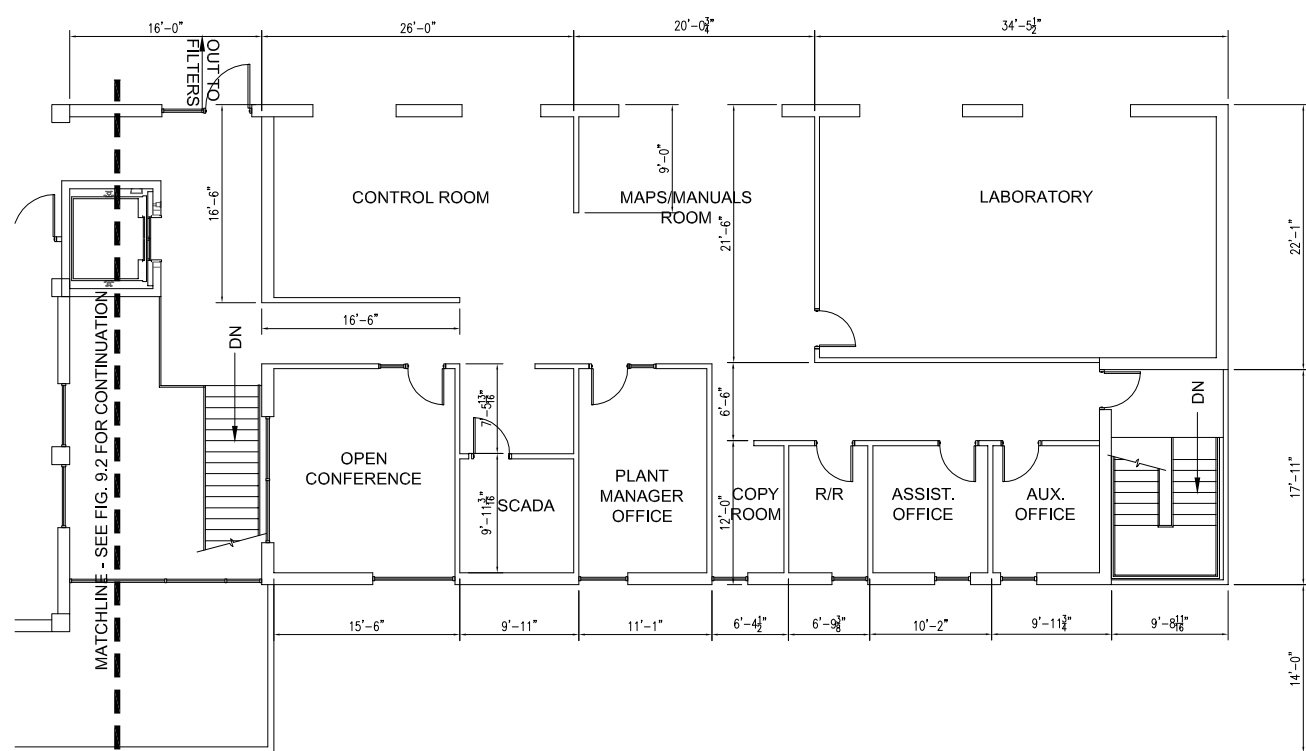
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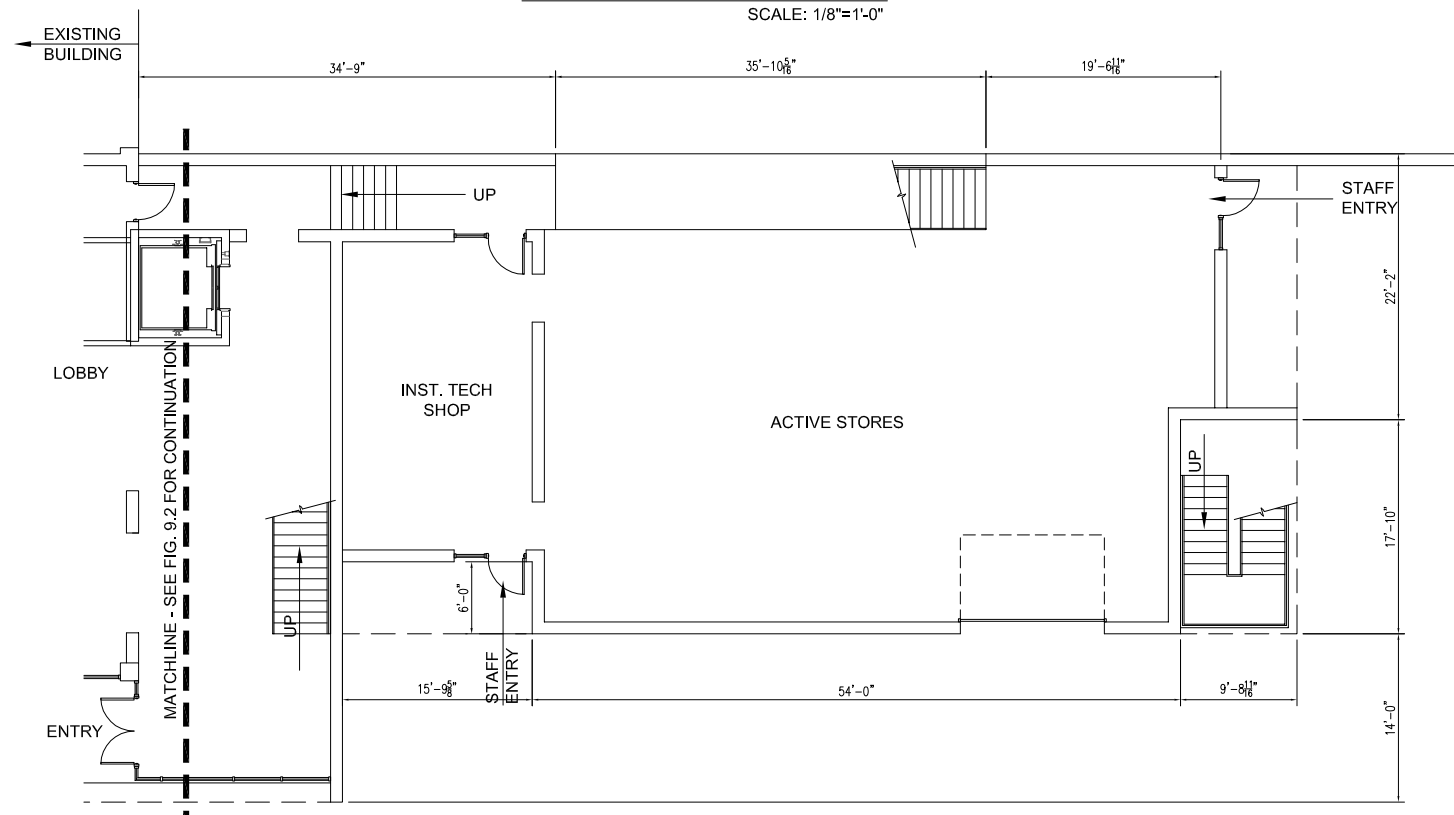
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A B C D E F G H I J K L M N O P



**SECOND FLOOR PLAN**

SCALE: 1/8"=1'-0"



**FIRST FLOOR PLAN**

SCALE: 1/8"=1'-0"



LINE IS 2 INCHES AT FULL SIZE (IF NOT 2" - SCALE ACCORDINGLY)

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REV.	DESCRIPTION	BY	APP.	

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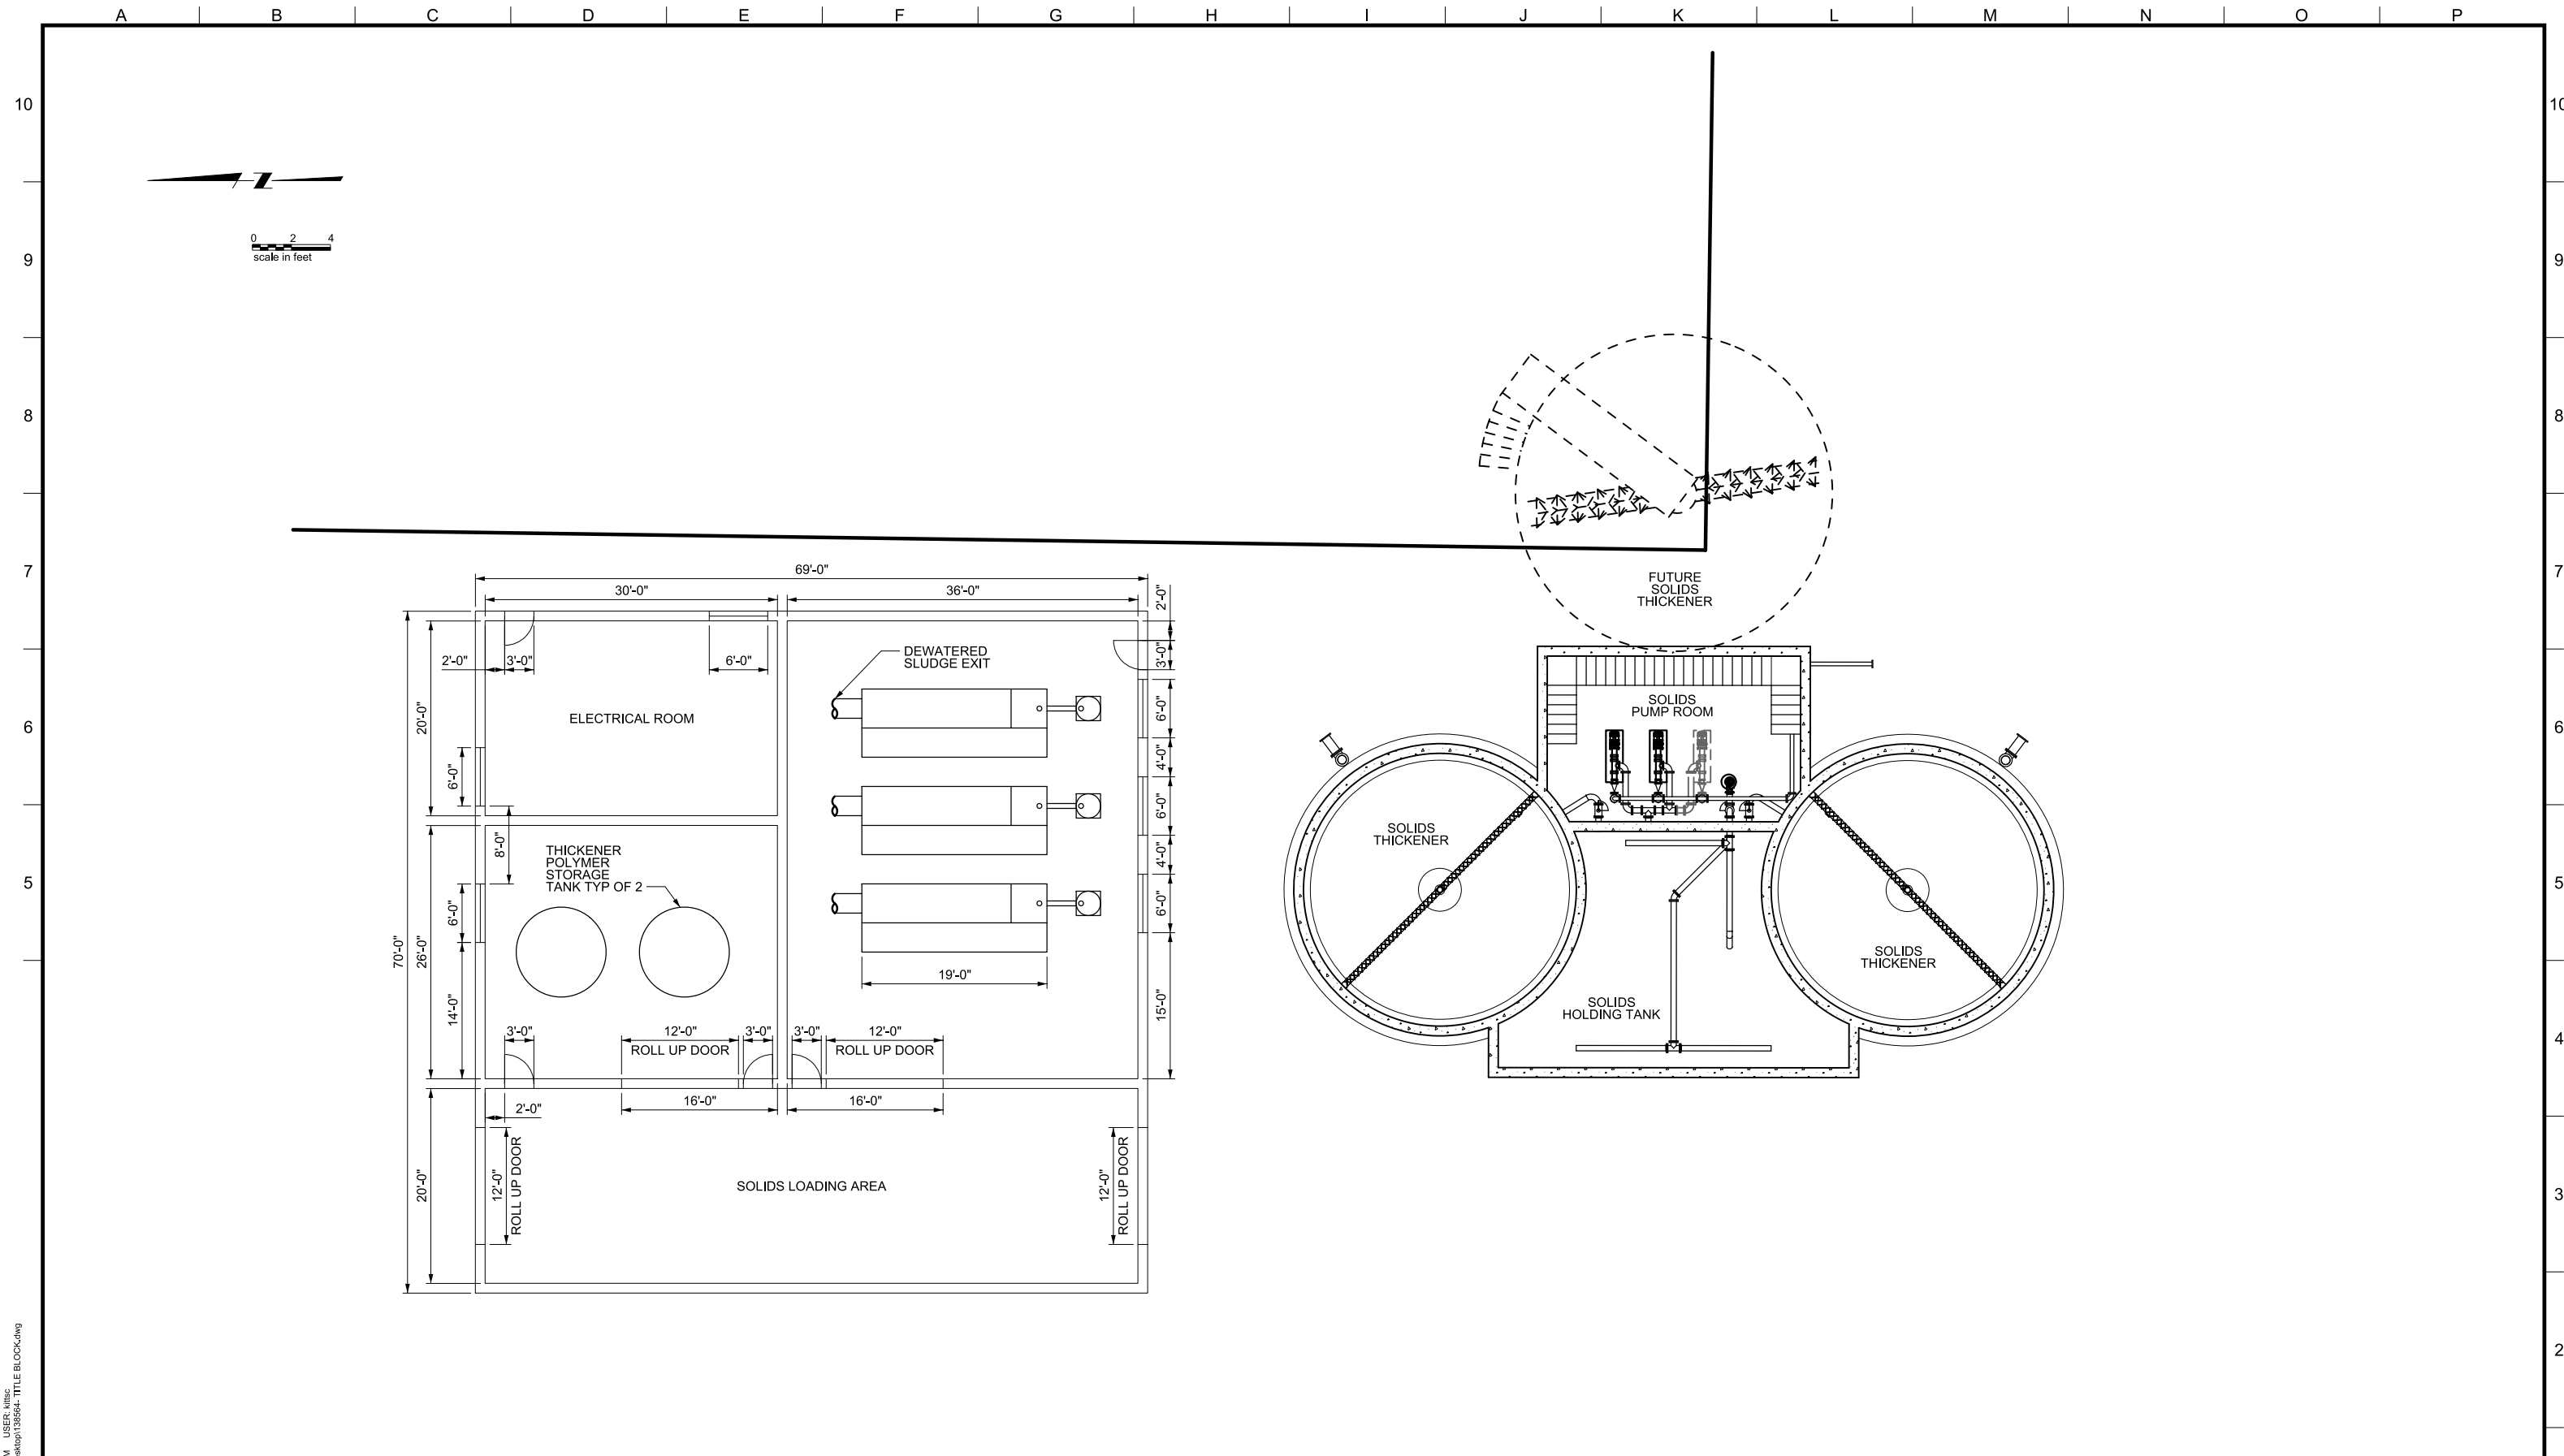


LAKE OSWEGO AND TIGARD WATER TREATMENT PLANT

DESIGN REVIEW AND CONDITIONAL USE  
 ARCHITECTURAL FLOOR PLANS  
 ADMIN

FILENAME	
PROJECT NUMBER	
SCALE	AS SHOWN
DRAWING/FIGURE NUMBER	9.3
OF	

PLOT DATE: January 13, 2012 - 9:20AM USER: nmchugh  
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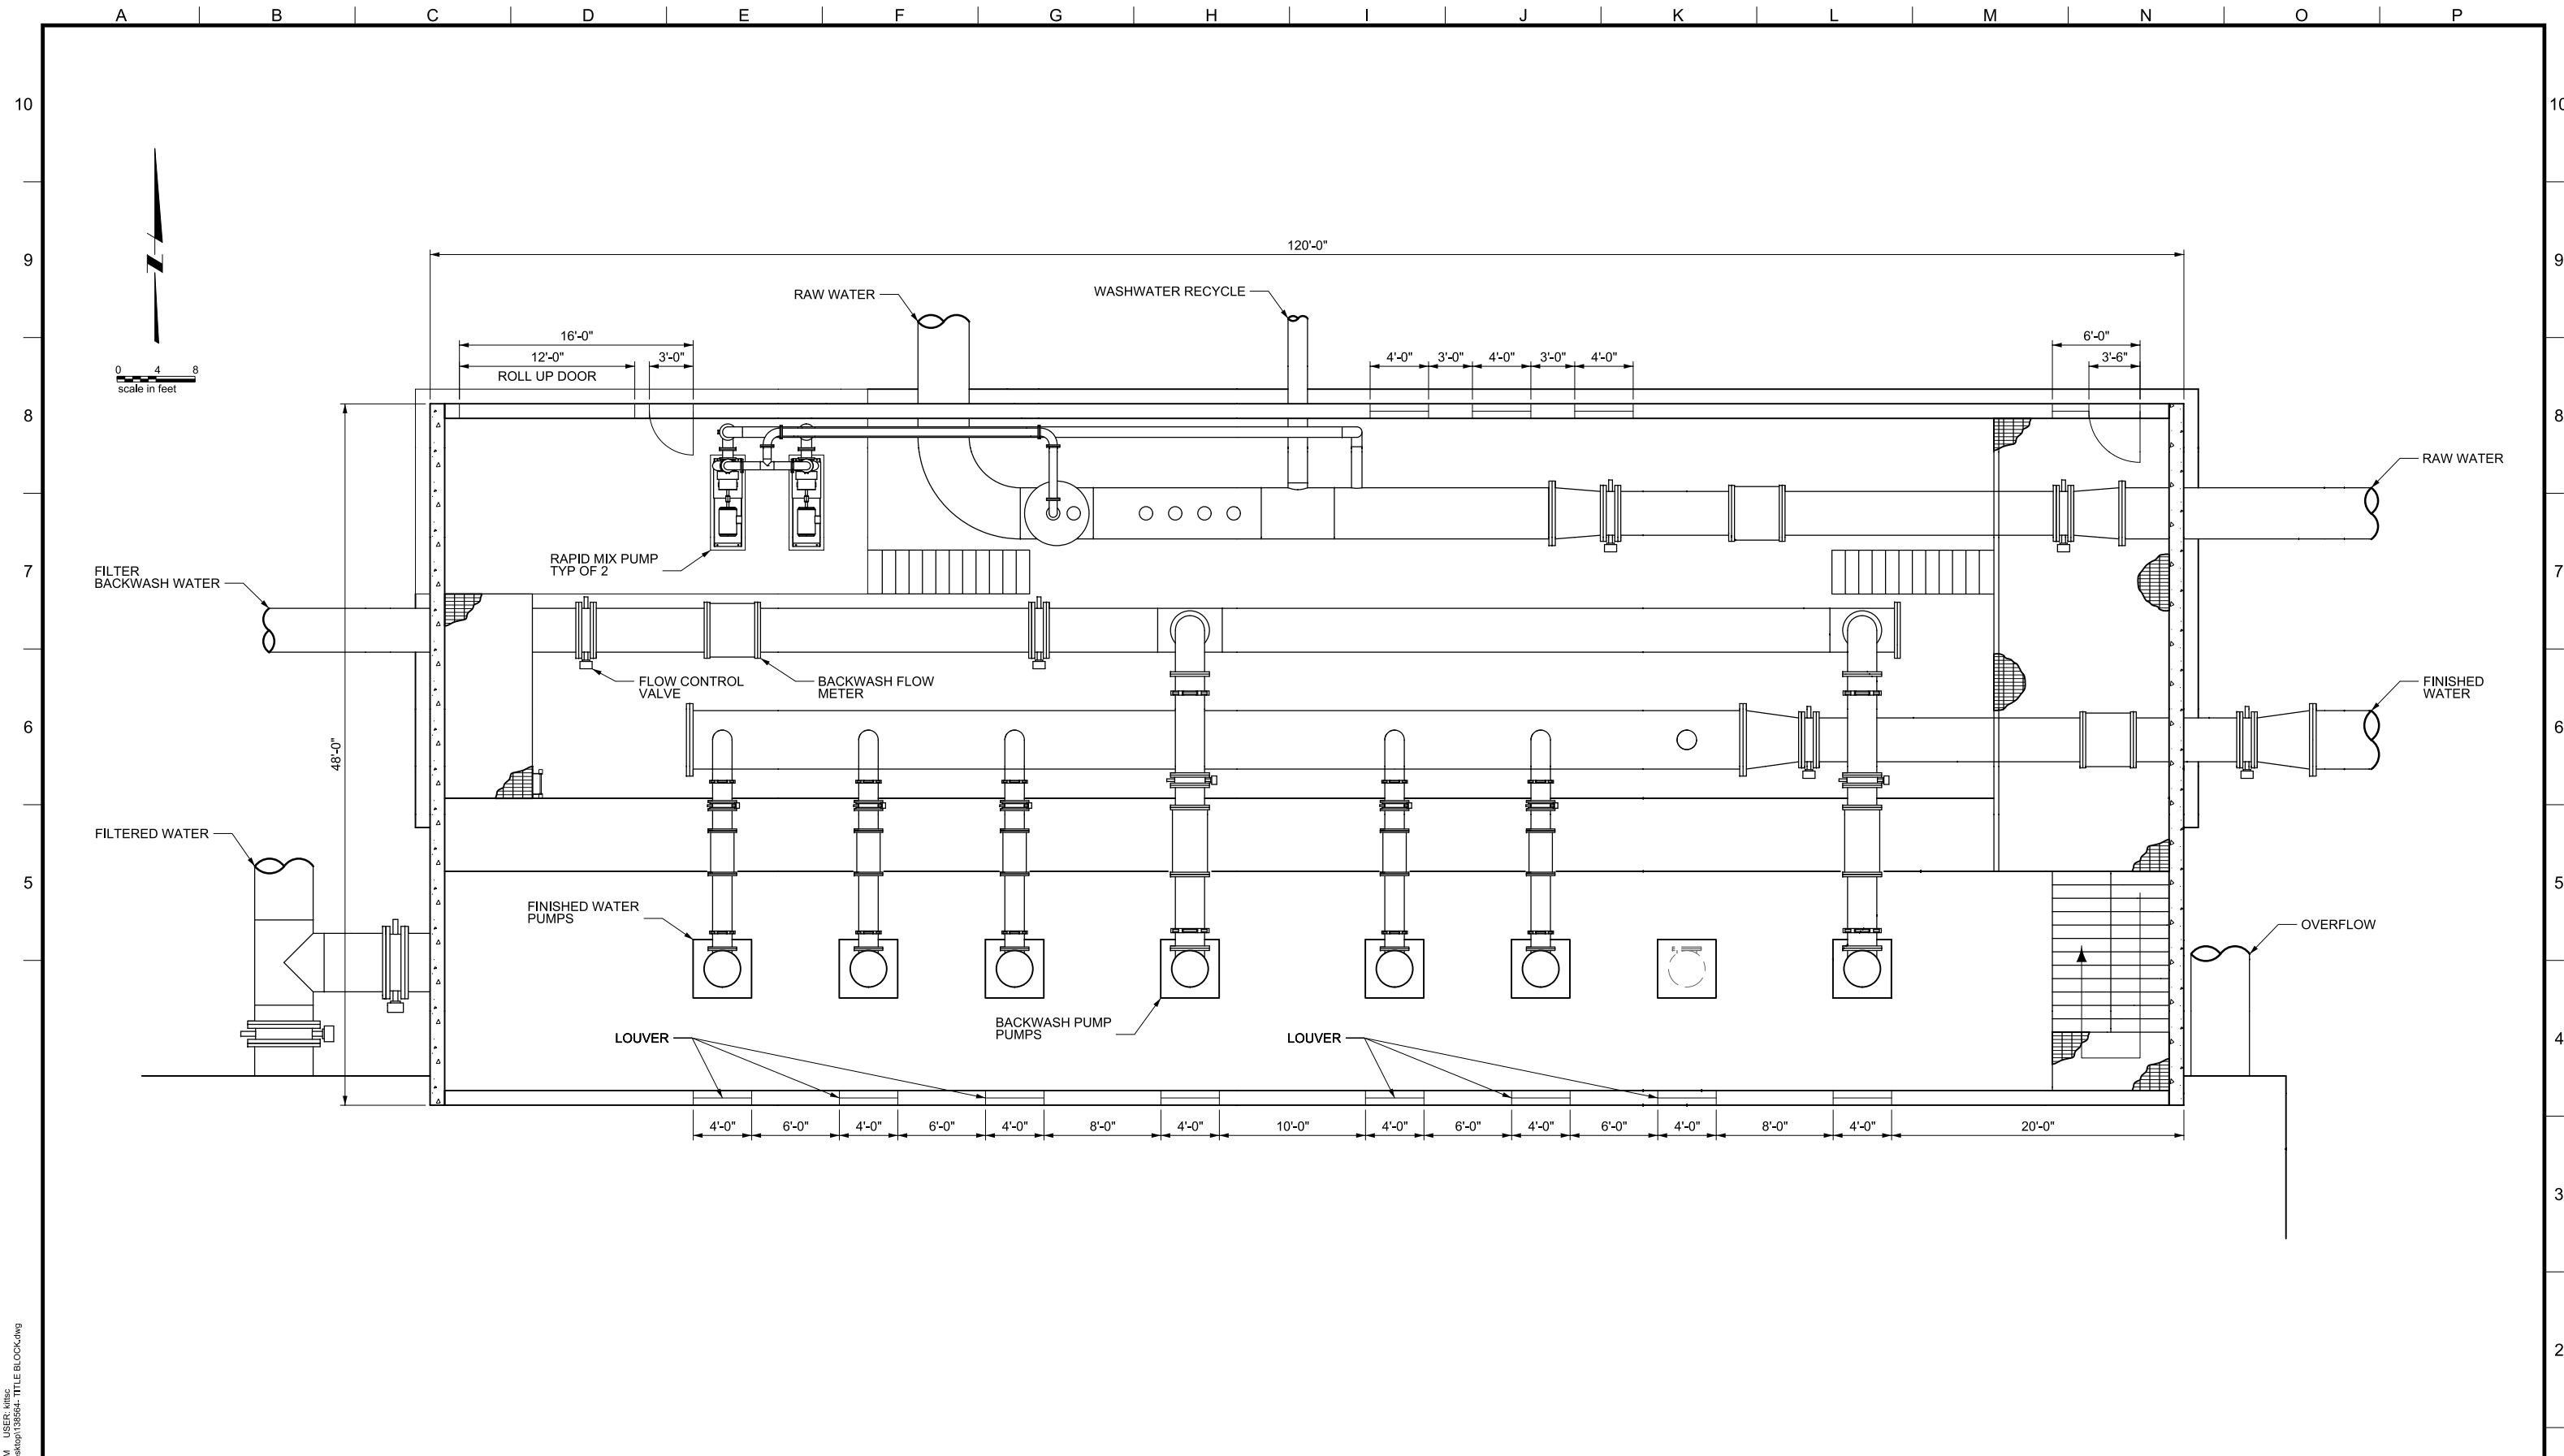
**OWNER:**  
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LAKE OSWEGO AND TIGARD WATER TREATMENT PLANT  
 DESIGN REVIEW AND CONDITIONAL USE  
**ARCHITECTUAL FLOOR PLAN**  
**DEWATERING AND**  
**SOLIDS THICKENING**

FILENAME	
PROJECT NUMBER	
SCALE	1/4" = 1'
DRAWING/FIGURE NUMBER	<b>9.4</b>
### OF	

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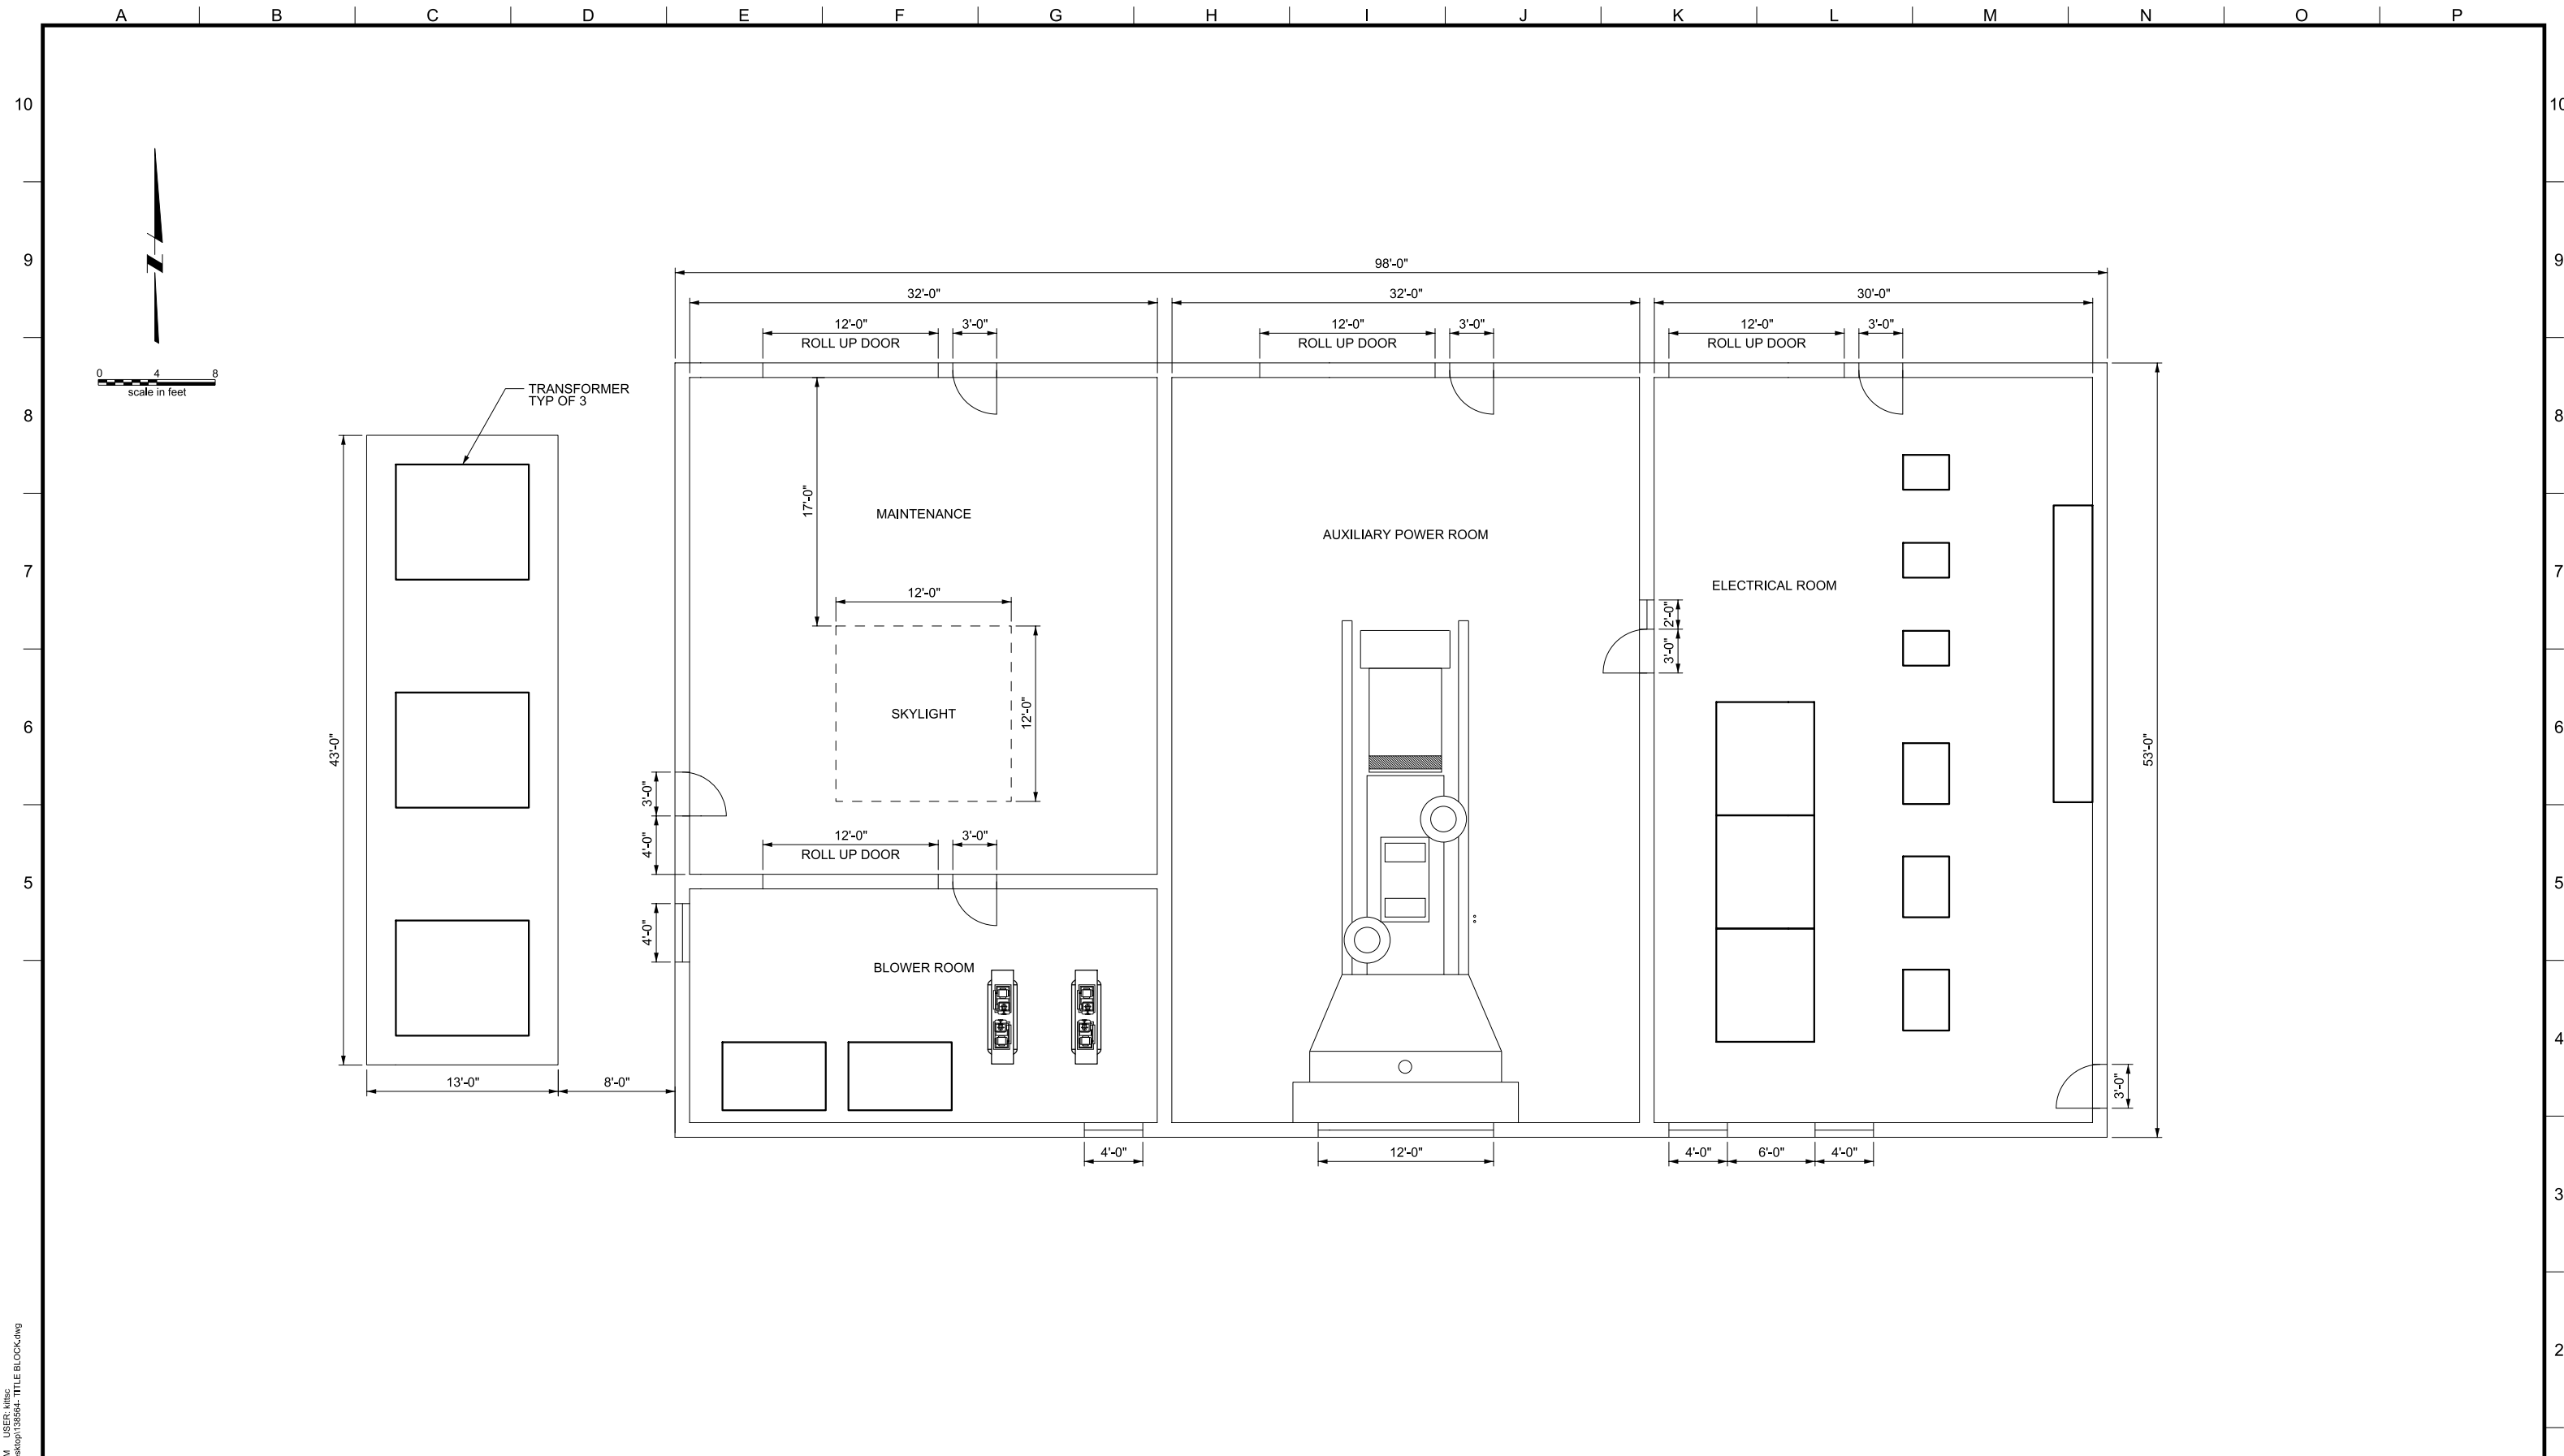
OWNER:  
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PHONE: 503-635-0270



LAKE OSWEGO AND TIGARD WATER TREATMENT PLANT  
DESIGN REVIEW AND CONDITIONAL USE  
ARCHITECTURAL FLOOR PLAN  
FINISHED WATER PUMP STATION

FILENAME	
PROJECT NUMBER	
SCALE	1/8" = 1'
DRAWING/FIGURE NUMBER	9.5
### OF	

PLOT DATE: September 10, 2008 - 1:55PM USER: Mtlisc FILE: C:\Documents and Settings\Mtlisc\Desktop\138564\_TITL BLOCK.dwg



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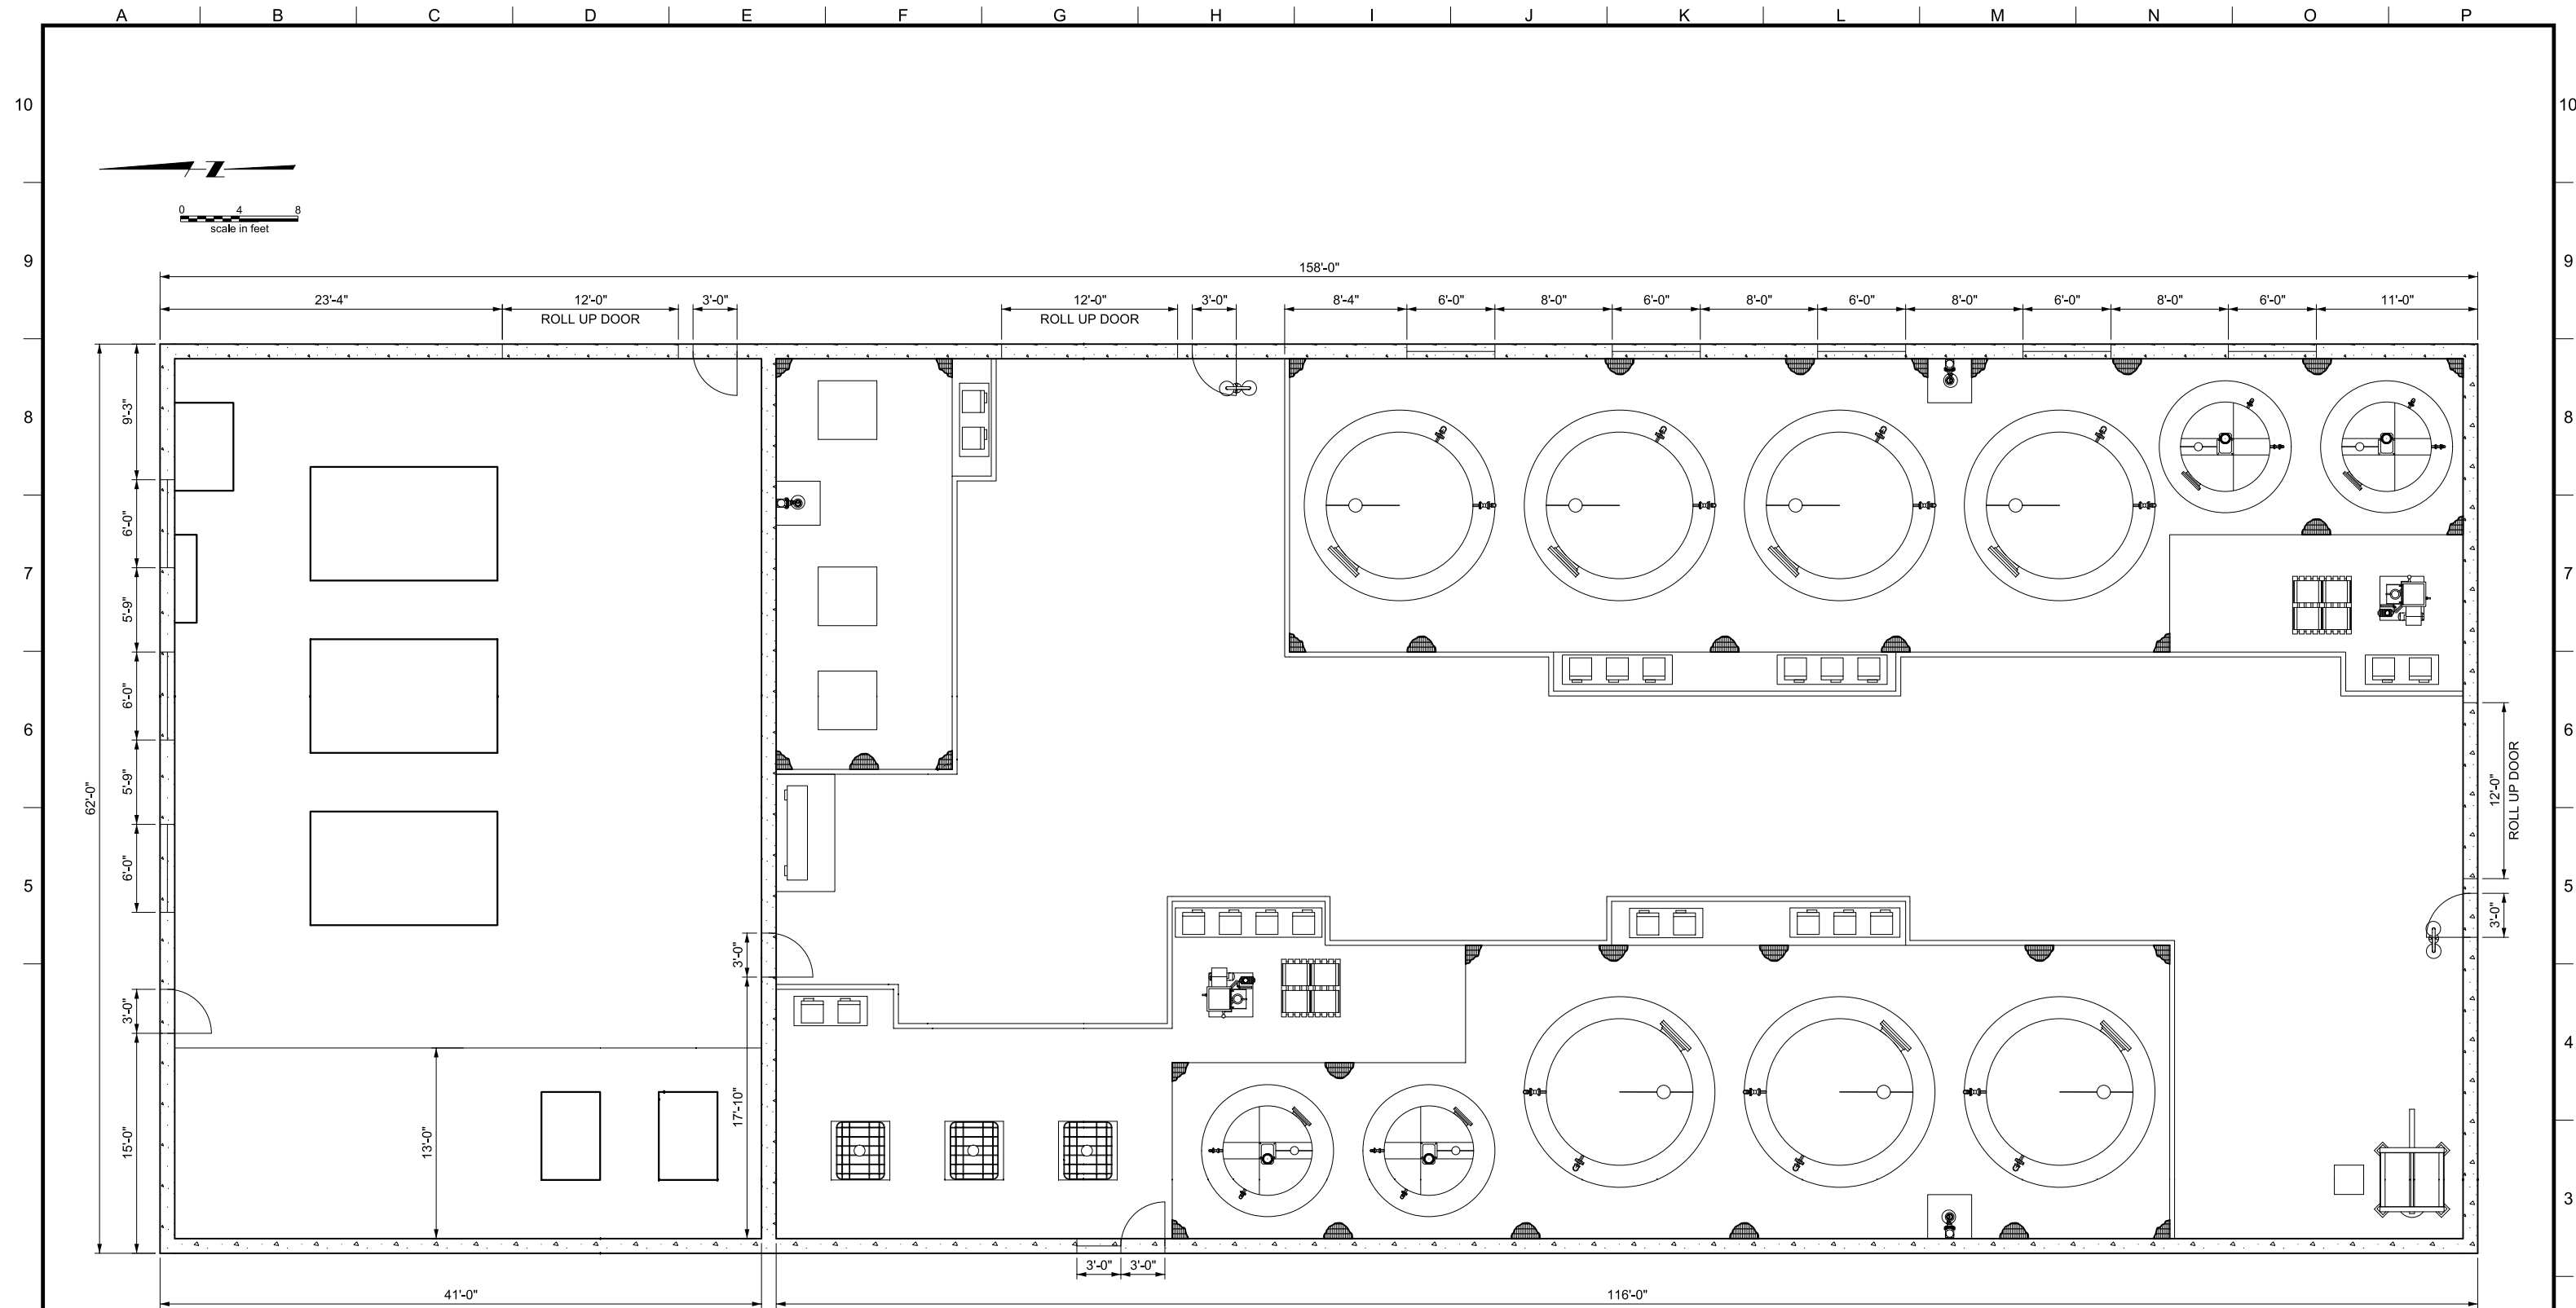
**OWNER:**  
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LAKE OSWEGO AND TIGARD WATER TREATMENT PLANT  
 DESIGN REVIEW AND CONDITIONAL USE  
**ARCHITECTURAL FLOOR PLAN**  
 ELECTRICAL / MAINTENANCE BLDG

FILENAME	
PROJECT NUMBER	
SCALE	3/16" = 1'
DRAWING/FIGURE NUMBER	9.6
### OF	





PLOT DATE: September 10, 2008 - 1:55PM USER: mtisc  
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 (IF NOT 2" - SCALE ACCORDINGLY)

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REVISIONS				
REV.	DESCRIPTION	BY	DATE	APP.

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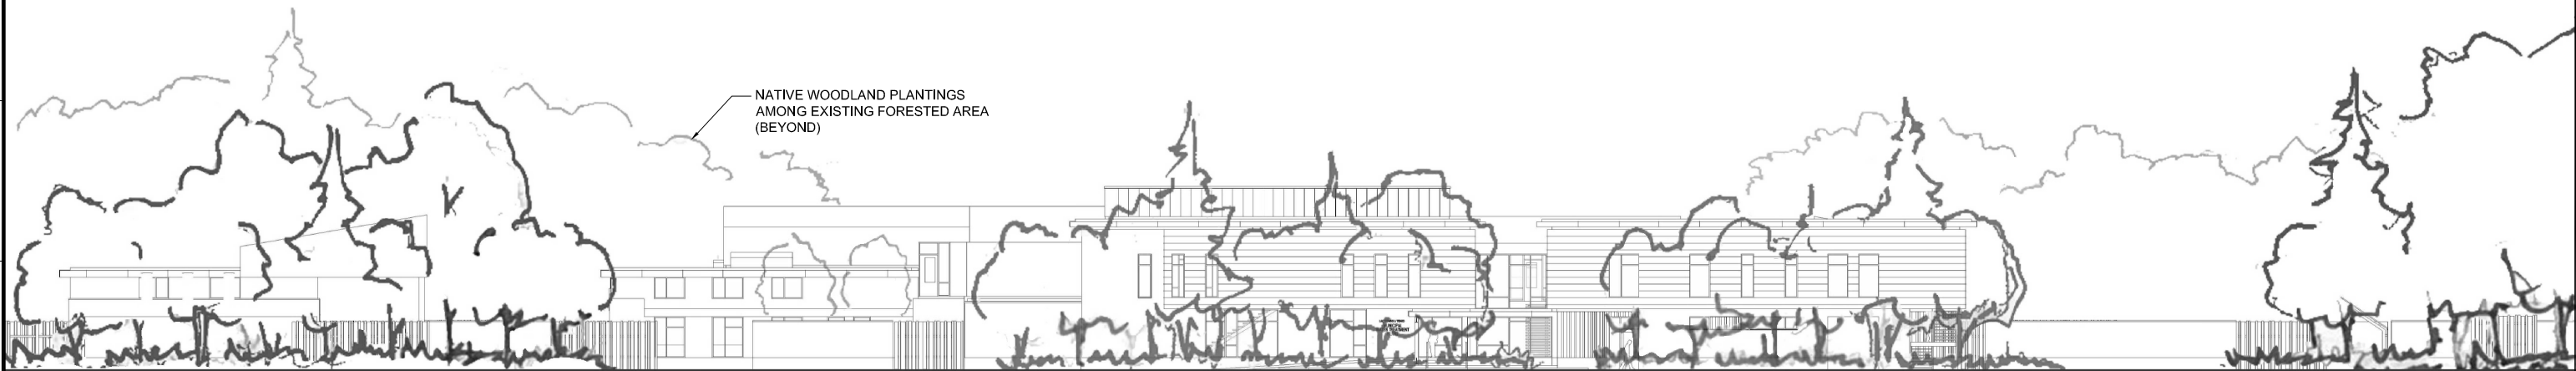


LAKE OSWEGO AND TIGARD WATER TREATMENT PLANT  
 DESIGN REVIEW AND CONDITIONAL USE  
**ARCHITECTURAL FLOOR PLAN**  
 CHEMICAL BLDG

FILENAME	
PROJECT NUMBER	
SCALE	3/16" = 1'
DRAWING/FIGURE NUMBER	9.7
### OF	

A B C D E F G H I J K L M N O P

0 8' 16' 24' 32' 40'



**NORTH ELEVATION**  
SCALE: 1/16"=1'-0"

← DECIDUOUS / EVERGREEN FOREST W/ STORMWATER WETLAND PLANTS IN FOREGROUND → PUBLIC ENTRY ← DECIDUOUS / EVERGREEN FOREST W/ STORMWATER WETLAND PLANTS IN FOREGROUND → DECIDUOUS / EVERGREEN FOREST W/ STORMWATER WETLAND PLANTS IN FOREGROUND → SERVICE ENTRY → DECIDUOUS / EVERGREEN FOREST W/ STORMWATER WETLAND PLANTS IN FOREGROUND →



**SOUTH ELEVATION**  
SCALE: 1/16"=1'-0"

← MIXED DECIDUOUS / EVERGREEN FOREST W/ SHRUB UNDERSTORY FROM 1'-5' SHRUB HEIGHT → MEDOW PLANTINGS → MIXED DECIDUOUS / EVERGREEN FOREST W/ SHRUB UNDERSTORY FROM 1'-5' SHRUB HEIGHT → CONNECTING PATH → MIXED DECIDUOUS / EVERGREEN FOREST W/ SHRUB UNDERSTORY FROM 1'-5' SHRUB HEIGHT →



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APPROVED: \_\_\_\_\_

REVISIONS				
REV.	DESCRIPTION	BY	APP.	

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LAKE OSWEGO AND TIGARD WATER TREATMENT PLANT  
DESIGN REVIEW AND CONDITIONAL USE  
**COMPOSITE ELEVATIONS**  
NORTH/SOUTH


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DRAWING/FIGURE NUMBER	
OF	

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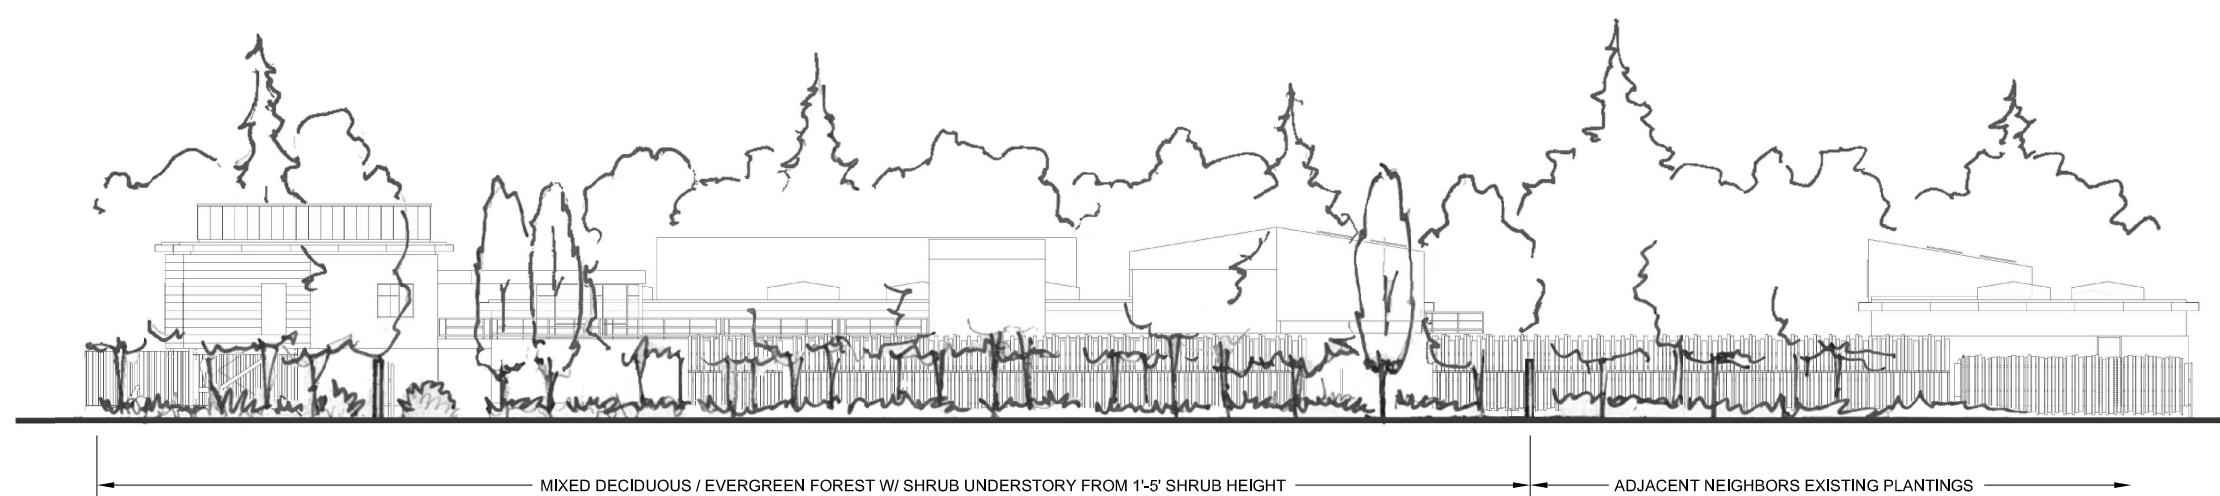
A B C D E F G H I J K L M N O P

A B C D E F G H I J K L M N O P

0 8' 16' 24' 32' 40'

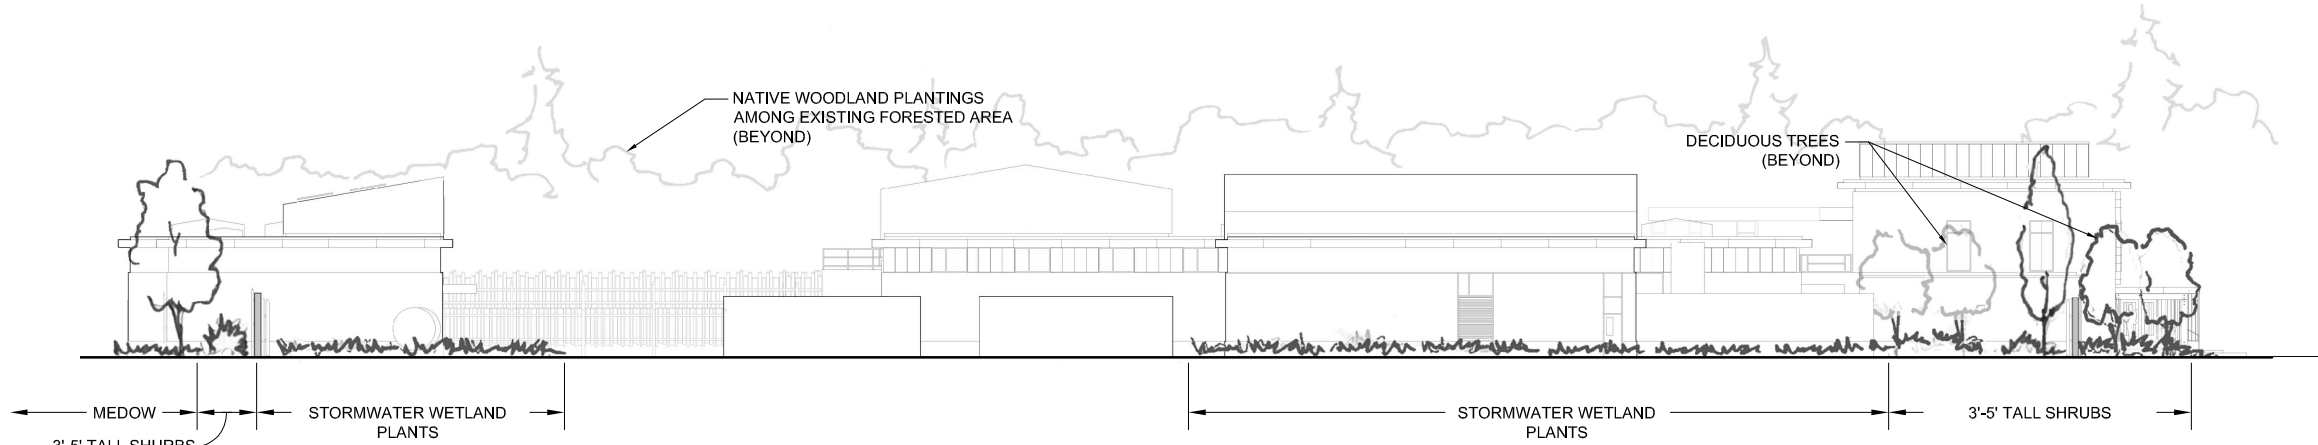

**EAST ELEVATION**  
SCALE: 1/16"=1'-0"



**WEST ELEVATION**  
SCALE: 1/16"=1'-0"



LINE IS 2 INCHES  
AT FULL SIZE  
(IF NOT 2" - SCALE ACCORDINGLY)

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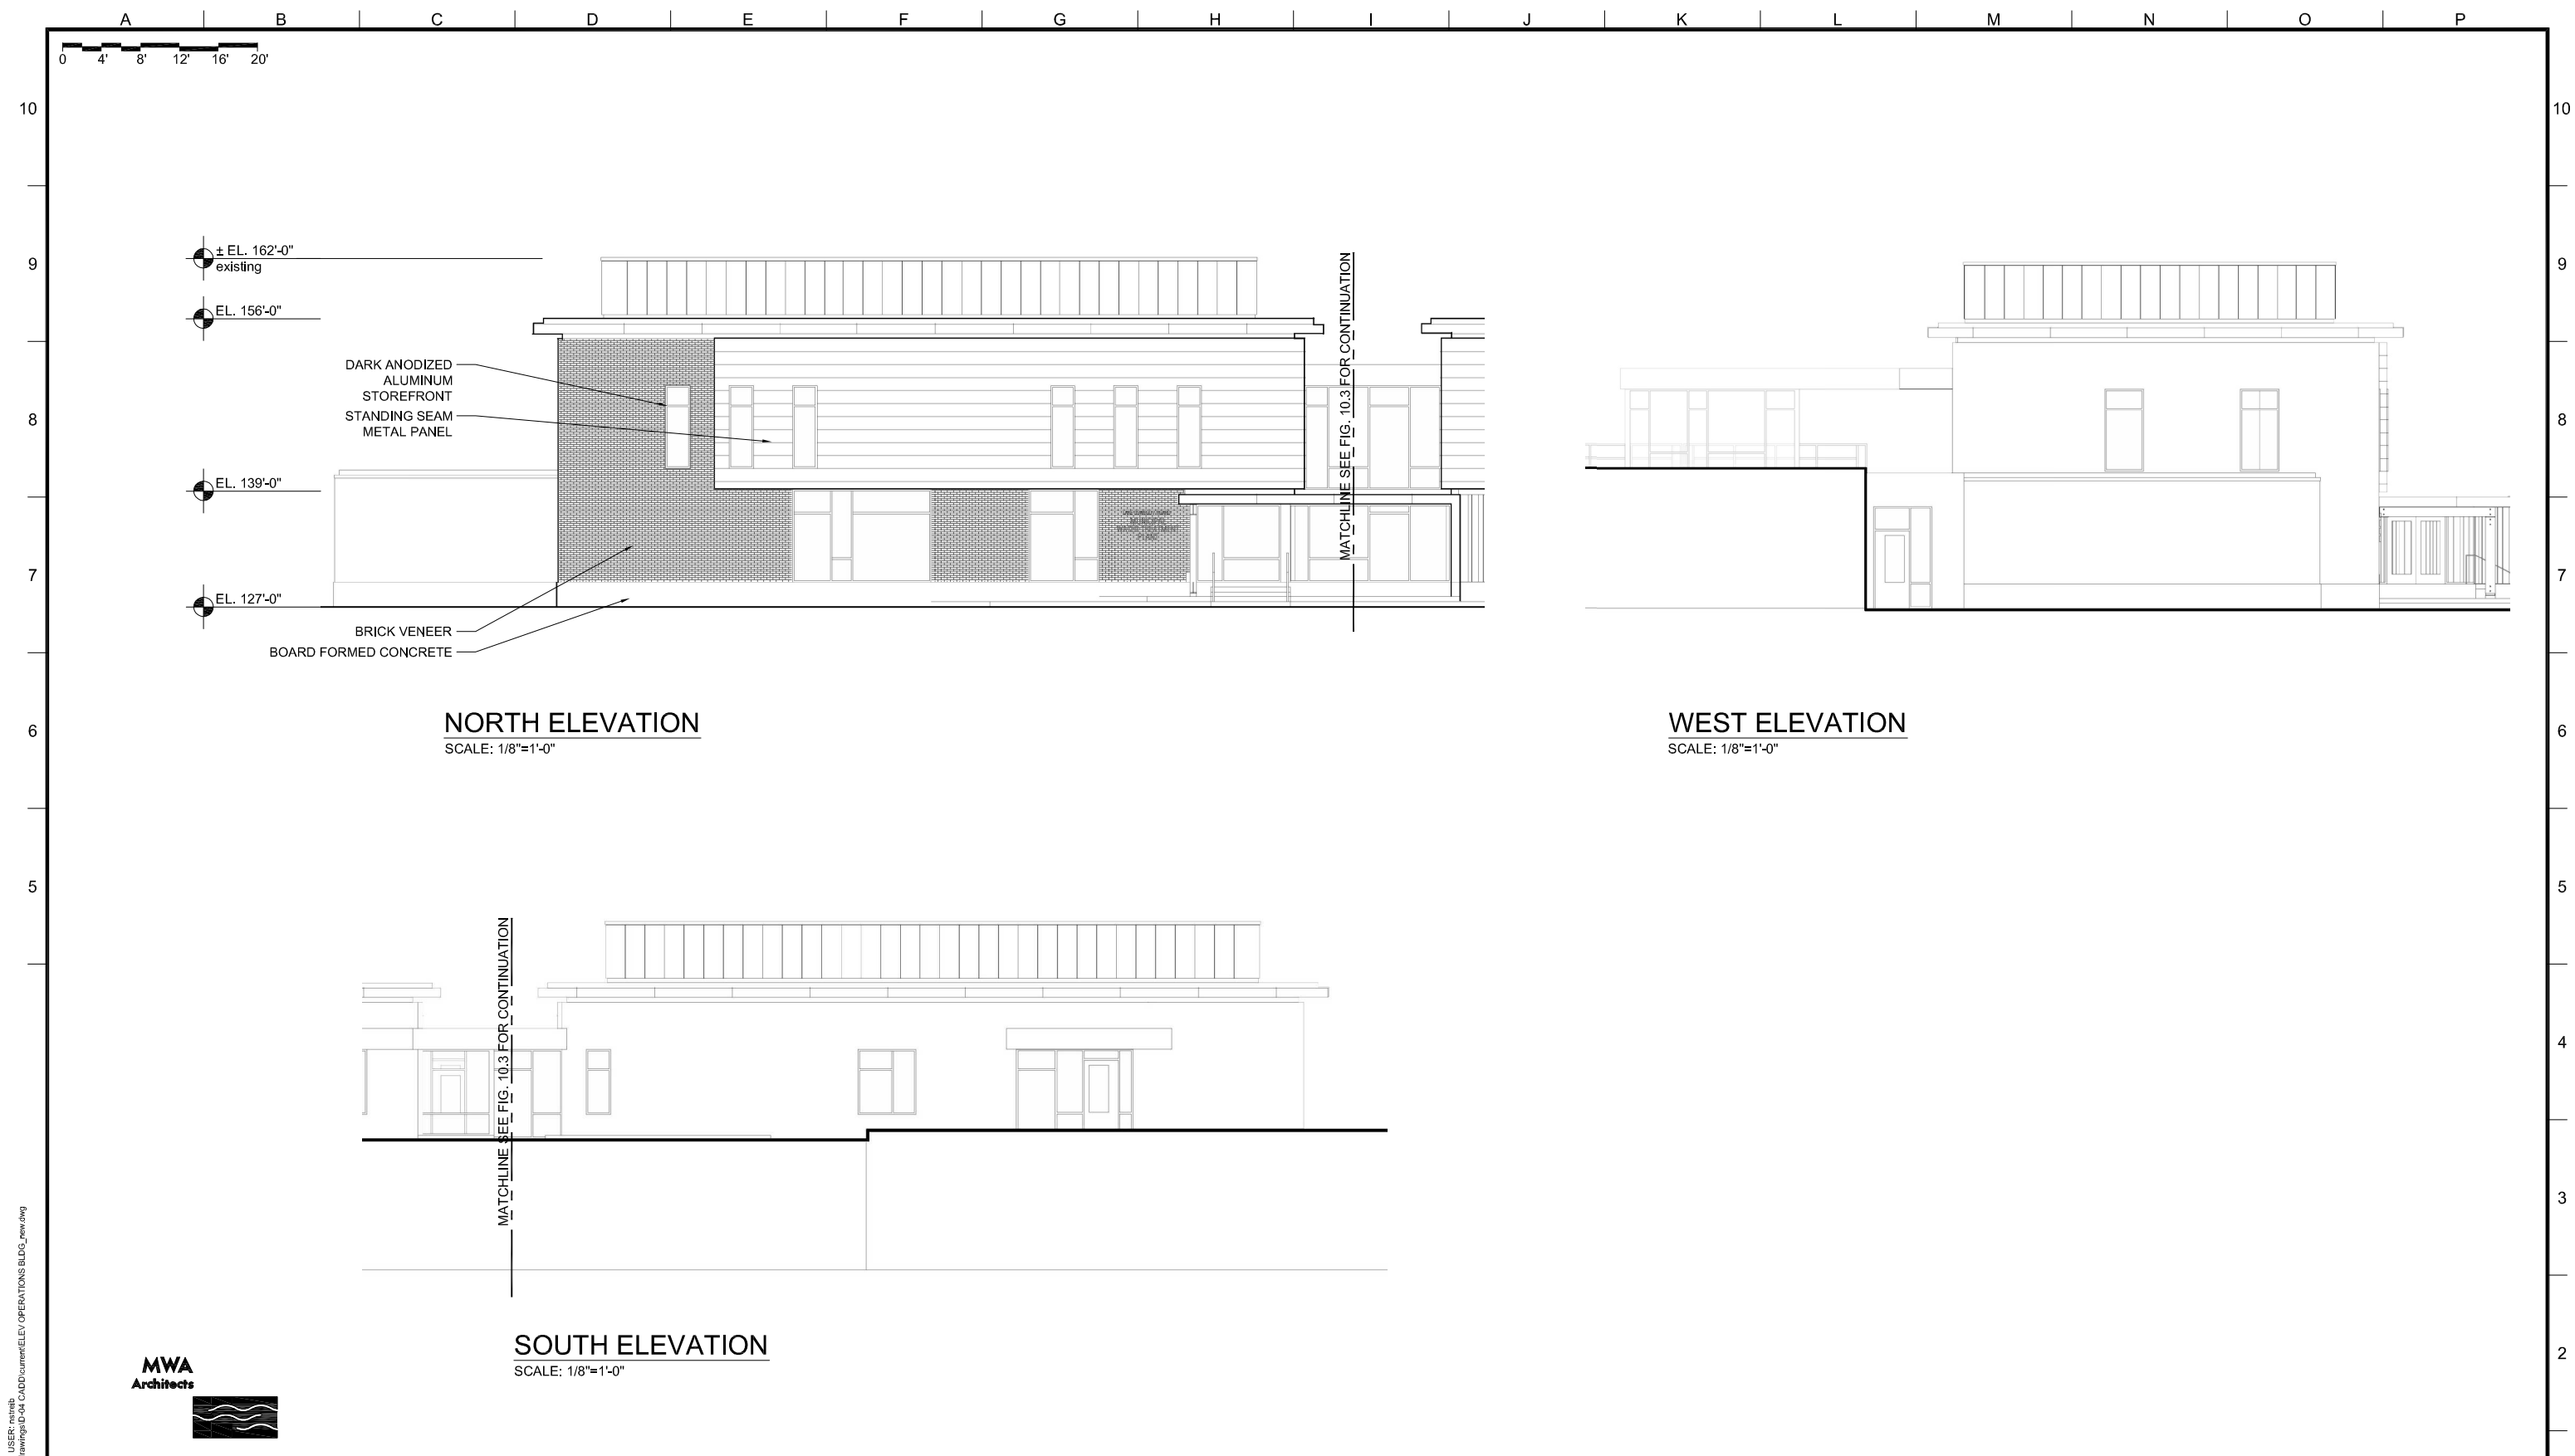
LAKE OSWEGO AND TIGARD WATER TREATMENT PLANT

DESIGN REVIEW AND CONDITIONAL USE  
**COMPOSITE ELEVATIONS  
EAST/WEST**

FILENAME
PROJECT NUMBER
SCALE AS SHOWN
DRAWING/FIGURE NUMBER <b>10.1</b>
OF

PLOT DATE: January 13, 2012 - 5:42AM USER: rmmchugh FILE: P:\2011\2200 Lake Oswego WTP\Drawings\04 CAD\Current\COMPOSITE\_WEST.dwg

A B C D E F G H I J K L M N O P



**NORTH ELEVATION**  
SCALE: 1/8"=1'-0"

**WEST ELEVATION**  
SCALE: 1/8"=1'-0"

**SOUTH ELEVATION**  
SCALE: 1/8"=1'-0"



REVISIONS				
REV.	DESCRIPTION	BY	DATE	APP.

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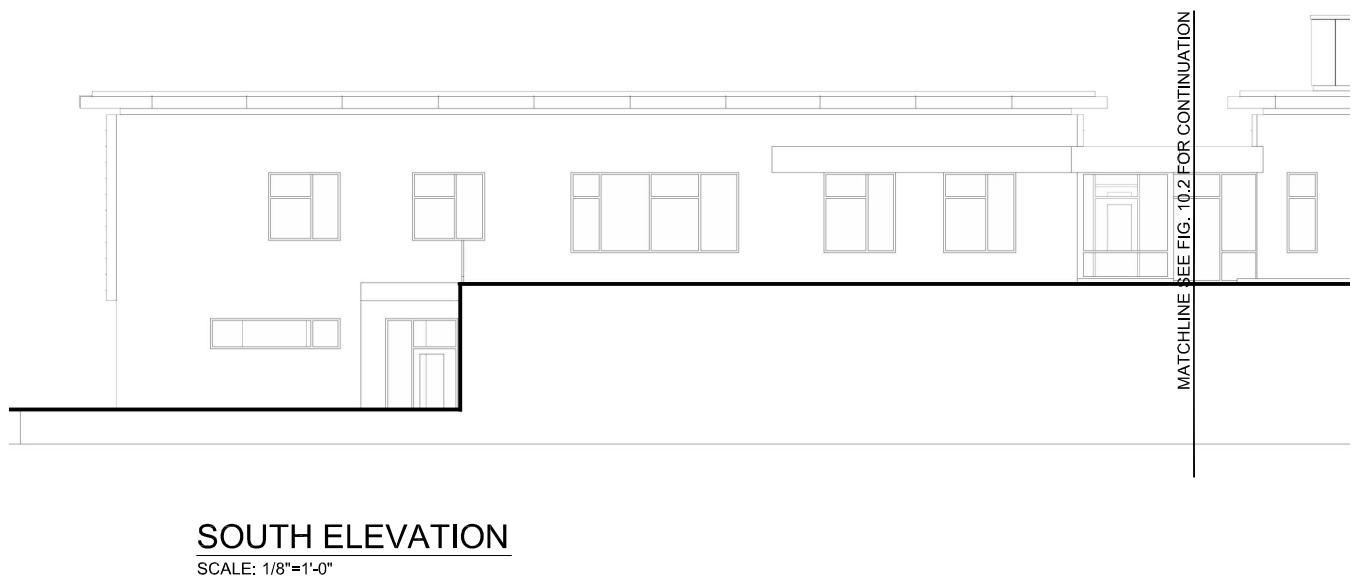
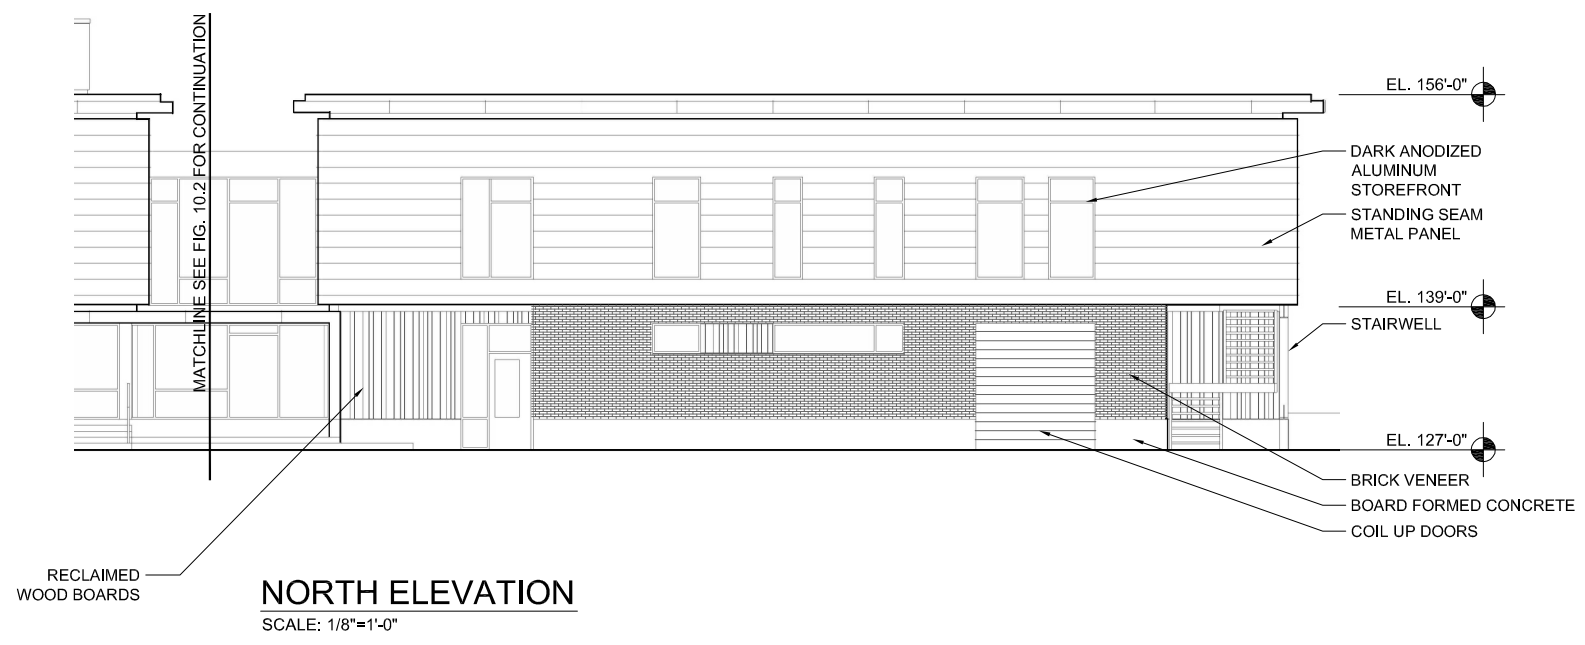
LAKE OSWEGO AND TIGARD WATER TREATMENT PLANT  
DESIGN REVIEW AND CONDITIONAL USE  
**OPERATIONS BUILDING ELEVATIONS**

FILENAME	
PROJECT NUMBER	
SCALE	AS SHOWN
DRAWING/FIGURE NUMBER	10.2
OF	

PLOT DATE: January 10, 2012 - 5:23PM USER: nrsrab  
 FILE: P:201122.00.Lake Oswego WTP-D-drawings-D-04.CADD\document\ELEV OPERATIONS BLDG.dwg

A B C D E F G H I J K L M N O P  
 0 4' 8' 12' 16' 20'

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CHECKED: \_\_\_\_\_

APPROVED: \_\_\_\_\_

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LAKE OSWEGO AND TIGARD WATER TREATMENT PLANT

DESIGN REVIEW AND CONDITIONAL USE

**ADMINISTRATION BUILDING ELEVATIONS**


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A B C D E F G H I J K L M N O P


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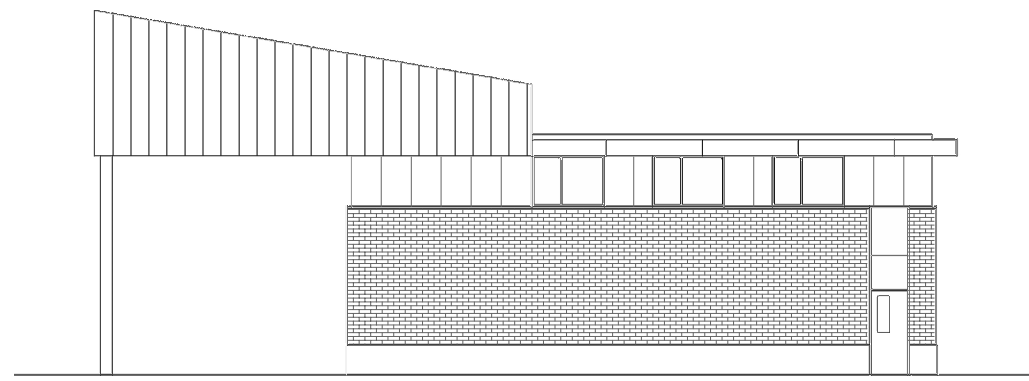
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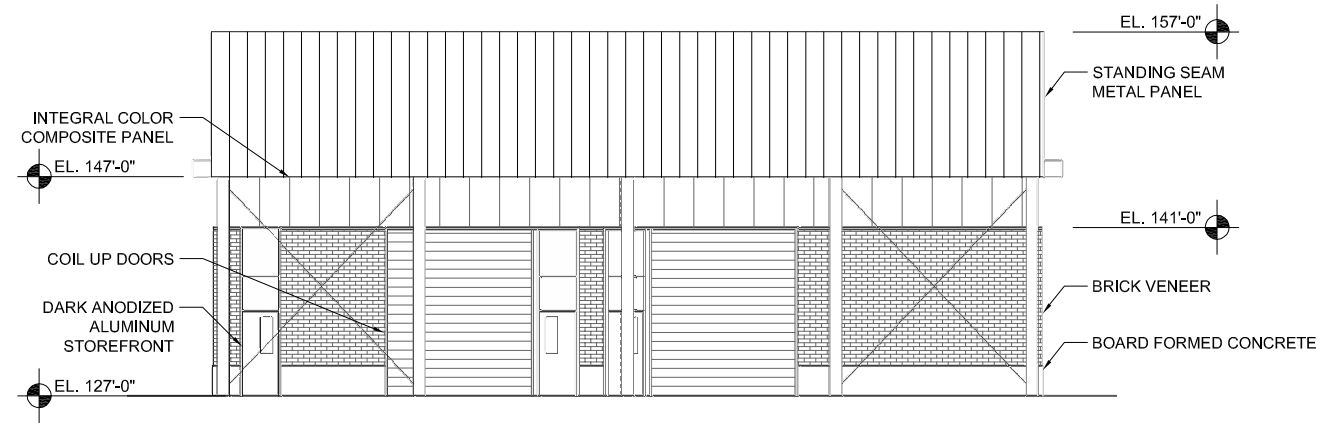
**NORTH ELEVATION**  
SCALE: 1/8"=1'-0"



**EAST ELEVATION**  
SCALE: 1/8"=1'-0"

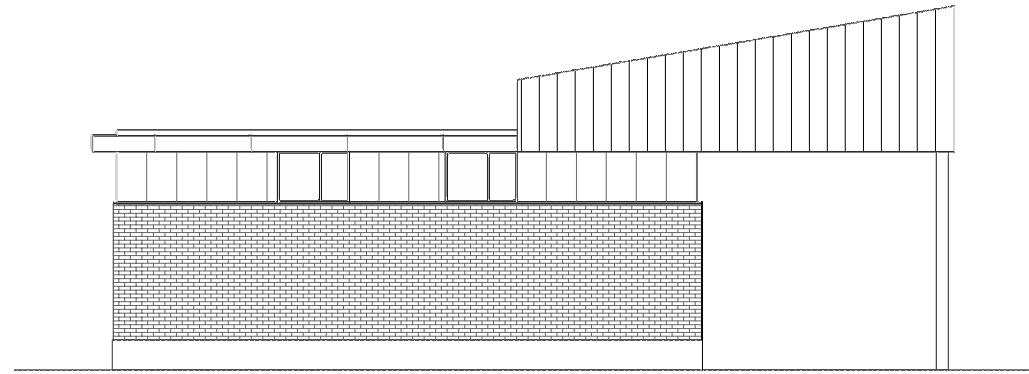

**SOUTH ELEVATION**  
SCALE: 1/8"=1'-0"

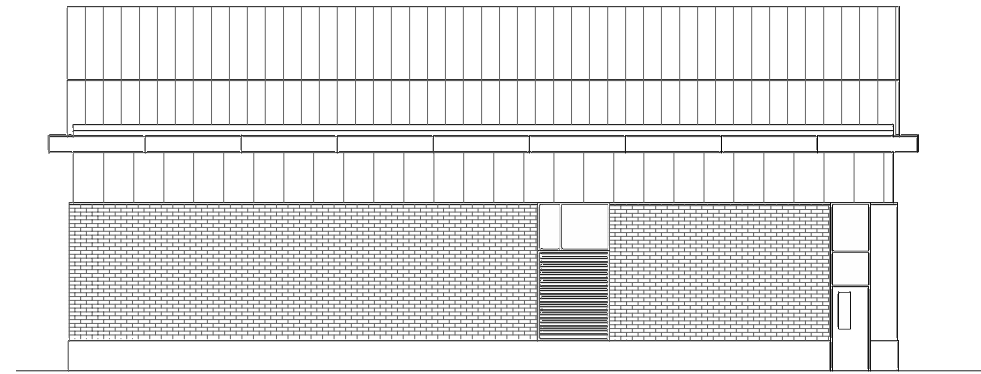

**WEST ELEVATION**  
SCALE: 1/8"=1'-0"



LINE IS 2 INCHES  
AT FULL SIZE  
(IF NOT 2" - SCALE ACCORDINGLY)

DESIGNED: \_\_\_\_\_  
DRAWN: \_\_\_\_\_  
CHECKED: \_\_\_\_\_  
CHECKED: \_\_\_\_\_  
APPROVED: \_\_\_\_\_

REVISIONS				
REV.	DESCRIPTION	BY	DATE	APP.

**OWNER:**  
CITY OF LAKE OSWEGO  
380 A AVENUE  
LAKE OSWEGO, OR 97034  
PHONE: 503-635-0270




LAKE OSWEGO AND TIGARD WATER TREATMENT PLANT

DESIGN REVIEW AND CONDITIONAL USE  
**MECHANICAL DEWATERING BUILDING ELEVATIONS**

FILENAME	
PROJECT NUMBER	
SCALE	AS SHOWN
DRAWING/FIGURE NUMBER	10.4
OF	


PLOT DATE: January 13, 2012 - 9:32AM USER: rmmchugh FILE: P:\2011\2200 Lake Oswego WTP\Drawings\04 CAD\Content\ELEV MECH DEWATERING BLDG.dwg

A B C D E F G H I J K L M N O P

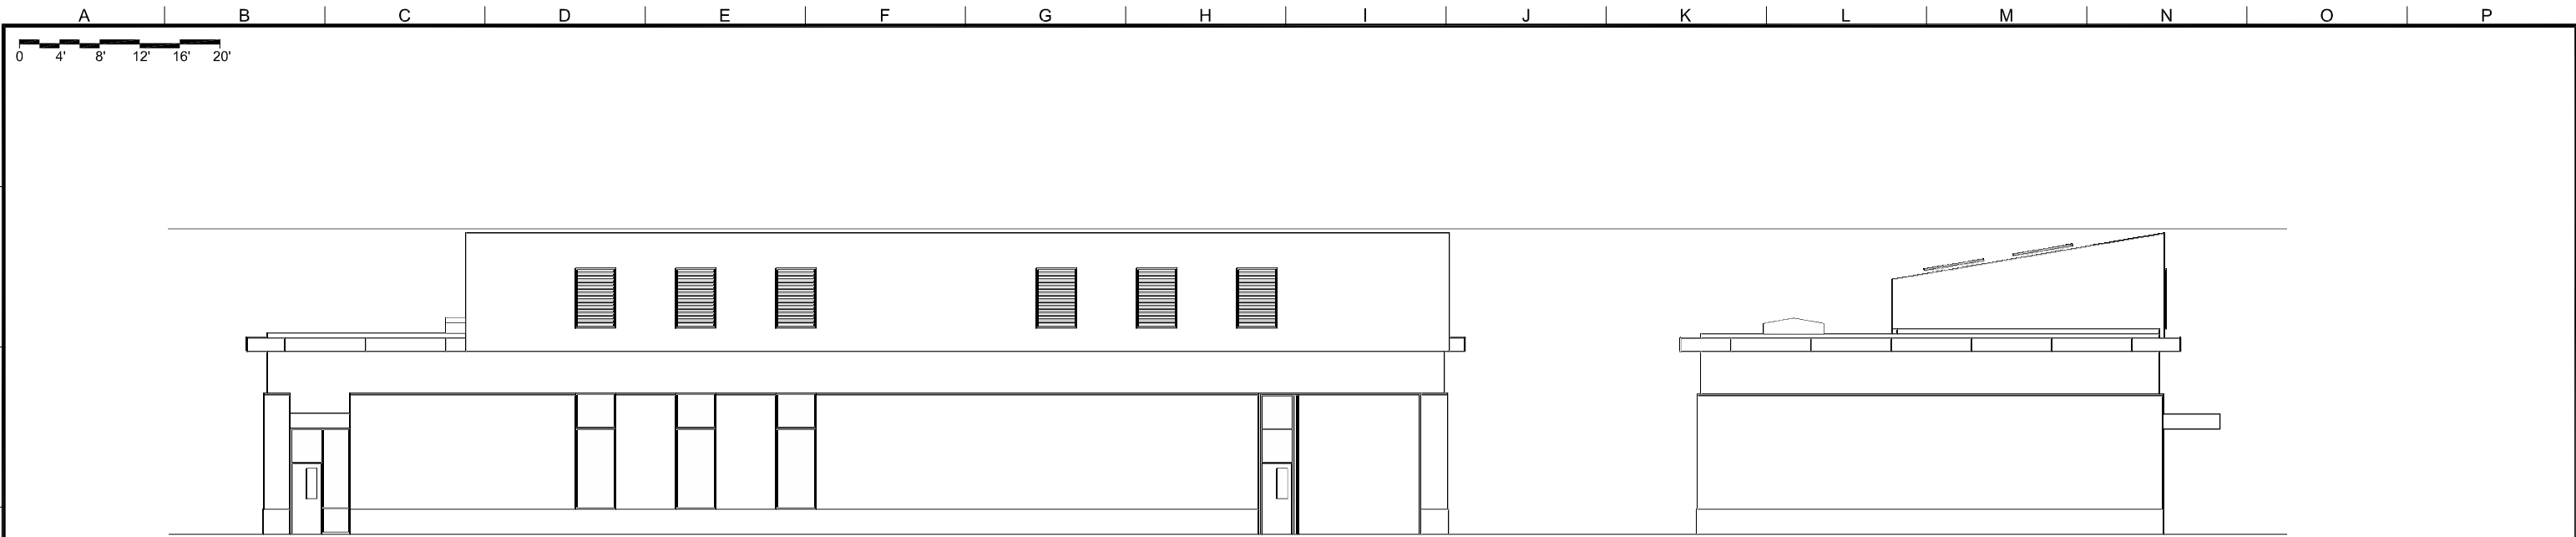


**NORTH ELEVATION**  
SCALE: 1/8"=1'-0"

**EAST ELEVATION**  
SCALE: 1/8"=1'-0"

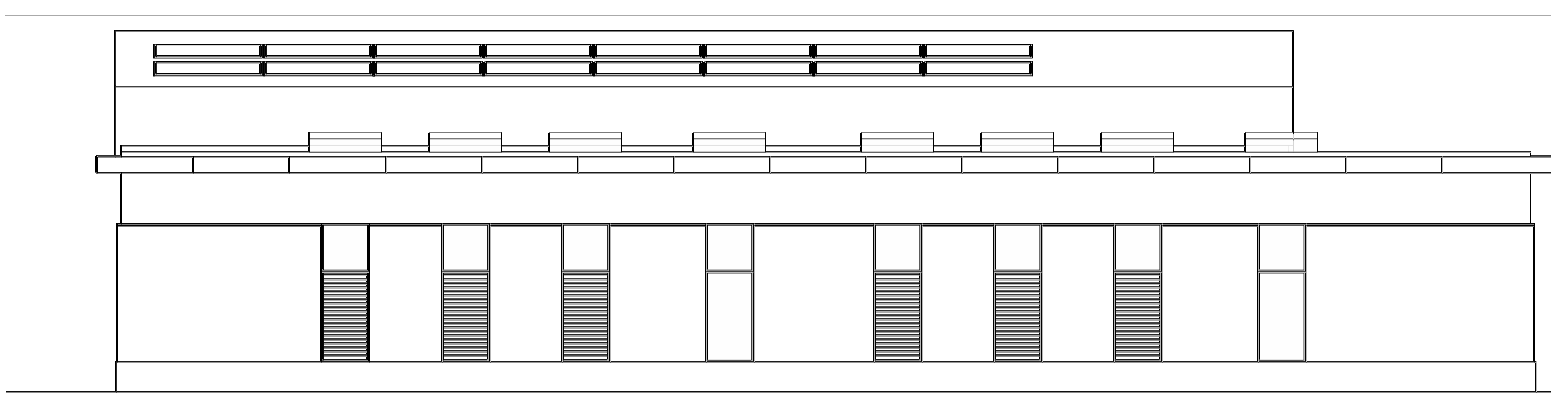

**SOUTH ELEVATION**  
SCALE: 1/8"=1'-0"

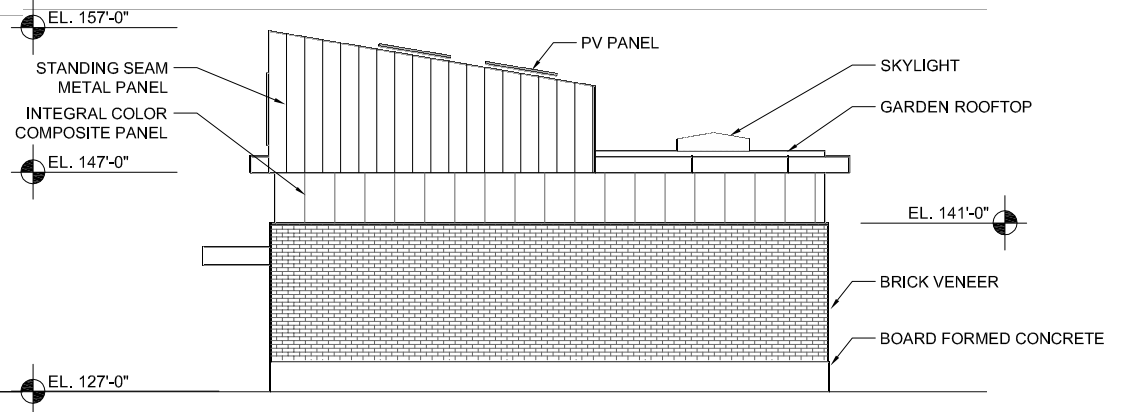

**WEST ELEVATION**  
SCALE: 1/8"=1'-0"



LINE IS 2 INCHES  
AT FULL SIZE  
(IF NOT 2" - SCALE ACCORDINGLY)

DESIGNED: \_\_\_\_\_  
DRAWN: \_\_\_\_\_  
CHECKED: \_\_\_\_\_  
CHECKED: \_\_\_\_\_  
APPROVED: \_\_\_\_\_

REVISIONS				
REV.	DESCRIPTION	BY		APP.

**OWNER:**  
CITY OF LAKE OSWEGO  
380 A AVENUE  
LAKE OSWEGO, OR 97034  
PHONE: 503-635-0270




LAKE OSWEGO AND TIGARD WATER TREATMENT PLANT

DESIGN REVIEW AND CONDITIONAL USE  
**FINISH WATER PUMP STATION  
ELEVATIONS**


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SCALE AS SHOWN
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OF

PLOT DATE: January 13, 2012 - 9:33AM USER: rmmchugh FILE: P:\2011\2200 Lake Oswego WTP\Drawings\04 CAD\Current\ELEV HPFS.BLDG.dwg

A B C D E F G H I J K L M N O P  
 0 4' 8' 12' 16' 20'

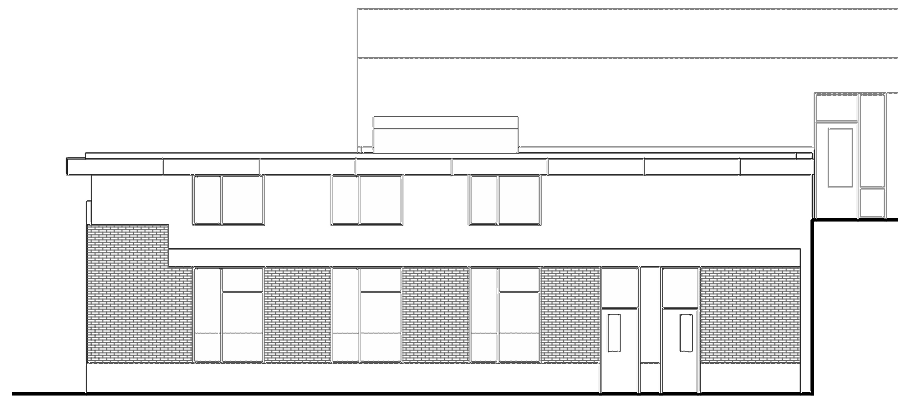

**NORTH ELEVATION**  
 SCALE: 1/8"=1'-0"

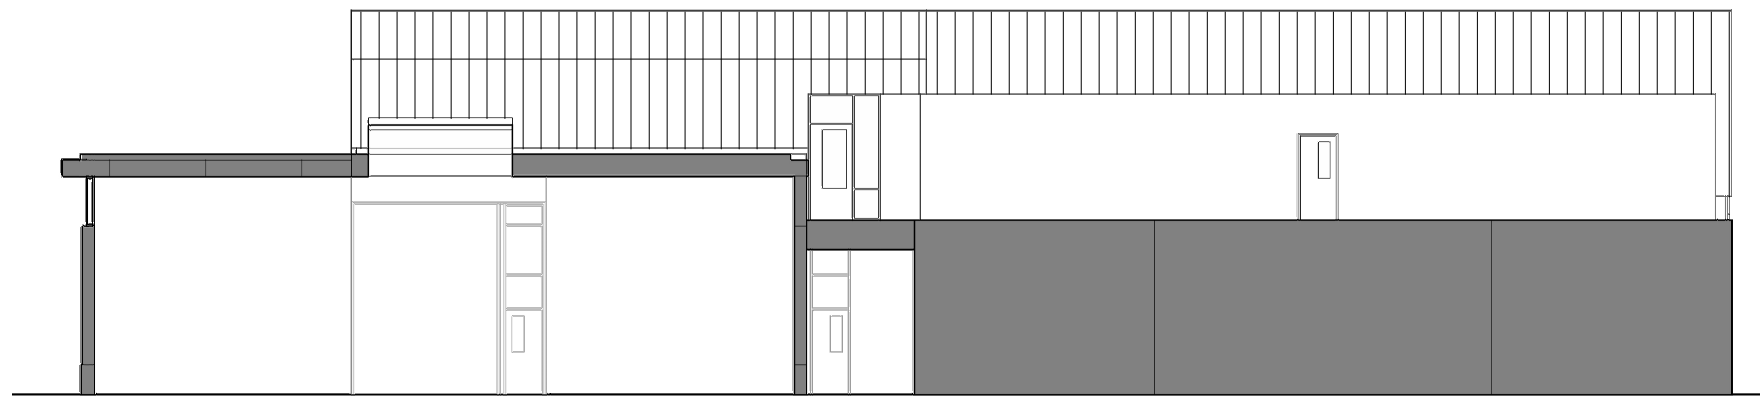

**NORTH SECTION / ELEVATION**  
 SCALE: 1/8"=1'-0"



**EAST ELEVATION**  
 SCALE: 1/8"=1'-0"



LINE IS 2 INCHES  
 AT FULL SIZE  
 (IF NOT 2" - SCALE ACCORDINGLY)

DESIGNED: \_\_\_\_\_  
 DRAWN: \_\_\_\_\_  
 CHECKED: \_\_\_\_\_  
 CHECKED: \_\_\_\_\_  
 APPROVED: \_\_\_\_\_

REVISIONS				
REV.	DESCRIPTION	BY	DATE	APP.

**OWNER:**  
 CITY OF LAKE OSWEGO  
 380 A AVENUE  
 LAKE OSWEGO, OR 97034  
 PHONE: 503-635-0270





LAKE OSWEGO AND TIGARD WATER TREATMENT PLANT  
 DESIGN REVIEW AND CONDITIONAL USE  
**CHEMICAL BUILDING  
 ELEVATIONS I**


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SCALE AS SHOWN
DRAWING/FIGURE NUMBER <b>10.7</b>
OF

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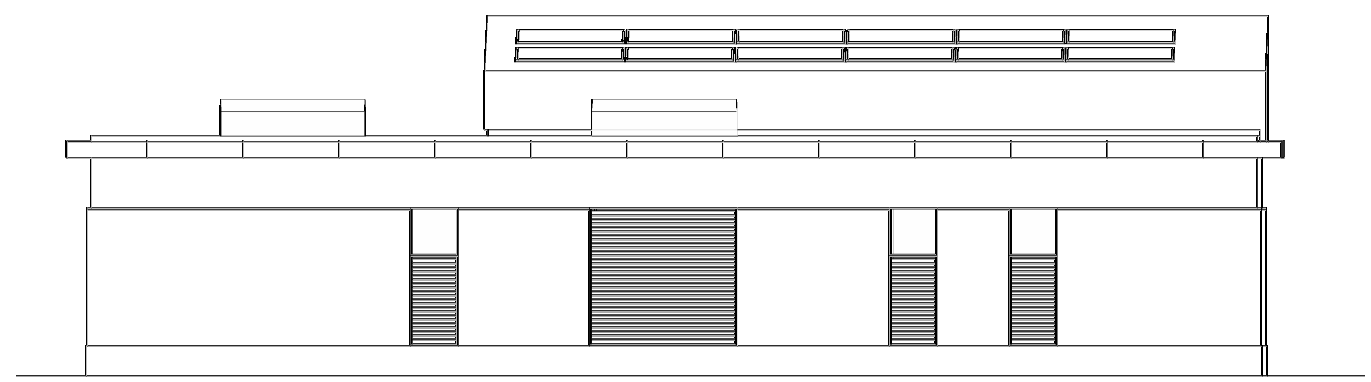


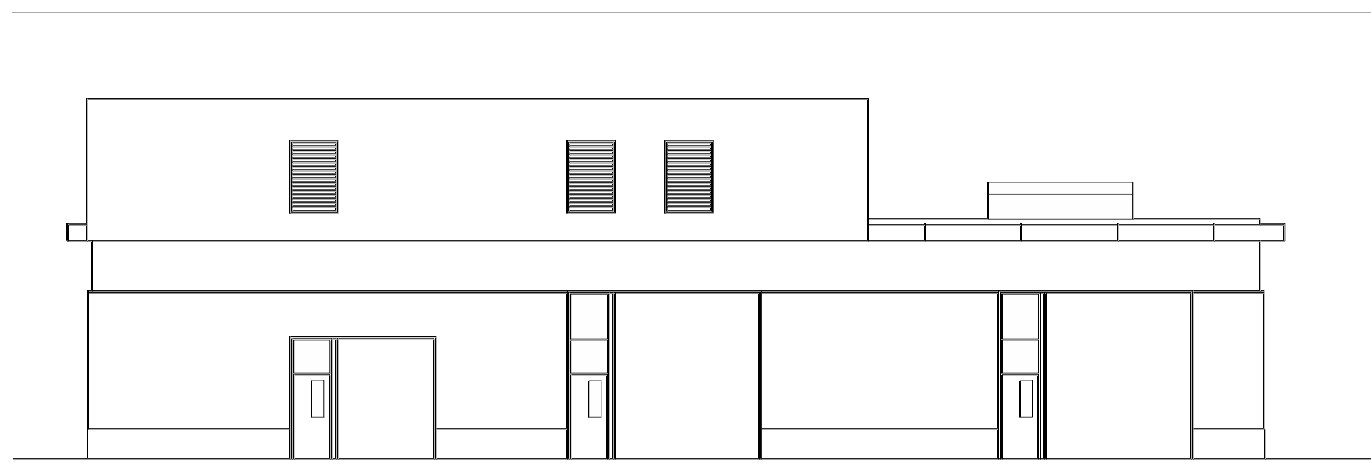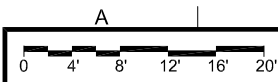


**NORTH ELEVATION**  
SCALE: 1/8"=1'-0"

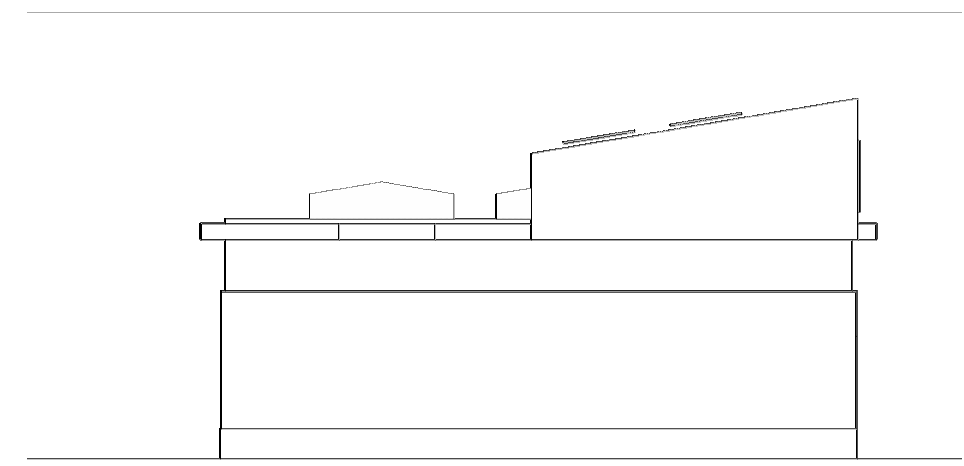

**EAST ELEVATION**  
SCALE: 1/8"=1'-0"



**SOUTH ELEVATION**  
SCALE: 1/8"=1'-0"

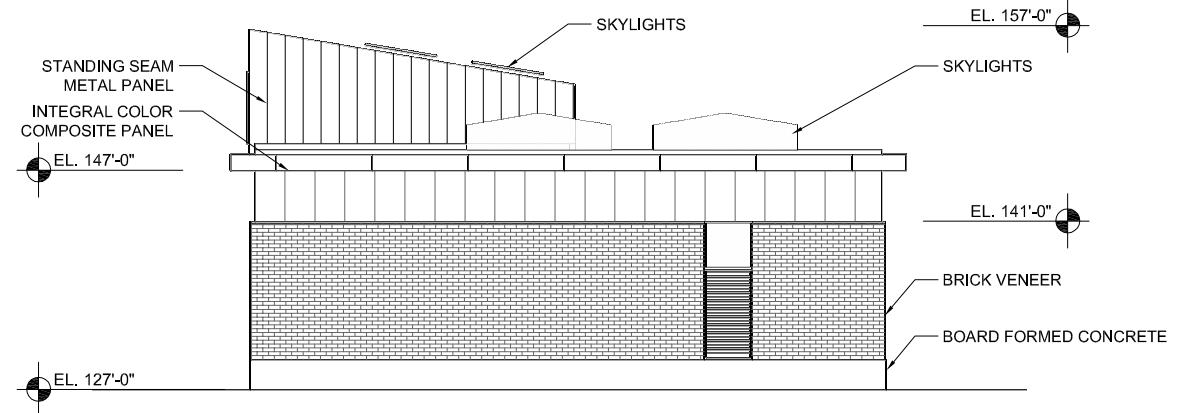

**WEST ELEVATION**  
SCALE: 1/8"=1'-0"



LINE IS 2 INCHES  
AT FULL SIZE  
(IF NOT 2" - SCALE ACCORDINGLY)

DESIGNED: \_\_\_\_\_  
DRAWN: \_\_\_\_\_  
CHECKED: \_\_\_\_\_  
CHECKED: \_\_\_\_\_  
APPROVED: \_\_\_\_\_

REVISIONS				
REV.	DESCRIPTION	BY	DATE	APP.

**OWNER:**  
CITY OF LAKE OSWEGO  
380 A AVENUE  
LAKE OSWEGO, OR 97034  
PHONE: 503-635-0270



LAKE OSWEGO AND TIGARD WATER TREATMENT PLANT


DESIGN REVIEW AND CONDITIONAL USE  
SITE ELECTRICAL / MAINT. BUILDING  
ELEVATIONS

FILENAME	
PROJECT NUMBER	
SCALE	AS SHOWN
DRAWING/FIGURE NUMBER	10.6
OF	


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A B C D E F G H I J K L M N O P  
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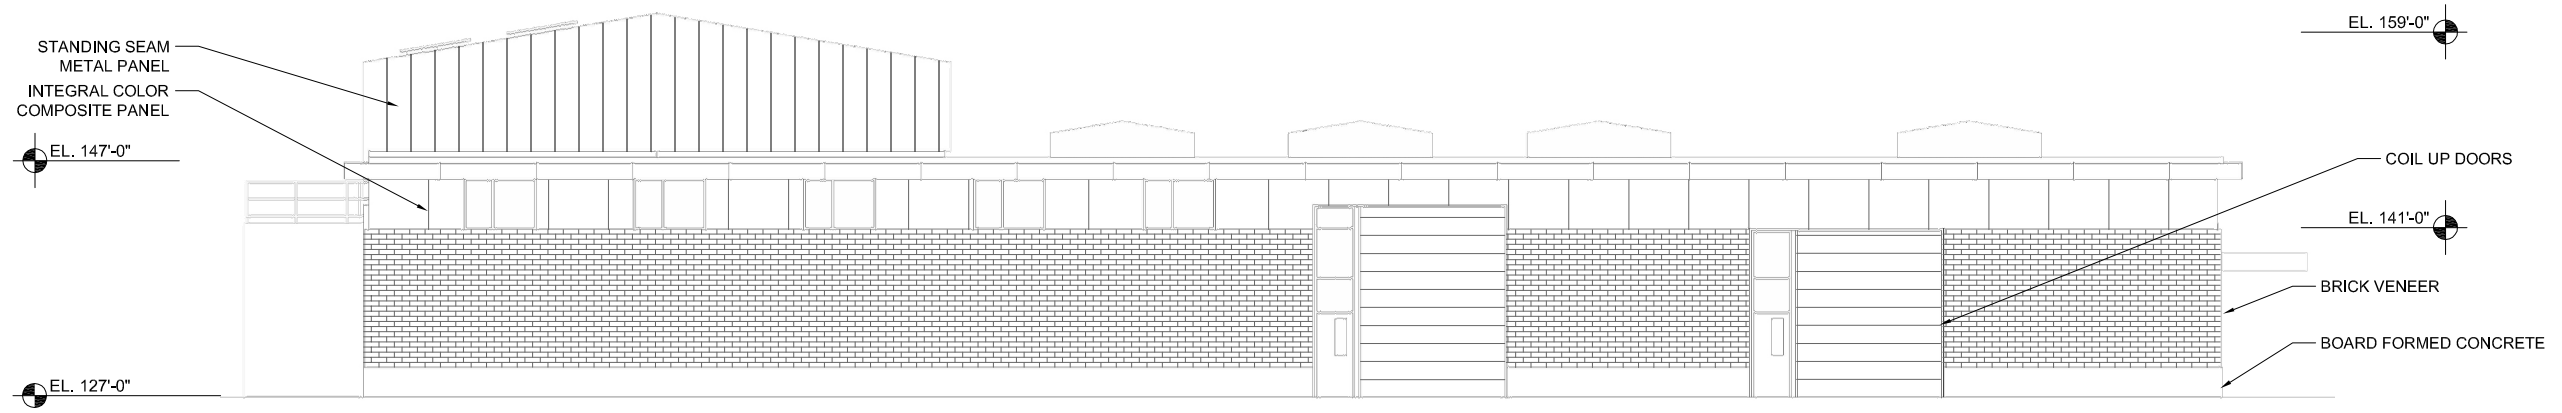
10  
9  
8  
7  
6  
5  
4  
3  
2  
1



**NORTH ELEVATION**  
 SCALE: 1/8"=1'-0"

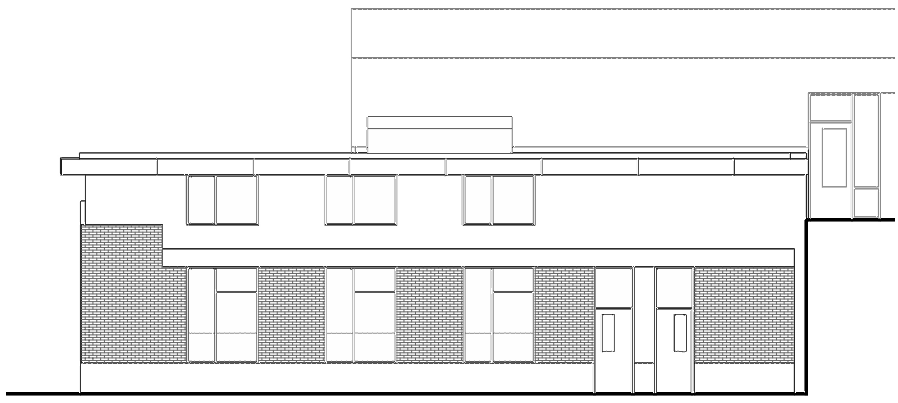

**NORTH SECTION / ELEVATION**  
 SCALE: 1/8"=1'-0"

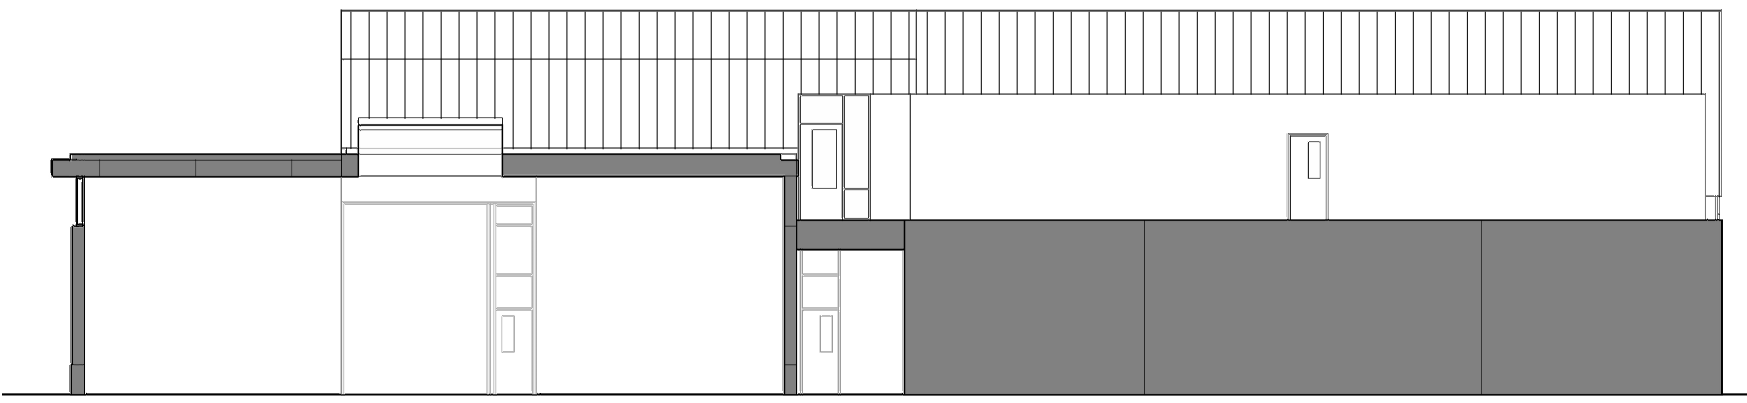

**EAST ELEVATION**  
 SCALE: 1/8"=1'-0"



LINE IS 2 INCHES  
 AT FULL SIZE  
 (IF NOT 2" - SCALE ACCORDINGLY)

DESIGNED: \_\_\_\_\_  
 DRAWN: \_\_\_\_\_  
 CHECKED: \_\_\_\_\_  
 CHECKED: \_\_\_\_\_  
 APPROVED: \_\_\_\_\_

REVISIONS				
REV.	DESCRIPTION	BY	APP.	

**OWNER:**  
 CITY OF LAKE OSWEGO  
 380 A AVENUE  
 LAKE OSWEGO, OR 97034  
 PHONE: 503-635-0270



LAKE OSWEGO AND TIGARD WATER TREATMENT PLANT


DESIGN REVIEW AND CONDITIONAL USE

**CHEMICAL BUILDING  
 ELEVATIONS I**


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PROJECT NUMBER	
SCALE	AS SHOWN
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OF	

PLOT DATE: January 13, 2012 - 5:40AM USER: rmmchugh FILE: P:\2011\2200 Lake Oswego WTP\Drawings\04 CAD\Content\ELEV CHEMICAL BLDG\_1.dwg

A B C D E F G H I J K L M N O P

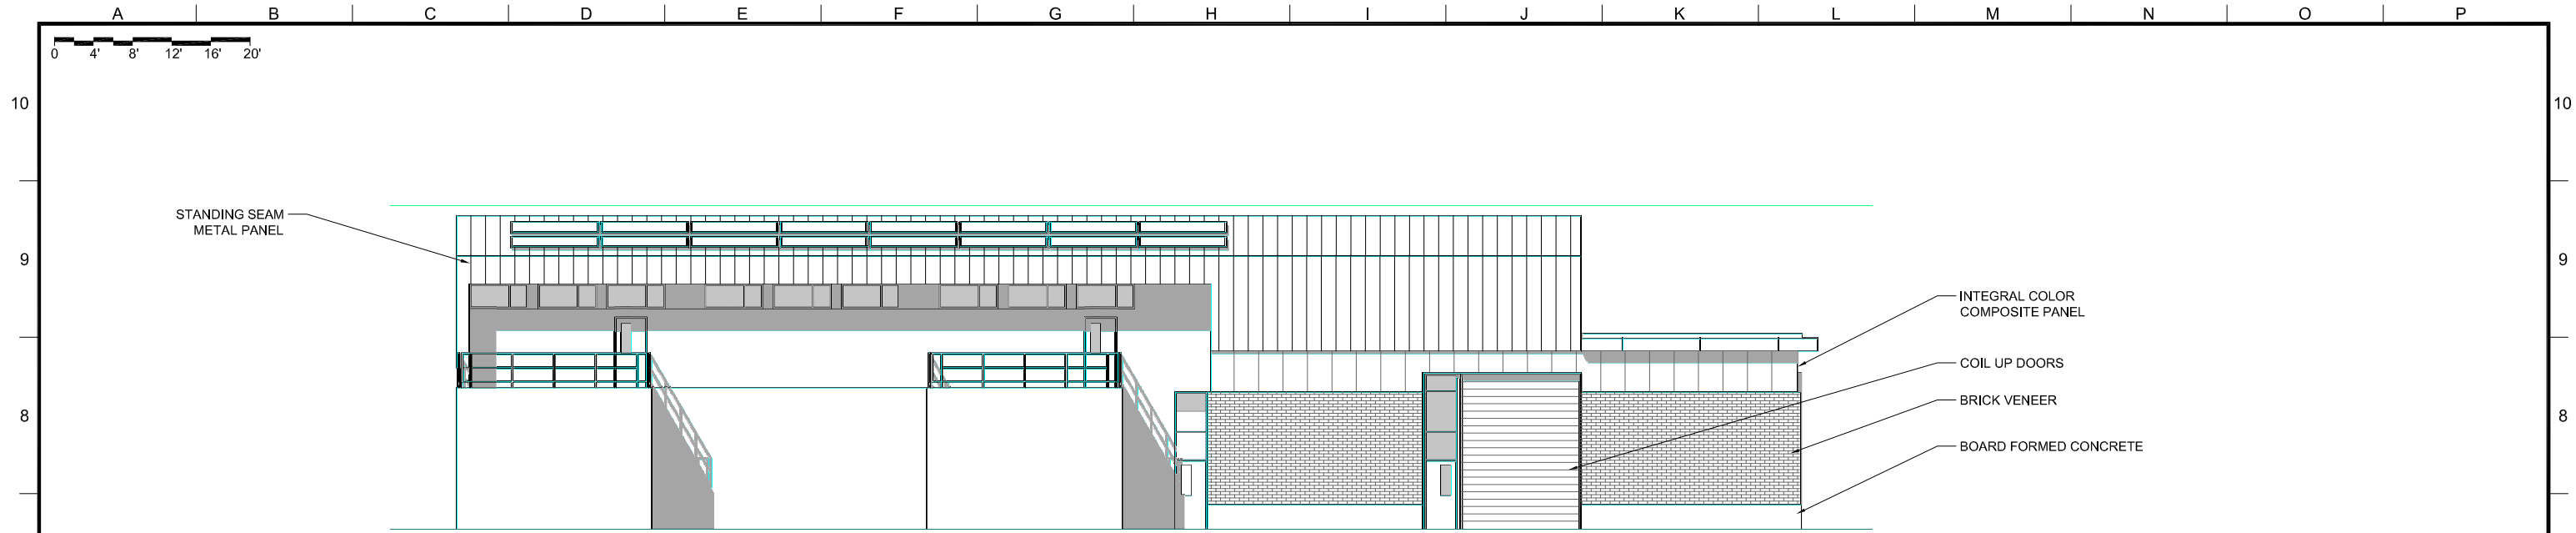

**SOUTH ELEVATION**  
SCALE: 1/8"=1'-0"

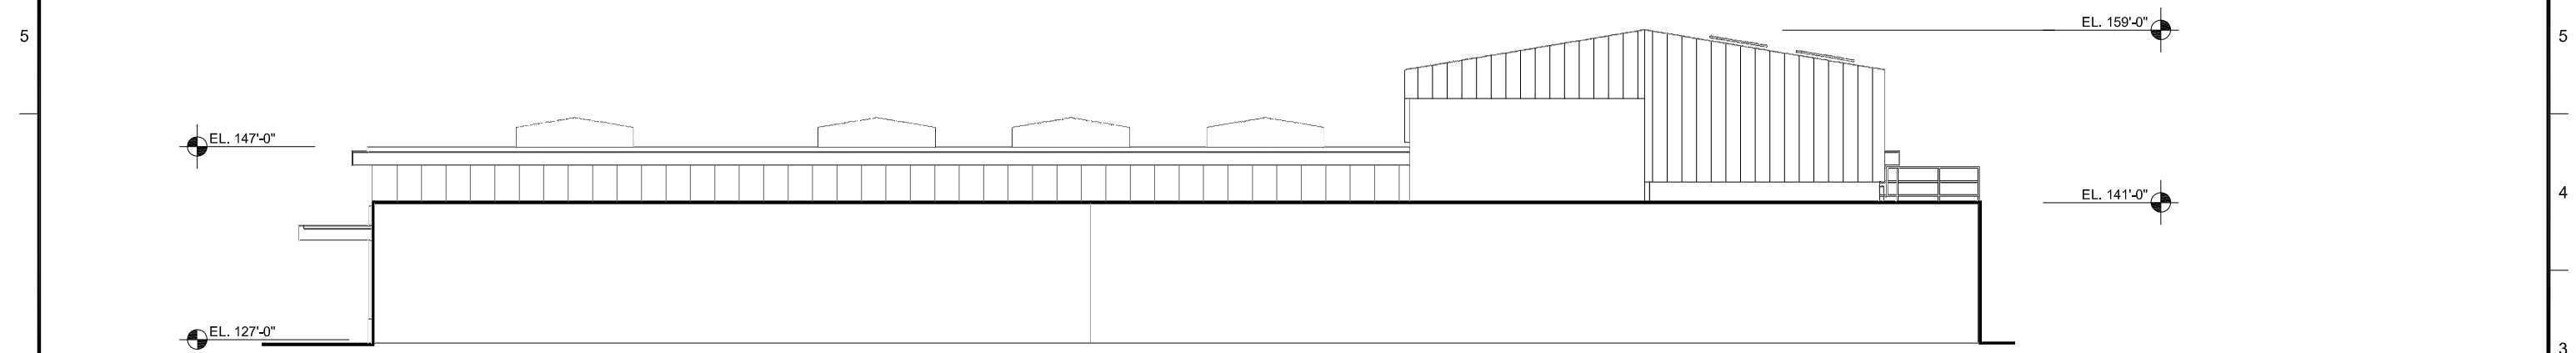

**WEST ELEVATION**  
SCALE: 1/8"=1'-0"



REVISIONS				
REV.	DESCRIPTION	BY	APP.	

LINE IS 2 INCHES AT FULL SIZE (IF NOT 2" - SCALE ACCORDINGLY)  
 DESIGNED: \_\_\_\_\_  
 DRAWN: \_\_\_\_\_  
 CHECKED: \_\_\_\_\_  
 APPROVED: \_\_\_\_\_

**OWNER:**  
 CITY OF LAKE OSWEGO  
 380 A AVENUE  
 LAKE OSWEGO, OR 97034  
 PHONE: 503-635-0270



LAKE OSWEGO AND TIGARD WATER TREATMENT PLANT  
 DESIGN REVIEW AND CONDITIONAL USE  
**CHEMICAL BUILDING ELEVATIONS II**

FILENAME
PROJECT NUMBER
SCALE AS SHOWN
DRAWING/FIGURE NUMBER
<b>10.8</b>
OF

PLOT DATE: January 10, 2012 - 5:11 PM USER: nrsabb FILE: P:\2011\22.00 Lake Oswego WTP\0-drawings\04 CADD\04-elev\CHEMICAL\_BLDG\_2.dwg

**PLANT LEGEND**

**TREES**

- EXISTING TREE TO REMAIN
- 39 LARGE DECIDUOUS TREE
- 10 ALNUS RUBRA - RED ALDER
- 10 ACER MACROPHYLLUM - BIG LEAF MAPLE
- 19 QUERCUS GARRYANA - OREGON WHITE OAK
- 61 MEDIUM DECIDUOUS TREE
- 25 RHAMNUS PURSHIANA - CASCARA
- 36 CORNUS KOUSA 'MISS SATOMI' - RED FLOWERING KOUSA DOGWOOD
- 58 CONIFEROUS SCREENING TREE
- 7 CALOCEDRUS DECURRENS - INCENSE CEDAR
- 15 PSEUDOTSUGA MENZIESII - DOUG FIR
- 15 THUJA PLICATA 'HOGAN' - HOGAN CEDAR
- 21 THUJA PLICATA - WESTERN RED CEDAR
- 48 MEDIUM ACCENT TREE
- AMELANCHIER ALNFOLIA 'AUTUMN BRILLIANCE' - AUTUMN BRILLIANCE SERVICE BERRY
- 102 SMALL DECIDUOUS TREE
- 60 ACER CIRCINATUM - VINE MAPLE
- 42 CERCIS CANADENSIS - EASTERN REDBUD

1-5  
12.6

**SHRUBS/GRASSES/  
GROUNDCOVERS**

- QTY.% | STORMWATER FACILITY PLANTING
- 25% (3,442) CAREX OBNUPTA - SLOUGH SEDGE - 1.5' O.C.
- 25% (3,442) JUNCUS PATENS - SPREADING RUSH - 1.5' O.C.
- 25% (3,442) SCIRPUS MICROCARPUS - SMALL FRUITED BULLRUSH - 1.5' O.C.
- 10% (776) GAULTHERIA SHALLON - SALAL - 2' O.C.
- 5% (388) MAHONIA REPENS - CREEPING MAHONIA - 2' O.C.
- 10% (353) POLYSTICHUM MUNITUM - SWORD FERN - 3' O.C.
- QTY.% | MEADOW SEED MIX
- 10% BROMUS CARINATUS - CALIFORNIA BROME
- 10% ELYMUS ELYMODIES - SLENDER WHEATGRASS
- 15% FESTUCA OCCIDENTALLIS - WESTERN FESCUE
- 15% KOELERIA CRISTATA - PRAIRIE JUNEGRASS
- 5% LOTUS PURSHIANUS - SPANISH CLOVER
- 5% CLARKIA UNGUICULATA - ELEGANT CLARKIA
- 10% LUPINUS ALBACULUS - SICKLE KEELED LUPINE
- 5% ESCHSCHOLZIA CALIFORNICA - CALIFORNIA POPPY
- 10% GAILLARDIA ARISTATA - GAILLARDIA
- 15% NARCISSUS PSEUDONARCISSUS - WILD DAFFODIL
- QTY.% | FOREST RESTORATION AREA (INVASIVE REMOVAL & NATIVE SHRUB SEEDING )
- 20% SYMPOCARPUS ALBA - SNOWBERRY
- 20% ARCTOSTAPHYLOS UVA-URSI - BEARBERRY
- 5% ROSA NUTKANA - NUTKANA ROSE
- 20% SAMBUCUS RACEMOSA - RED ELDERBERRY
- 20% HOLIDISCUS DISCOLOR - OCEAN SPRAY
- 15% CORNUS STOLONIFERA SERICA - RED OSIER DOGWOOD
- GREEN ROOF PLANTING MIX
- MEADOW MIX WITH SEDUM VARIETIES
- GRASS PAVERS

2,3  
12.5

3,4  
12.6

**PLANTING PLAN NOTES**

- ALL NEW PLANTING AREAS SHALL BE IRRIGATED UTILIZING AN FULLY AUTOMATIC UNDERGROUND IRRIGATION SYSTEM. IRRIGATION SYSTEM SHALL INCORPORATE A SMART CONTROLLER, IN COMBINATION WITH LOW PRECIPITATION SPRAY HEADS. IRRIGATION INTENT IS TO PROVIDE SUFFICIENT WATER TO ESTABLISH NEW PLANTINGS WITHIN THE FIRST TWO YEARS, AND THEN SLOWLY DECREASE WATERING, LIMITED TO DRY MONTHS, OR PERIODS OF DROUGHT THE FOLLOWING (3) YEARS.
- CONTRACTOR SHALL PROVIDE TOPSOIL, SOIL AMENDMENTS AND MULCH AS SPECIFIED.
- ALL PLANTS SHALL BE INSTALLED IN ACCORDANCE WITH THE DETAILS AND SPECIFICATIONS PROVIDED AS PART OF THE CONSTRUCTION DOCUMENT PACKAGE.
- QUANTITIES ARE LISTED FOR THE CONTRACTOR'S CONVENIENCE ONLY. ALL COUNTS MUST BE VERIFIED BY THE CONTRACTOR. IN THE CASE OF A DISCREPANCY BETWEEN THE LEGEND AND THE PLAN, PLANTS INDICATED ON THE PLAN SHALL SUPERCEDE QUANTITIES LISTED IN THE LEGEND.

**IRRIGATION LEGEND**

**IRRIGATION HEADS**

SYMBOL	DESCRIPTION	MANUFACTURER	MODEL NO.	PSI	RAD.	GPM
	SPRAY ROTARY NOZZLE	HUNTER	MP-1000	40	8' - 15'	.19 - .75
	SPRAY ROTARY NOZZLE	HUNTER	MP-2000	40	13' - 21'	.4 - 1.47
	SPRAY ROTARY NOZZLE	HUNTER	MP-3000	40	22' - 30'	.86 - 3.64
	FIXED SPRAY HEAD	HUNTER	PROSPRAY - 8A	30	VARIES	
	DRIPLINE - DRIP ZONE	RAINBIRD	LD-09-12-100	NA	NA	NA

1  
13.4

2-5  
13.5

**IRRIGATION EQUIPMENT**


- REMOTE CONTROL VALVE - RAINBIRD PESB-R
- DRIP ZONE CONTROL KIT - RAINBIRD XCZ-150-PRB-COM
- FLUSH VALVE
- AIR VACUUM RELIEF VALVE
- QUICK COUPLER
- GATE VALVE
- BACKFLOW PREVENTION DEVICE
- IRRIGATION CONTROLLER - HUNTER ICC W/ SOLAR SYNC MODULE
- MANUAL DRAIN VALVE

2-5  
13.4

1,6  
13.5

- IRRIGATION LATERAL LINE
- IRRIGATION LATERAL LINE / ZONE CONNECTION
- 2" - IRRIGATION MAIN LINE
- IRRIGATION SLEEVE

**CONTROL VALVE TARGET**

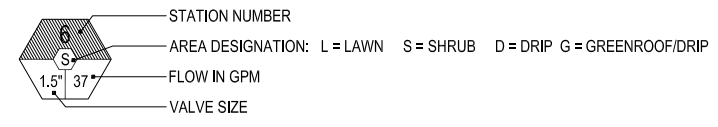

**IRRIGATION PLAN NOTES**

- CALL UTILITIES TO LOCATE EXISTING SERVICES PRIOR TO EXCAVATION.
- SYSTEM OPERATION AND DESIGN IS BASED ON 50 POUNDS OF PRESSURE AND 50 GALLONS PER MINUTE AT THE SHUTOFF VALVE. THE CONTRACTOR SHALL VERIFY THE DESIGN PRESSURE AND VOLUME BEFORE INSTALLATION AND NOTIFY OWNER IF THERE IS A DISCREPANCY.
- CONTRACTOR SHALL REFERENCE PLANTING PLAN(S) PRIOR TO INSTALLATION OF VALVES. LOCATE VALVES IN PLANTING BEDS WHEREVER POSSIBLE. ADJUST VALVE LOCATIONS TO ELIMINATE CONFLICT WITH PROPOSED PLANTINGS AND PLANTING PATTERNS.
- VALVE LOCATIONS SHALL BE STAKED BY THE CONTRACTOR AND APPROVED BY THE OWNER'S REPRESENTATIVE PRIOR TO INSTALLATION OF NEW IRRIGATION SYSTEM.
- THE CONTRACTOR SHALL VERIFY THE DIMENSIONS AND LAYOUT OF ALL NEW PLANTING AND LAWN AREAS ON SITE BEFORE STARTING WORK AND IMMEDIATELY NOTIFY OWNER OF ANY DEVIATIONS FROM PLAN.
- NEW TREE LOCATIONS SHALL BE STAKED BY THE CONTRACTOR AND APPROVED BY THE OWNER'S REPRESENTATIVE PRIOR TO INSTALLATION OF NEW IRRIGATION SYSTEM.
- THE CONTRACTOR SHALL INSTALL QUICK COUPLING VALVES A MINIMUM OF 200' ALONG MAINLINE AND AS SHOWN ON PLANS AND DETAILS.
- THE CONTRACTOR SHALL INSTALL THE IRRIGATION CONTROLLER(S) AT THE LOCATION(S) SHOWN ON THE DRAWINGS, ON THE SPECIFIED PEDESTAL PER THE MANUFACTURER'S RECOMMENDATIONS. THE CONTRACTOR SHALL VERIFY THE LOCATION WITH THE OWNER PRIOR TO INSTALLATION. THE CONTRACTOR SHALL EXTEND CONTROL WIRE CONDUIT FROM CONTROLLER AND DAYLIGHT SIX INCHES INTO PLANTING BED FOR INSTALLATION OF AUTOMATIC VALVE WIRES.
- ALL BACKFLOW PREVENTION DEVICES SHALL BE LOCATED A MINIMUM OF 5'-0" AWAY FROM CURBS OR PAVING WHEREVER POSSIBLE.
- MAIN AND LATERAL LINES MAY BE SHOWN DIAGRAMMATICALLY FOR CLARITY. MAIN AND LATERAL LINES SHOWN IN PAVED AREAS SHALL BE PLACED IN ADJACENT PLANTING BEDS UNLESS SPECIFICALLY SHOWN AS PASSING UNDER PAVING IN SLEEVE (SEE LEGEND FOR SLEEVE SYMBOL). THE CONTRACTOR MUST OBTAIN THE LANDSCAPE ARCHITECT'S APPROVAL BEFORE MAKING CHANGES IN ROUTING OF PIPE OR LOCATION OF VALVES.
- THE CONTRACTOR IS RESPONSIBLE FOR COORDINATING AND PROVIDING AN APPROPRIATE POWER SUPPLY TO THE IRRIGATION CONTROLLER LOCATION.
- COORDINATE WATER SOURCE, BACKFLOW PREVENTION, AND ROOF PENETRATIONS FOR IRRIGATION / WATER SUPPLY TO GREENROOF LOCATIONS.



LINE IS 2 INCHES  
AT FULL SIZE  
(IF NOT 2" - SCALE ACCORDINGLY)

DESIGNED: JB  
DRAWN: DD  
CHECKED: JB  
CHECKED: RT  
APPROVED: MF

NO.	DESCRIPTION	BY	APP.
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3	LOWTP_1_TREE.dwg		
4	LOWTP_1_IRRIG_BASE.dwg		
5	LOWTP_1_irrig_model.dwg		
6	45817RWTP.dwg		
7	W01424-BORDER.dwg		

**OWNER:**  
CITY OF LAKE OSWEGO  
380 A AVENUE  
LAKE OSWEGO, OR 97034  
PHONE: 503-635-0270



LAKE OSWEGO AND TIGARD WATER TREATMENT PLANT

DESIGN REVIEW AND CONDITIONAL USE

**GENERAL LEGENDS & NOTES**

**PLANTING & IRRIGATION**




FILENAME	
PROJECT NUMBER	
SCALE	NTS
DRAWING/FIGURE NUMBER	11.0
	48 OF

PLOT DATE: January 10, 2012 - 7:22PM  
FILE: C:\pwwork\cdms5316\LOWTP-GL-11.0.dwg

GENERAL SHEET NOTES

- SEE FIGURE 11.0 FOR PLANTING LEGEND AND NOTES.

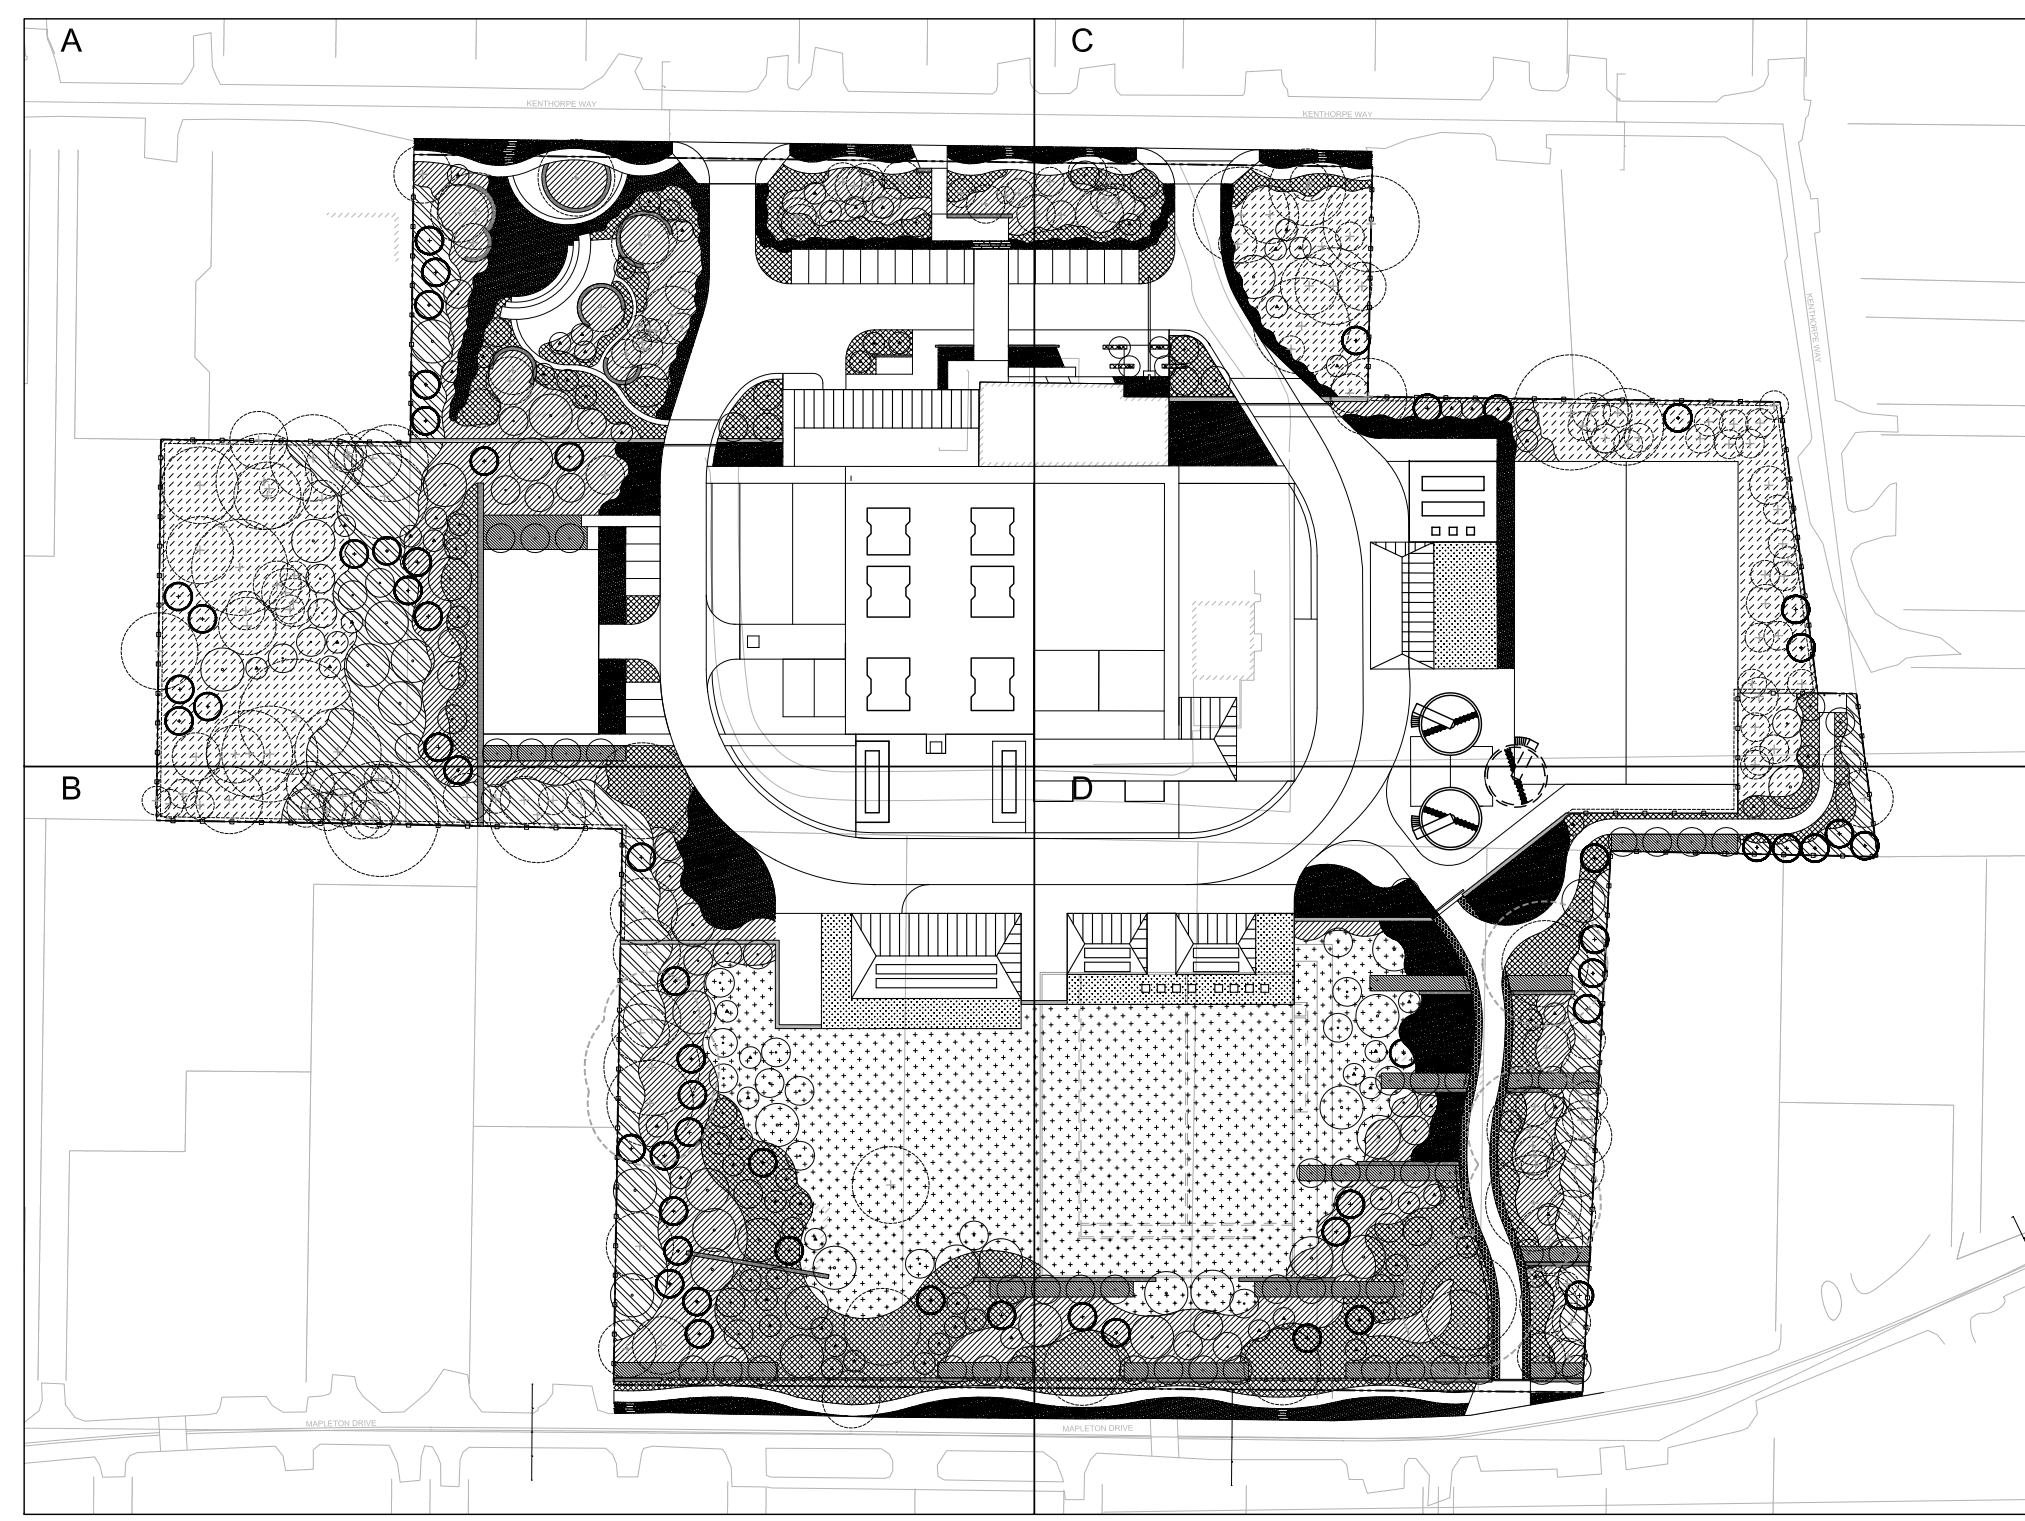

LINE IS 2 INCHES  
AT FULL SIZE  
(IF NOT 2" - SCALE ACCORDINGLY)

DESIGNED: JB  
DRAWN: DD  
CHECKED: JB  
CHECKED: RT  
APPROVED: MF

REVISIONS				
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5	GW_LIGO SQUARE.dwg			
6	LOWTP_L_PLANT_BASE.dwg			
7	LOWTP_L_TREE.dwg			
8	LOWTP_fence_model.dwg			
9	LOWTP_L_DESIGN_BASE_cad_2004.dwg			
10	W01424-BORDER.dwg			

OWNER:  
CITY OF LAKE OSWEGO  
380 A AVENUE  
LAKE OSWEGO, OR 97034  
PHONE: 503-635-0270




LAKE OSWEGO AND TIGARD WATER TREATMENT PLANT  
DESIGN REVIEW AND CONDITIONAL USE  
**PLANTING PLAN  
OVERVIEW**



FILENAME	
PROJECT NUMBER	
SCALE	1" = 50'
DRAWING/FIGURE NUMBER	12.0
	47 OF

PLOT DATE: January 10, 2012 - 7:44PM USER: jrb FILE: C:\pwwork\cdms55316\LOWTP-GL-12.0.dwg

PLOT DATE: January 10, 2012 - 6:44PM USER: mhB  
 FILE: C:\pwwork\dm55316\LOWTP-A-12.1.dwg

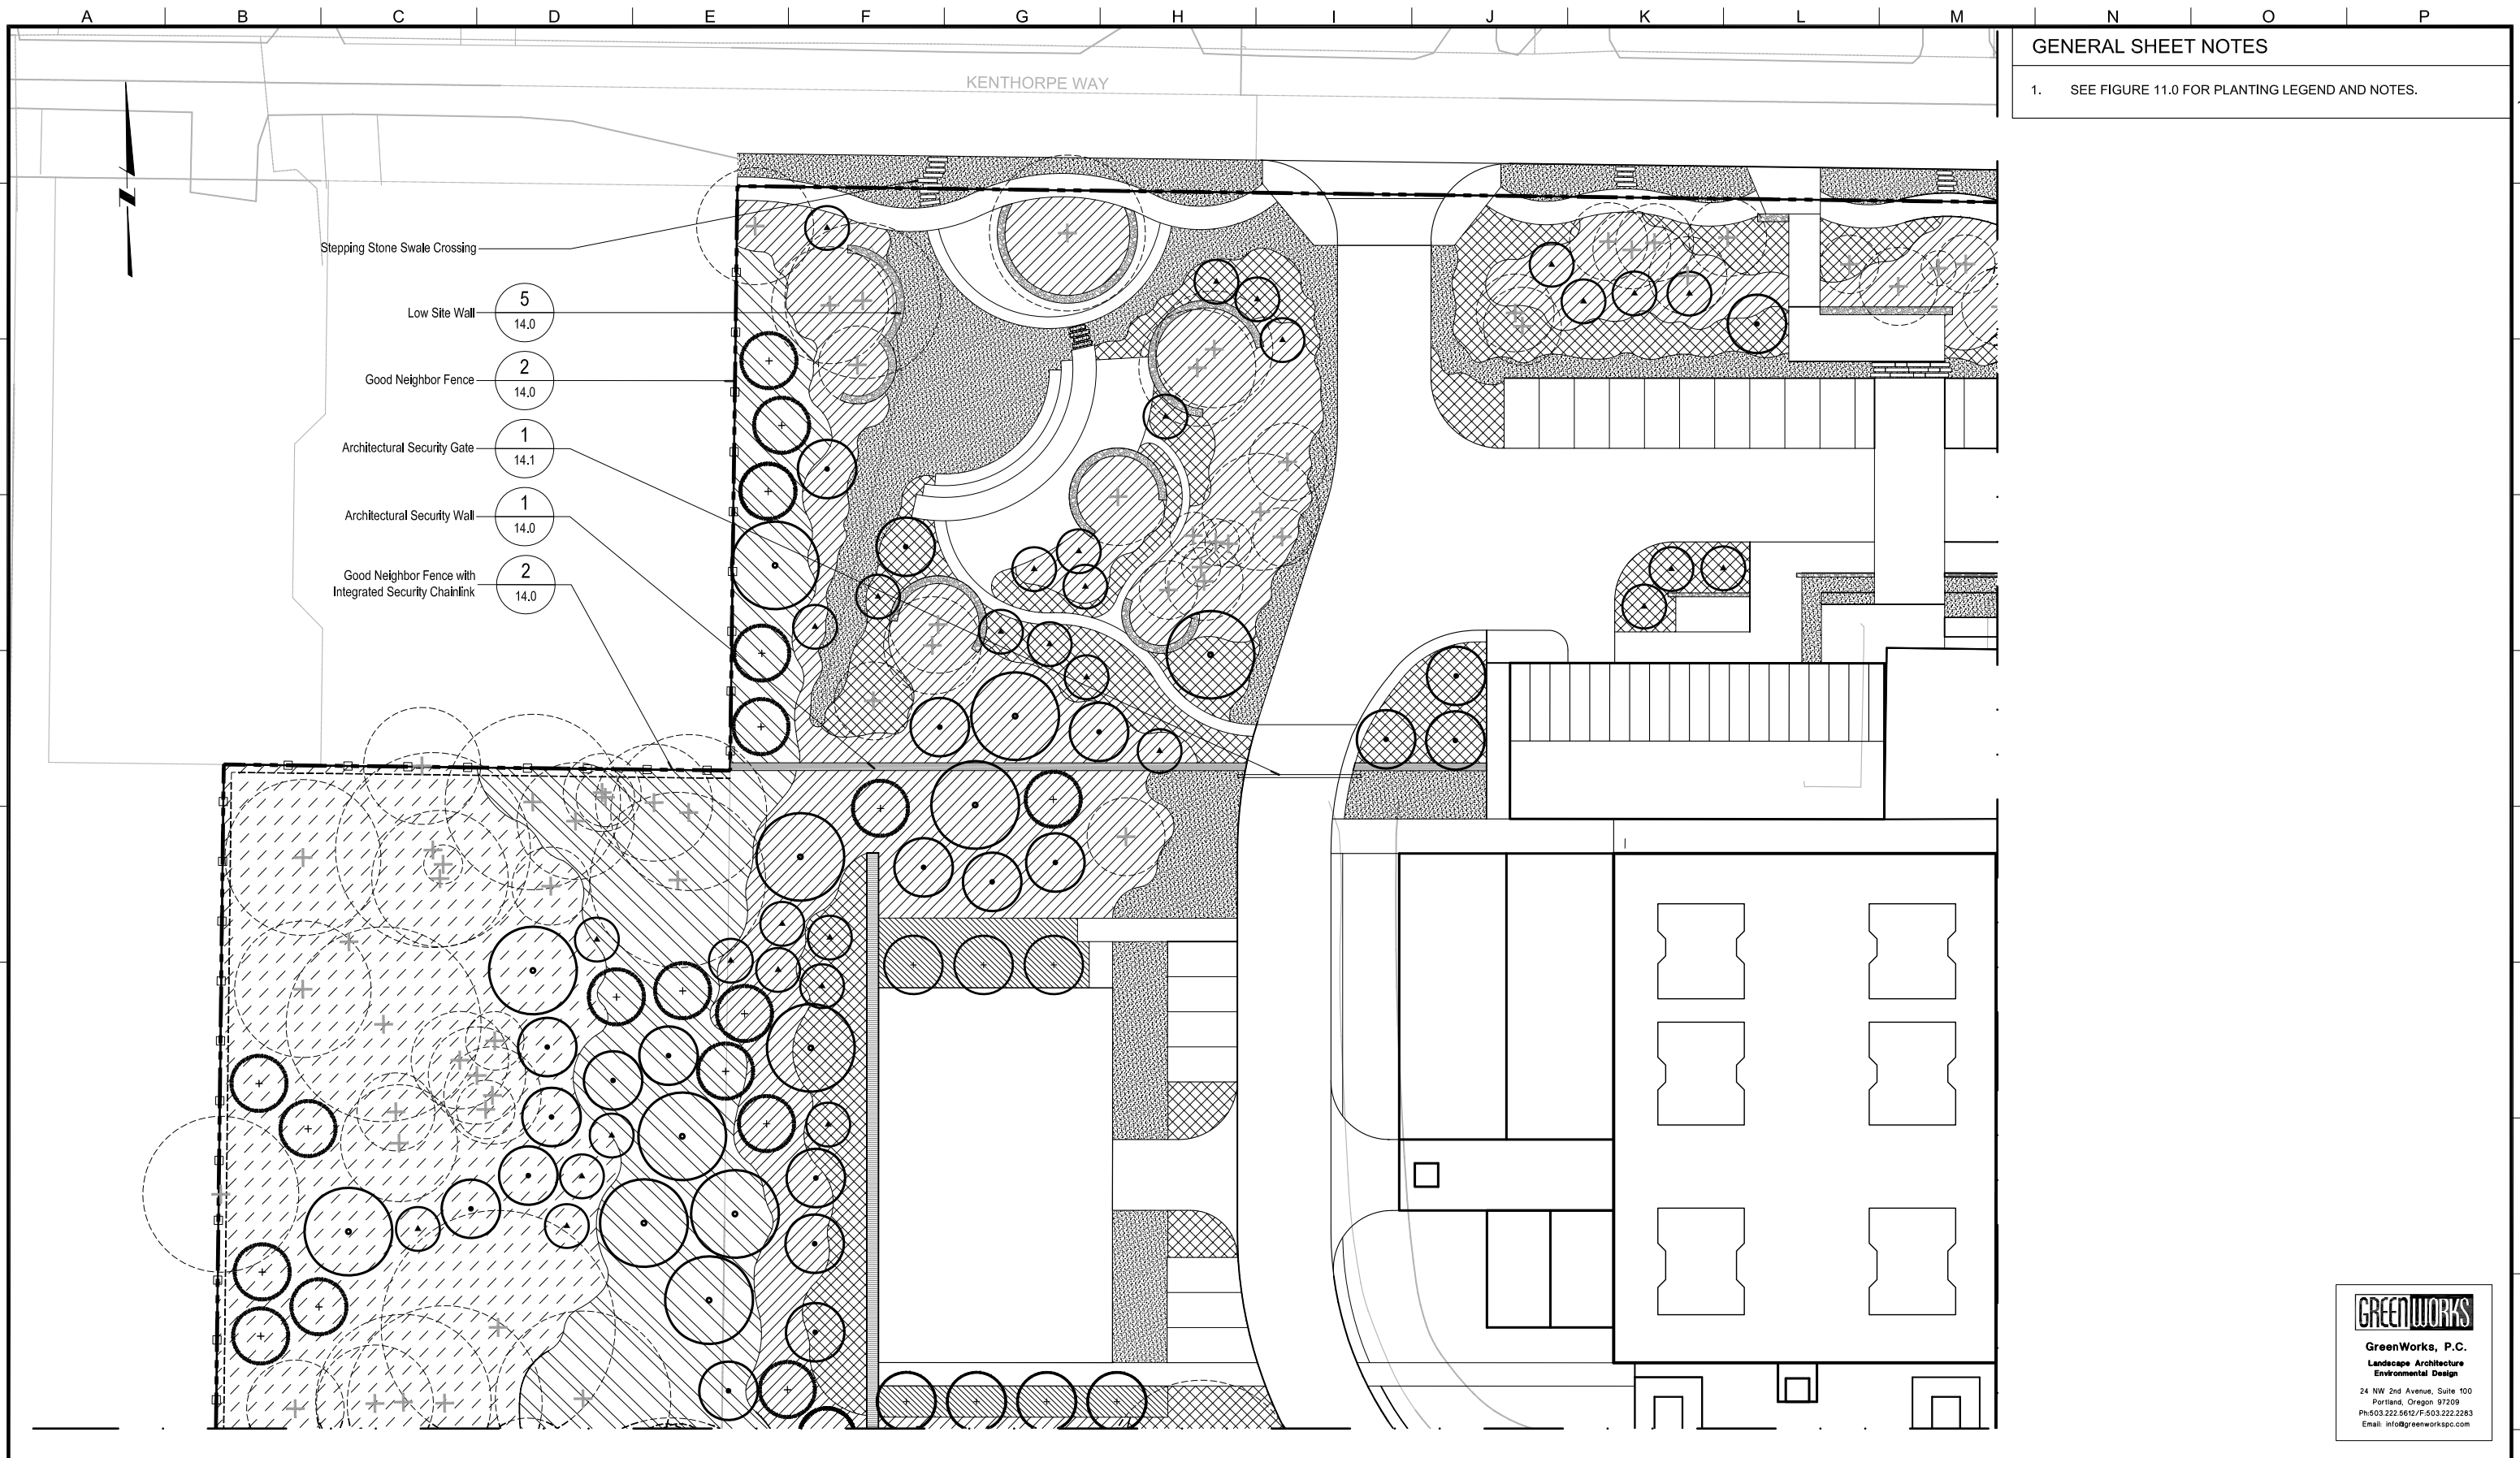

**GENERAL SHEET NOTES**

1. SEE FIGURE 11.0 FOR PLANTING LEGEND AND NOTES.

- Stepping Stone Swale Crossing
- Low Site Wall 5  
14.0
- Good Neighbor Fence 2  
14.0
- Architectural Security Gate 1  
14.1
- Architectural Security Wall 1  
14.0
- Good Neighbor Fence with Integrated Security Chainlink 2  
14.0



LINE IS 2 INCHES  
AT FULL SIZE  
(IF NOT 2" - SCALE ACCORDINGLY)

DESIGNED: JB  
DRAWN: DD  
CHECKED: JB  
CHECKED: RT  
APPROVED: MF

REVISIONS			
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5	LOWTP_L_PLANT_BASE.dwg		
6	LOWTP_L_TREE.dwg		
7	LOWTP_fence_model.dwg		
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9	W01424-BORDER.dwg		

**OWNER:**  
CITY OF LAKE OSWEGO  
380 A AVENUE  
LAKE OSWEGO, OR 97034  
PHONE: 503-635-0270




LAKE OSWEGO AND TIGARD WATER TREATMENT PLANT  
DESIGN REVIEW AND CONDITIONAL USE  
**PLANTING PLAN  
AREA A**



FILENAME	
PROJECT NUMBER	
SCALE	1" = 20'
DRAWING/FIGURE NUMBER	12.1
	48 OF

**GENERAL SHEET NOTES**  
 1. SEE FIGURE 11.0 FOR PLANTING LEGEND AND NOTES.

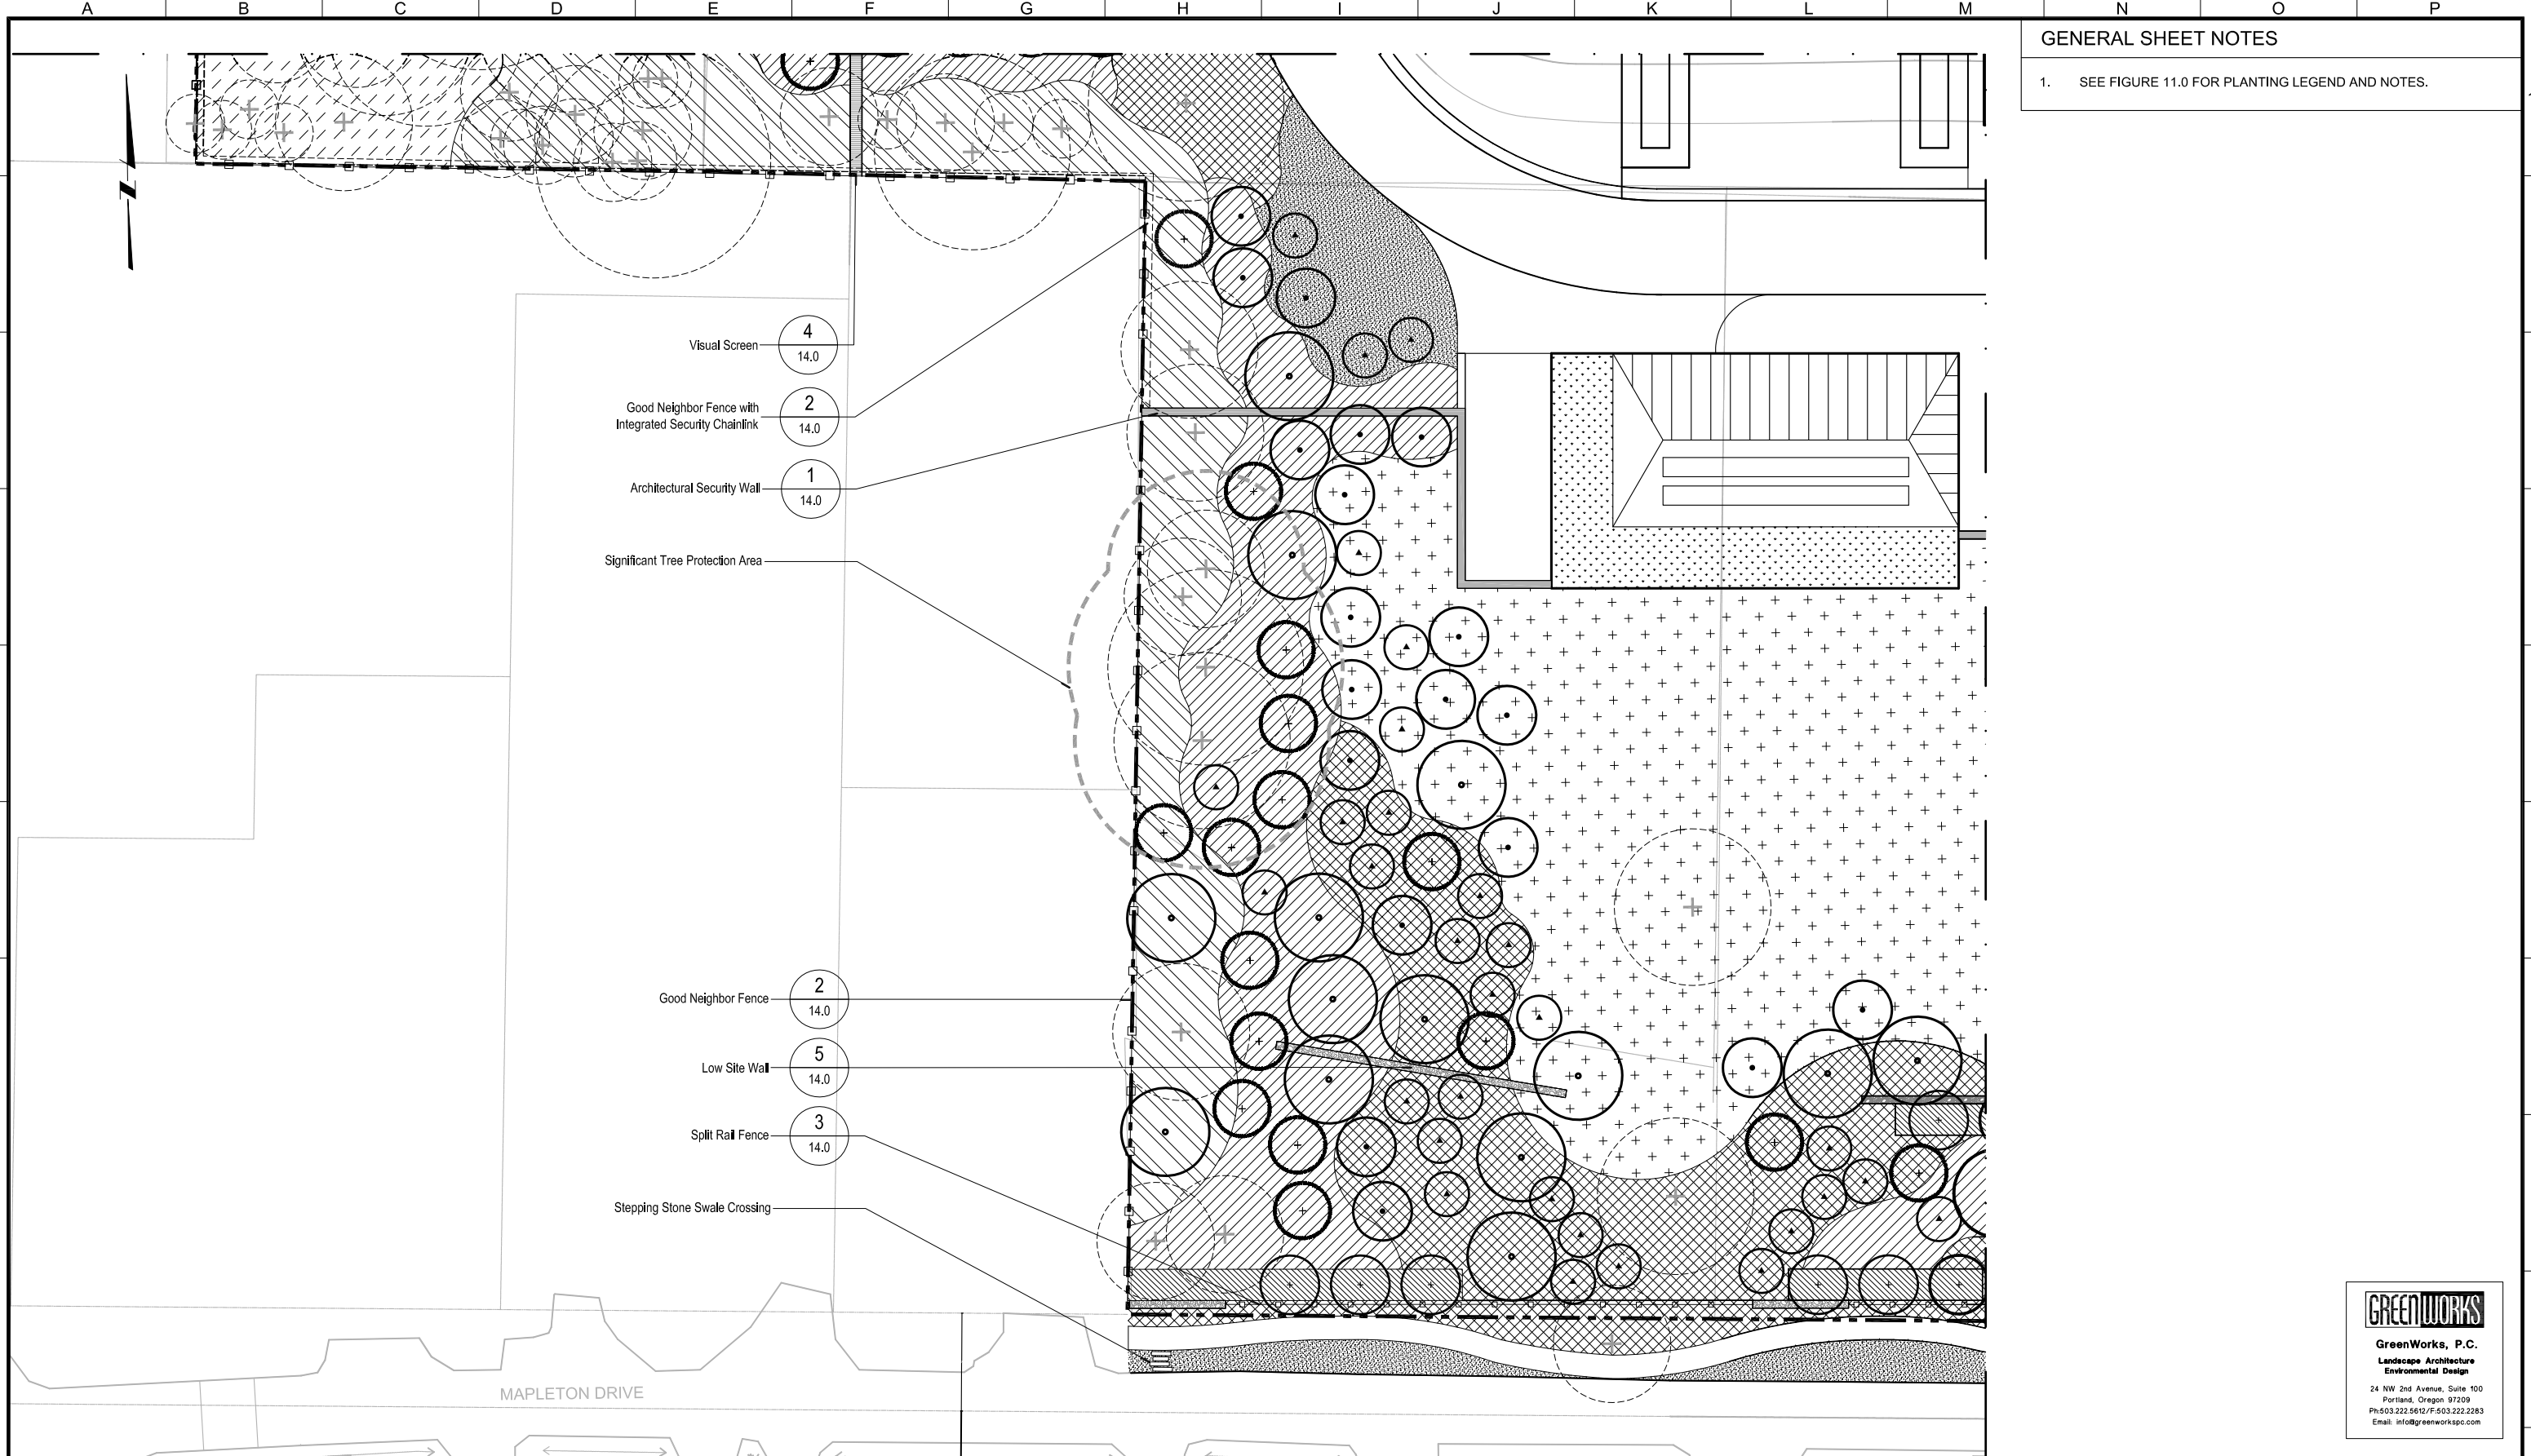

MAPLETON DRIVE



LINE IS 2 INCHES  
 AT FULL SIZE  
 (IF NOT 2" - SCALE ACCORDINGLY)

DESIGNED: JB  
 DRAWN: DD  
 CHECKED: JB  
 CHECKED: RT  
 APPROVED: MF

REVISIONS			
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4	GW LOGO SQUARE DWG		
5	LOWTP - L DESIGN_BASE.dwg		
6	LOWTP - L PLANT_BASE.dwg		
7	45817RWTP2-TREE INVENTORY-BC-PTNOS.dwg		
8	LOWTP - L TREE.dwg		
9	LOWTP - fence_model.dwg		
10	LOWTP - L DESIGN_BASE_cad_2004.dwg		
11	W01424-BORDER.dwg		

**OWNER:**  
 CITY OF LAKE OSWEGO  
 380 A AVENUE  
 LAKE OSWEGO, OR 97034  
 PHONE: 503-635-0270




LAKE OSWEGO AND TIGARD WATER TREATMENT PLANT  
 DESIGN REVIEW AND CONDITIONAL USE  
**PLANTING PLAN  
 AREA B**

FILENAME	
PROJECT NUMBER	
SCALE	1" = 20'
DRAWING/FIGURE NUMBER	12.2
	49 OF

PLOT DATE: January 10, 2012 - 6:51 PM USER: mhB  
 FILE: C:\pwork\cdms55316\LOWTP-B-L-12.2.dwg

**GENERAL SHEET NOTES**  
 1. SEE FIGURE 11.0 FOR PLANTING LEGEND AND NOTES.

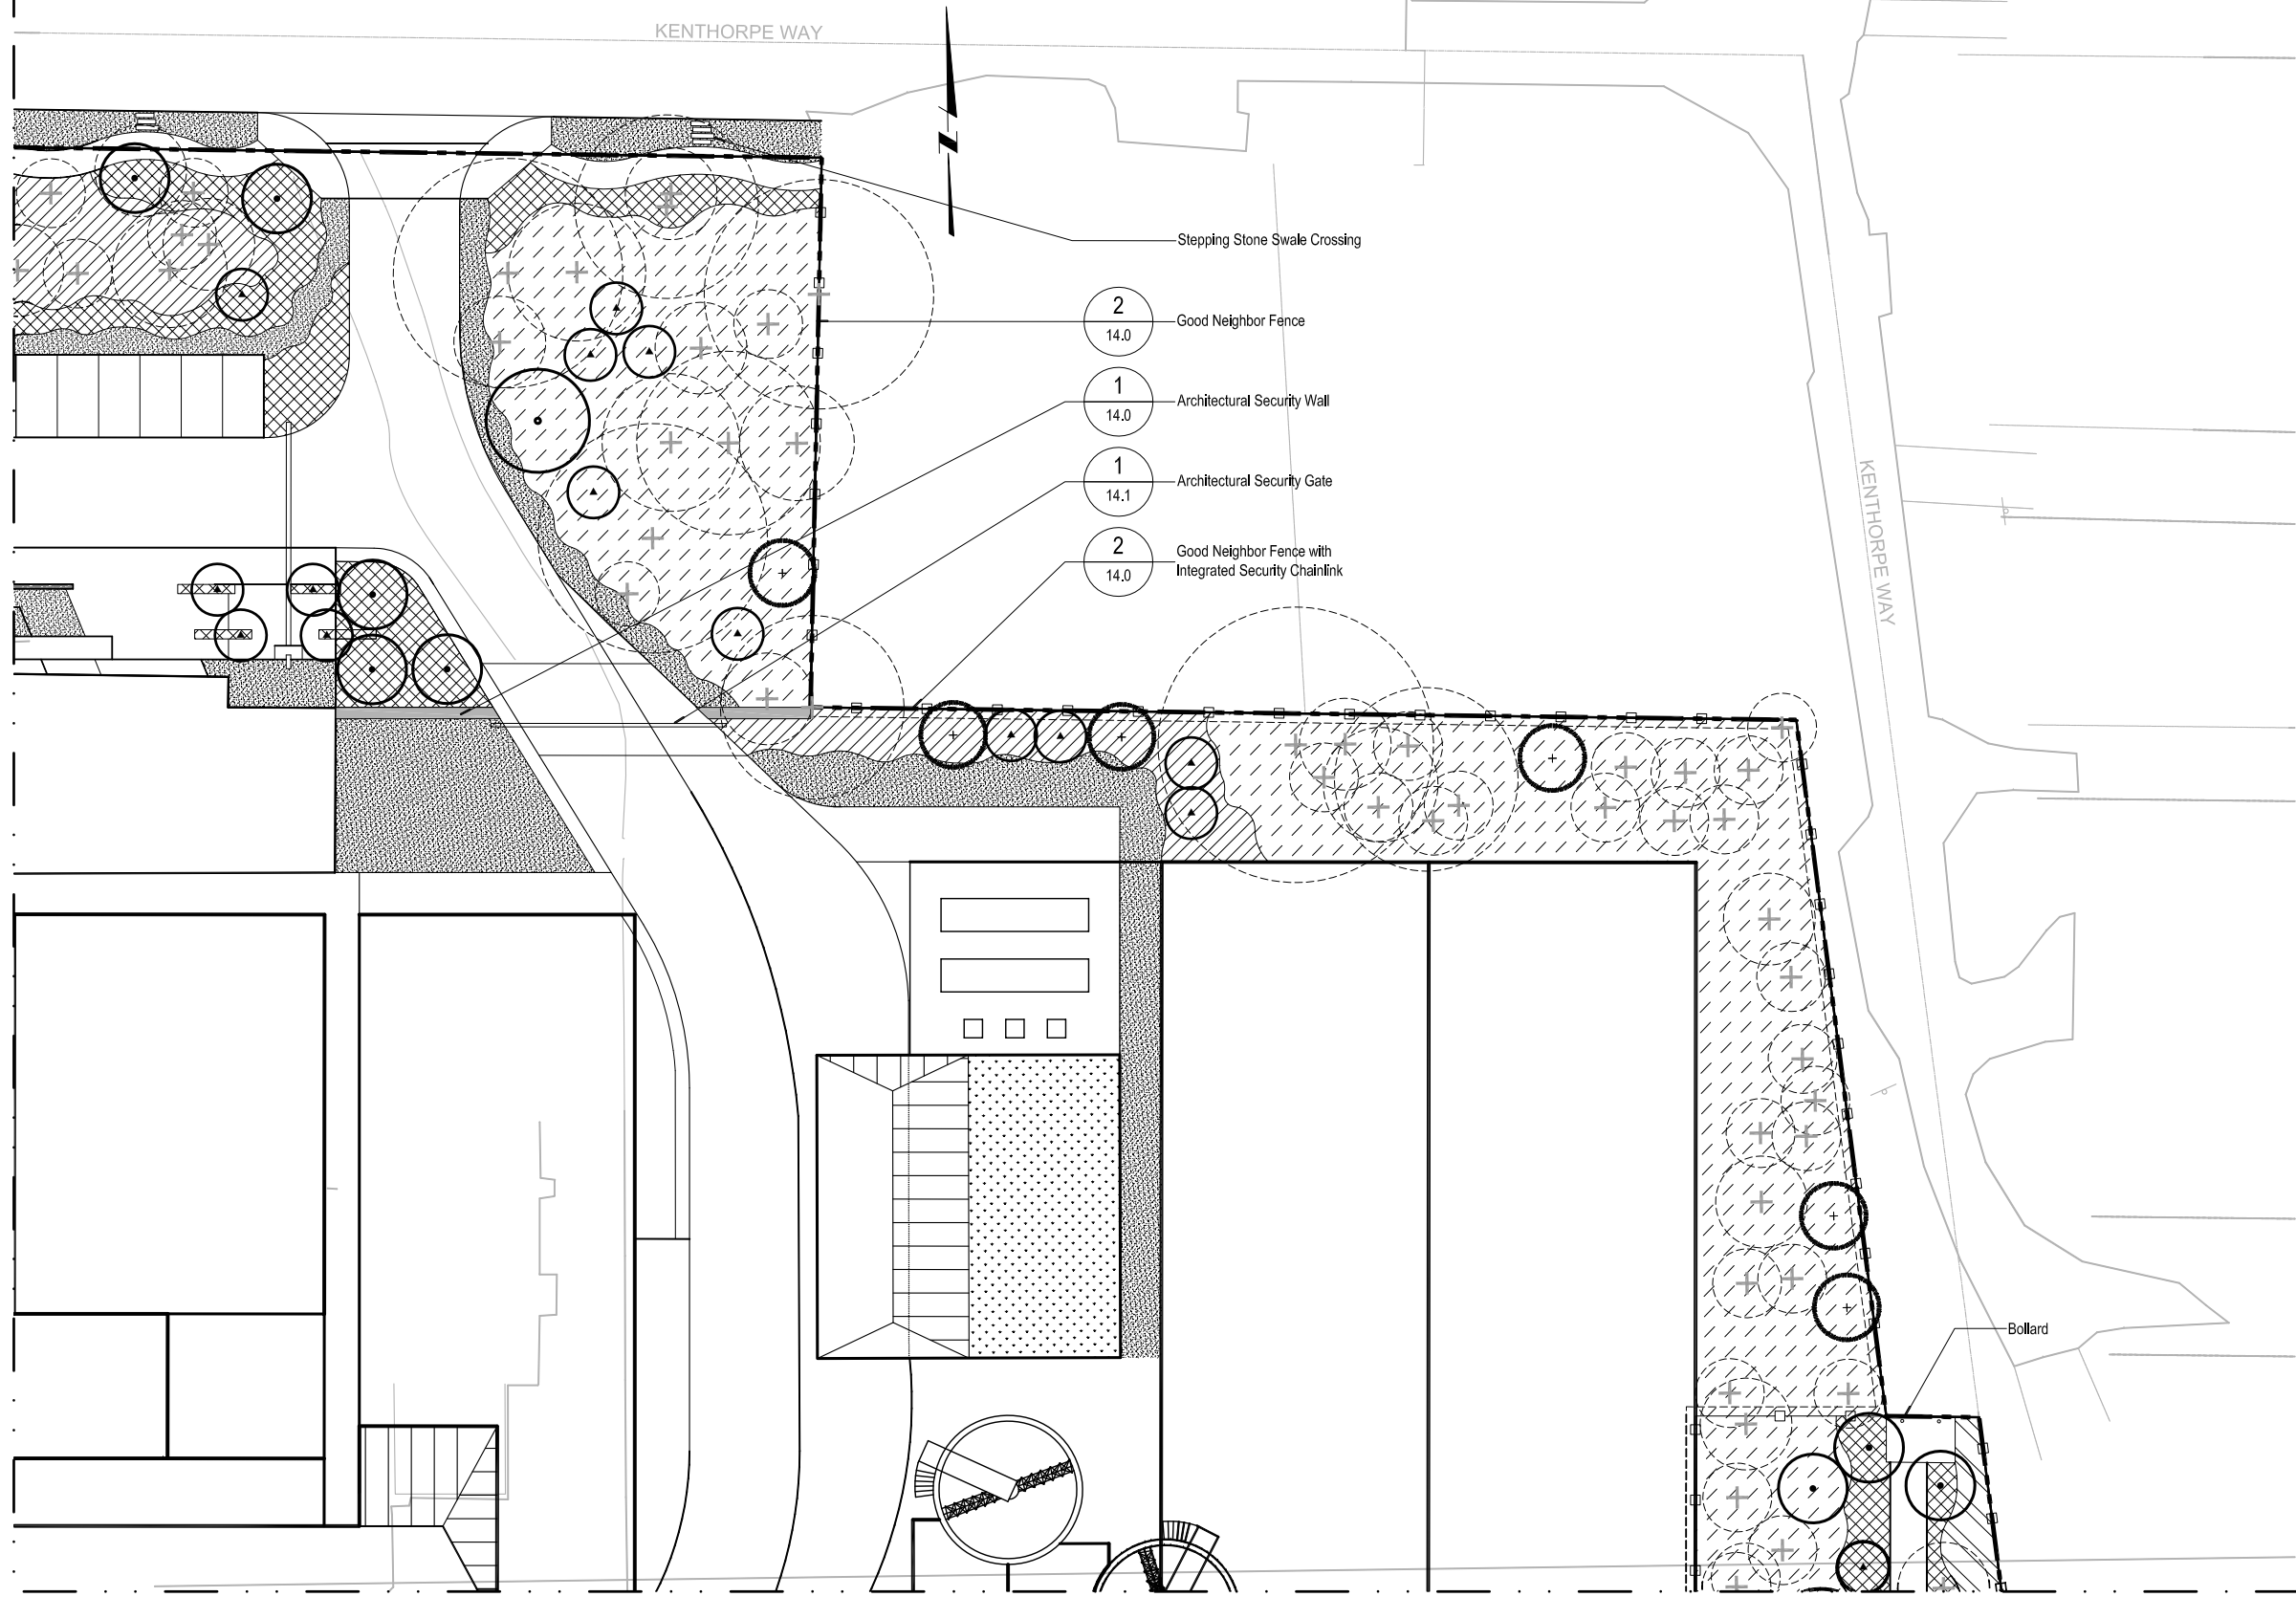

PLOT DATE: January 10, 2012 - 6:53PM USER: MFB  
 FILE: C:\pwwork\dm55316\LOWTF-C-12.3.dwg



LINE IS 2 INCHES  
 AT FULL SIZE  
 (IF NOT 2" - SCALE ACCORDINGLY)

DESIGNED: JB  
 DRAWN: DD  
 CHECKED: JB  
 CHECKED: RT  
 APPROVED: MF

REVISIONS			
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3	138558 - TITLE BLOCK FOR PERMITTING.dwg		
4	GW LOGO SQUARE.DWG		
5	LOWTF - DESIGN_BASE.dwg		
6	LOWTF - PLANT_BASE.dwg		
7	LOWTF - TREE.dwg		
8	LOWTF - fence_model.dwg		
9	LOWTF - DESIGN_BASE_cad_2004.dwg		
10	W01424-BORDER.dwg		

**OWNER:**  
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 380 A AVENUE  
 LAKE OSWEGO, OR 97034  
 PHONE: 503-635-0270



LAKE OSWEGO AND TIGARD WATER TREATMENT PLANT  
 DESIGN REVIEW AND CONDITIONAL USE  
**PLANTING PLAN**  
 AREA C




FILENAME	
PROJECT NUMBER	
SCALE	1" = 20'
DRAWING/FIGURE NUMBER	12.3
	50 OF



GENERAL SHEET NOTES

1. SEE FIGURE 11.0 FOR PLANTING LEGEND AND NOTES.

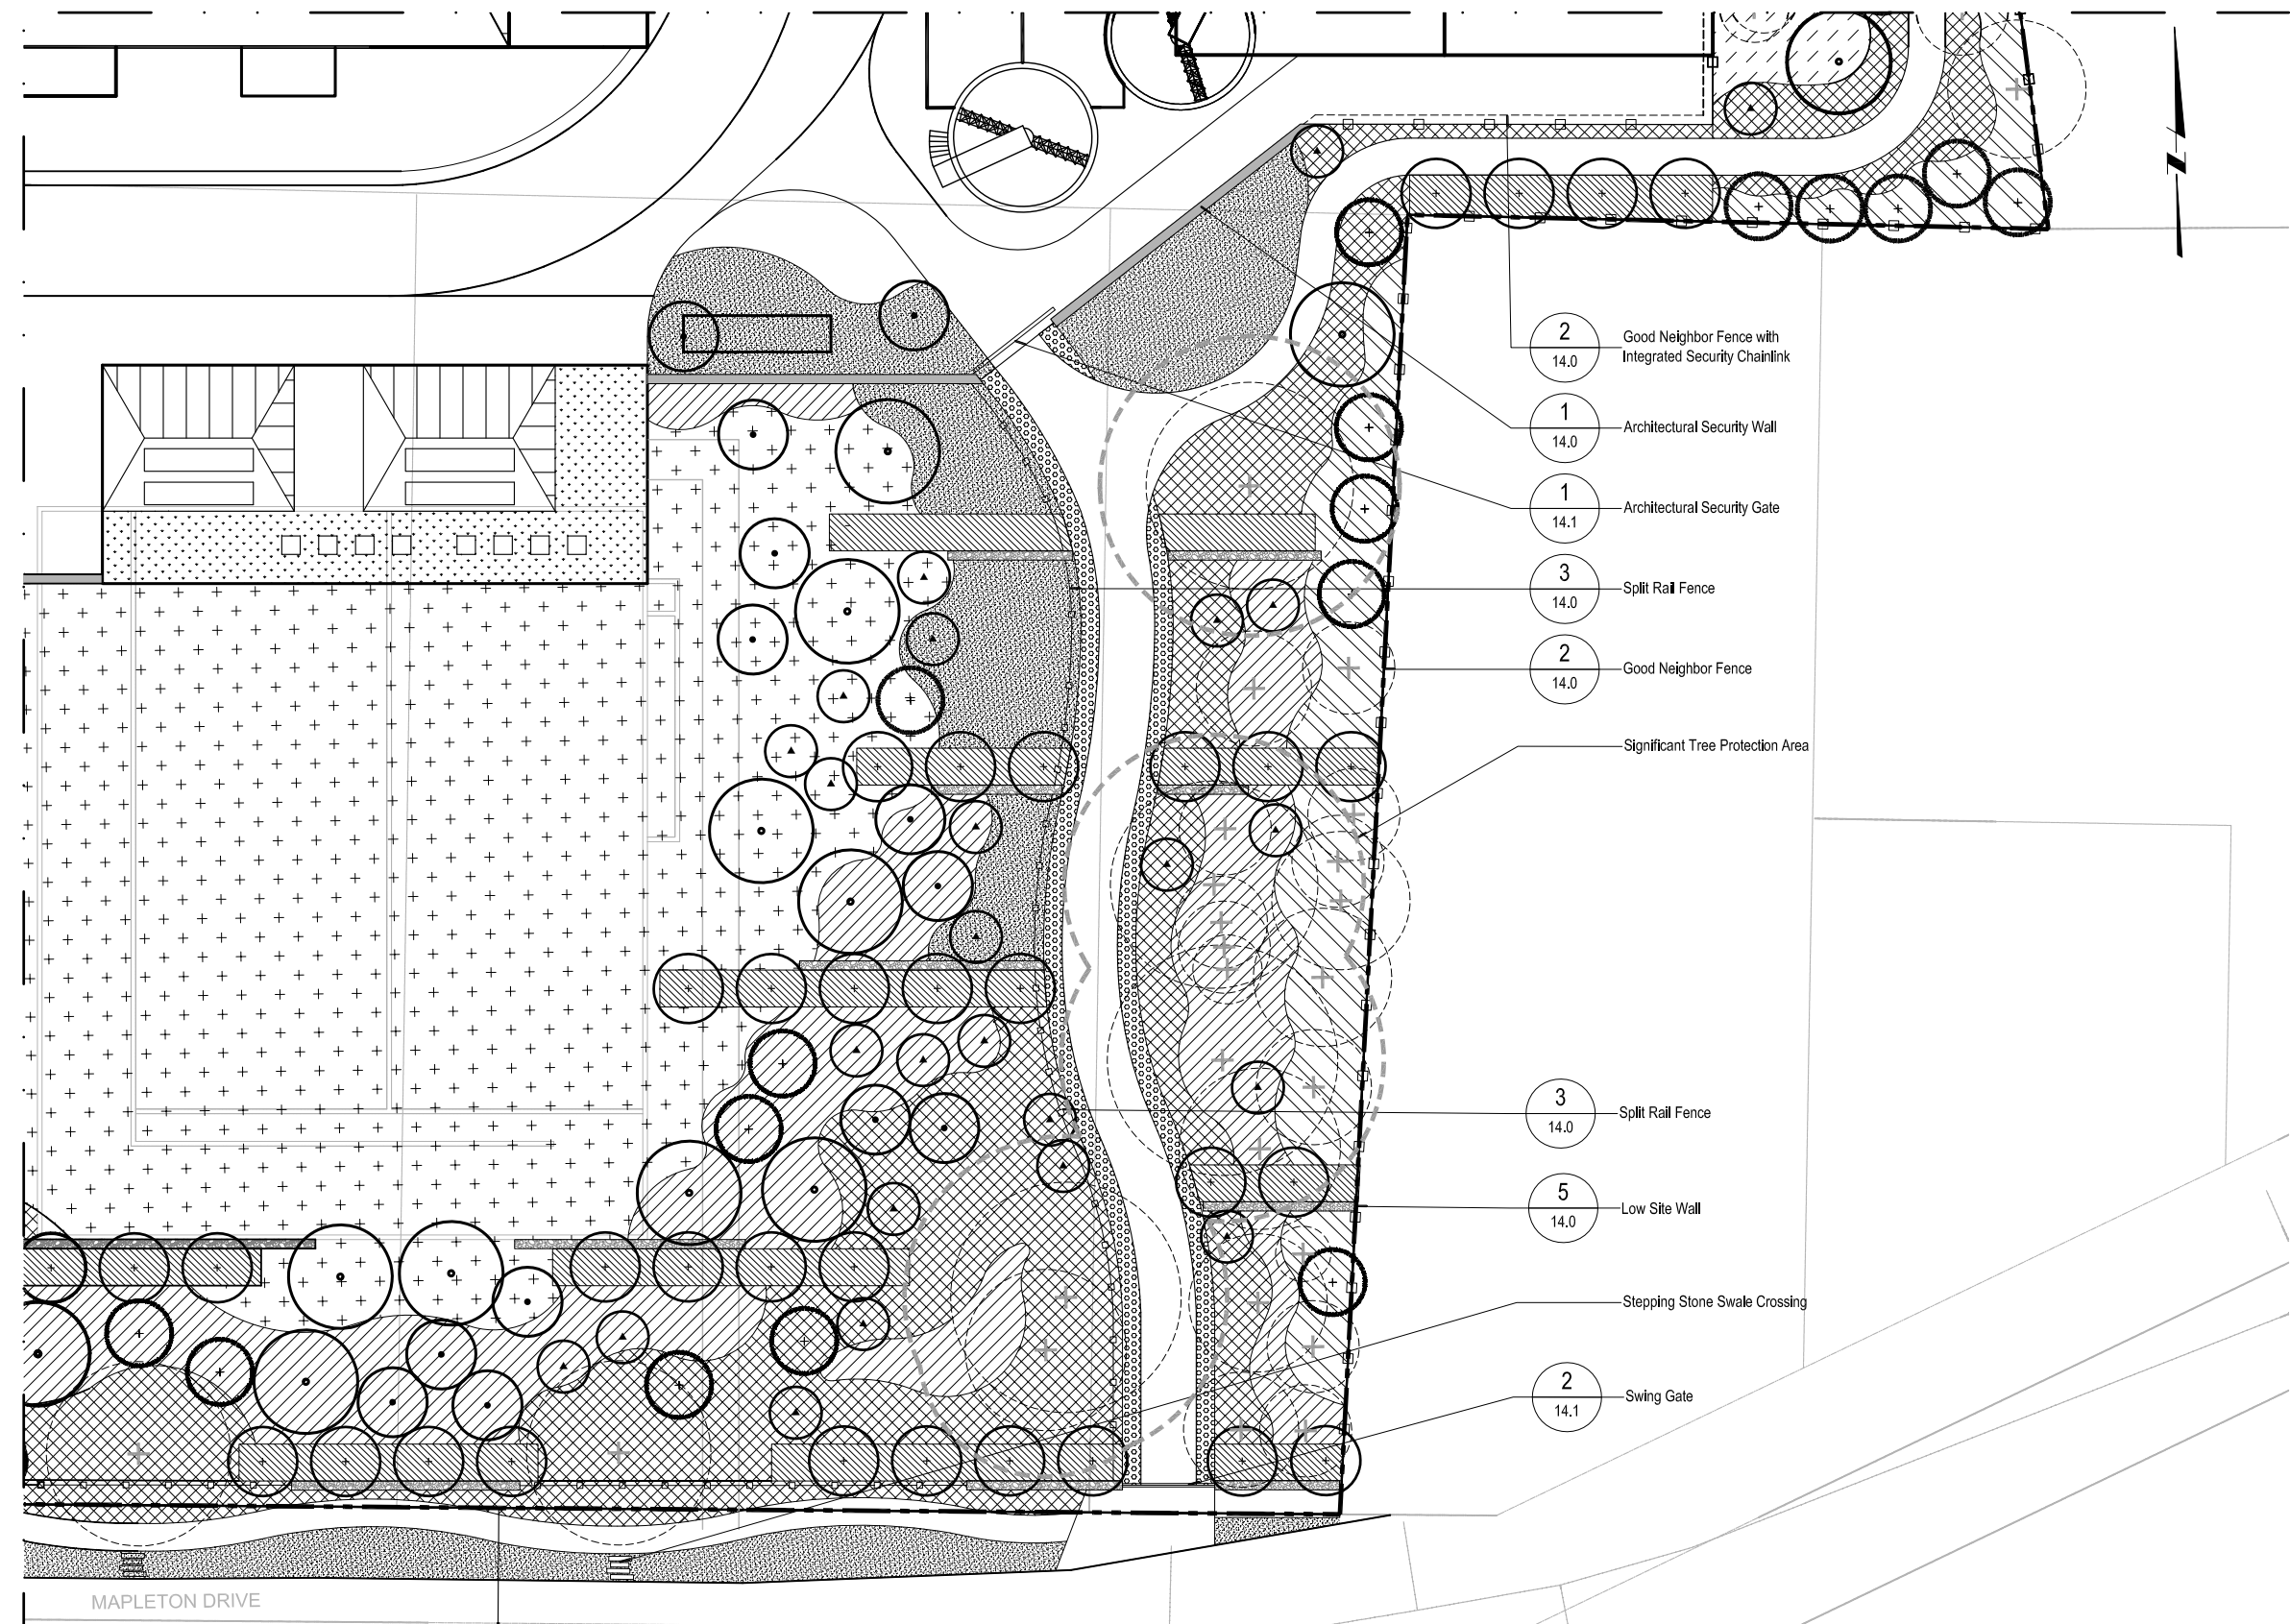

- 2  
14.0 Good Neighbor Fence with Integrated Security Chainlink
- 1  
14.0 Architectural Security Wall
- 1  
14.1 Architectural Security Gate
- 3  
14.0 Split Rail Fence
- 2  
14.0 Good Neighbor Fence
- Significant Tree Protection Area
- 3  
14.0 Split Rail Fence
- 5  
14.0 Low Site Wall
- Stepping Stone Swale Crossing
- 2  
14.1 Swing Gate

MAPLETON DRIVE

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 Email: info@greenworkspc.com

**MWH**  
 806 SW BROADWAY, SUITE 200  
 PORTLAND, OREGON 97205

LINE IS 2 INCHES  
 AT FULL SIZE  
 (IF NOT 2" - SCALE ACCORDINGLY)

DESIGNED: JB  
 DRAWN: DD  
 CHECKED: JB  
 CHECKED: RT  
 APPROVED: MF

REVISIONS			
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4	GW LOGO SQUARE.DWG		
5	LOWTP_L_DESIGN_BASE.dwg		
6	LOWTP_L_PLANT_BASE.dwg		
7	LOWTP_L_TREE.dwg		
8	LOWTP_fence_model.dwg		
9	LOWTP_L_DESIGN_BASE_cad_2004.dwg		
10	W01424-BORDER.dwg		


OWNER:  
 CITY OF LAKE OSWEGO  
 380 A AVENUE  
 LAKE OSWEGO, OR 97034  
 PHONE: 503-635-0270




LAKE OSWEGO AND TIGARD WATER TREATMENT PLANT  
 DESIGN REVIEW AND CONDITIONAL USE  
**PLANTING PLAN  
 AREA D**

FILENAME	
PROJECT NUMBER	
SCALE	1" = 20'
DRAWING/FIGURE NUMBER	12.4
51 OF	


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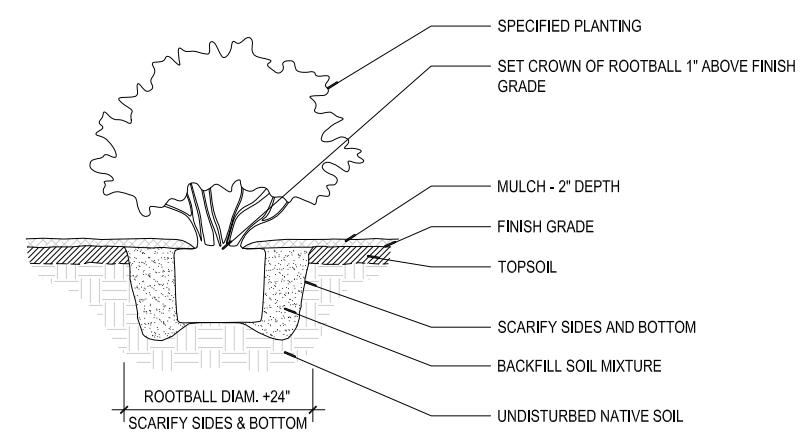
**1 DECIDUOUS TREE PLANTING - STAKING**  
SECTION  
0 6" 12" 24"

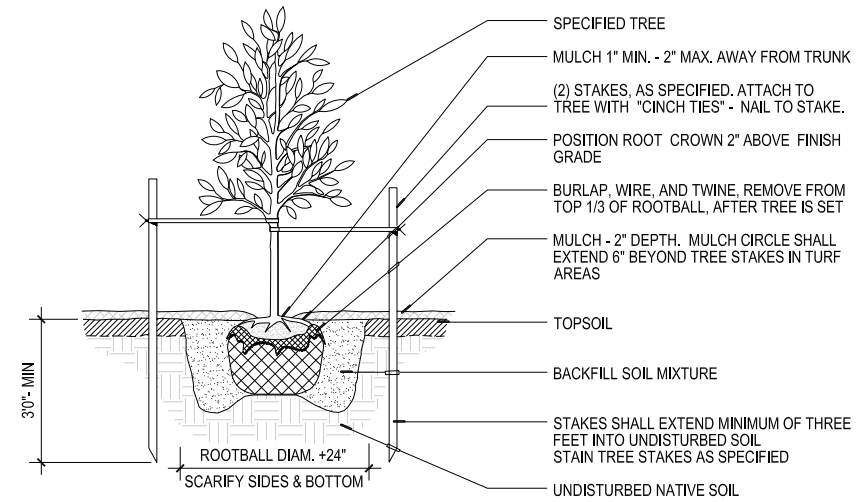


**2 CONIFER TREE PLANTING - STAKING**  
SECTION  
0 6" 12" 24"

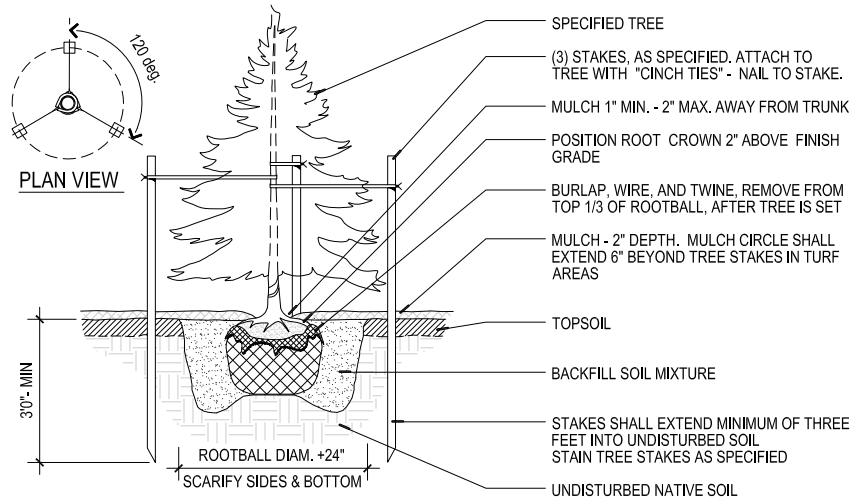


**3 NATIVE DECIDUOUS TREE PLANTING**  
SECTION  
NOT TO SCALE

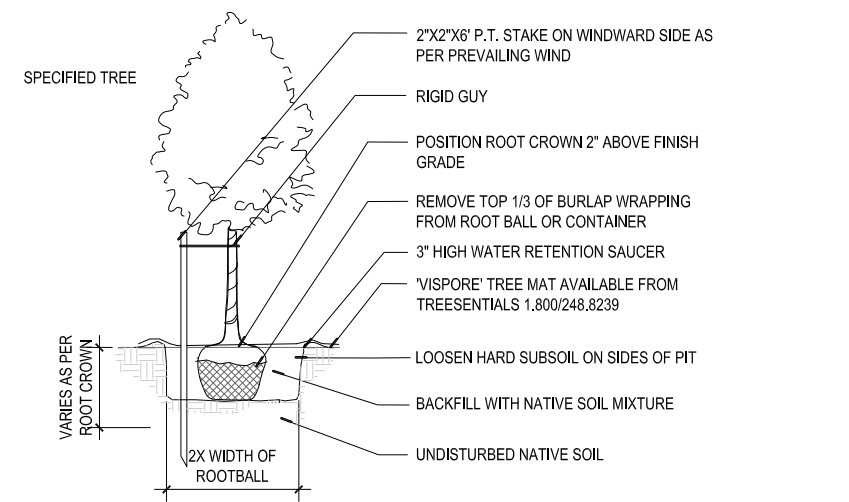

**4 SHRUB PLANTING - CONTAINER**  
SECTION  
0 6" 12" 24"

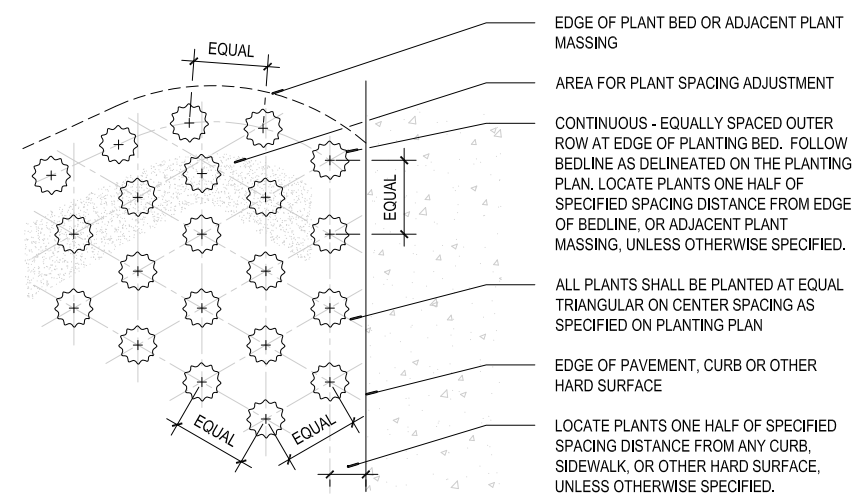

**5 GROUNDCOVER PLANTING**  
PLAN  
NOT TO SCALE

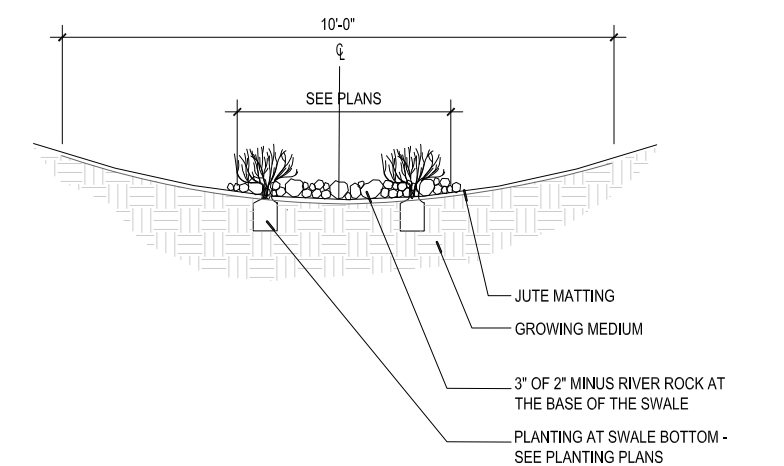

**6 TYPICAL SWALE PLANTING**  
SECTION  
NOT TO SCALE



LINE IS 2 INCHES  
AT FULL SIZE  
(IF NOT 2" - SCALE ACCORDINGLY)

DESIGNED: JB  
DRAWN: DD  
CHECKED: JB  
CHECKED: RT  
APPROVED: MF

REVISIONS			
NO.	DESCRIPTION	BY	APP.
1	TITLE BLOCK FOR PERMISSIBILITY		
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3	PLANTING_001.DWG		
4	NATIVE_PLANTS_015.DWG		
5	L160 SQUARE.DWG		
6	PLANTING_007.dwg		
7	PLANTING_012.dwg		
8	NATIVE_PLANTS_013.DWG		
9	W0144-BORDER.dwg		

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CITY OF LAKE OSWEGO  
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PHONE: 503-635-0270




LAKE OSWEGO AND TIGARD WATER TREATMENT PLANT  
DESIGN REVIEW AND CONDITIONAL USE  
**PLANTING PLAN  
DETAILS I**



FILENAME	
PROJECT NUMBER	
SCALE	varies
DRAWING/FIGURE NUMBER	12.5
52 OF	


PLOT DATE: January 10, 2012 - 7:57PM USER: jrb FILE: C:\pwwork\cdms5316\LOWTP\_L-12.dwg

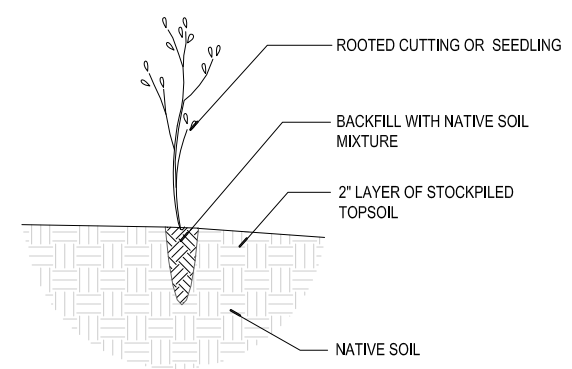

**1** TYPICAL PROPAGUAL PLANTING  
SECTION NOT TO SCALE

SCHEDULE

PLANT SIZE	BROWSE PROTECTION TUBE SIZE
1.2M HT. TREES	LARGE
CUTTING	SMALL
PLUG	SMALL
25MM CAL. TREE	LARGE
NO. 1 CONT. SHRUB	LARGE

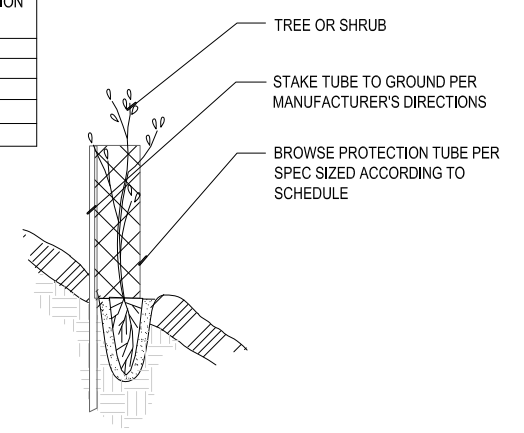

**2** BROWSE PROTECTION  
SECTION NOT TO SCALE

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Email: info@greenworkspc.com

**MWH**  
806 SW BROADWAY, SUITE 200  
PORTLAND, OREGON 97205

LINE IS 2 INCHES  
AT FULL SIZE  
(IF NOT 2" - SCALE ACCORDINGLY)

DESIGNED: JB  
DRAWN: DD  
CHECKED: JB  
CHECKED: RT  
APPROVED: MF

NO.	REVISIONS	BY	APP.
1	TITLE BLOCK FOR PERMITTING		
2	1500 SQUARE DWG		
3	NATIVE_PLANTS_002.DWG		
4	NATIVE_PLANTS_007.DWG		
5	W01424-BORDER.dwg		

OWNER:  
CITY OF LAKE OSWEGO  
380 A AVENUE  
LAKE OSWEGO, OR 97034  
PHONE: 503-635-0270

**Lake Oswego · Tigard Water Partnership**  
sharing water · connecting communities


LAKE OSWEGO AND TIGARD WATER TREATMENT PLANT  
DESIGN REVIEW AND CONDITIONAL USE  
**PLANTING PLAN  
DETAILS II**

FILENAME
PROJECT NUMBER
SCALE varies
DRAWING/FIGURE NUMBER <b>12.6</b>
54 OF

A B C D E F G H I J K L M N O P

GENERAL SHEET NOTES

1. SEE FIGURE 11.0 FOR IRRIGATION LEGEND AND NOTES.

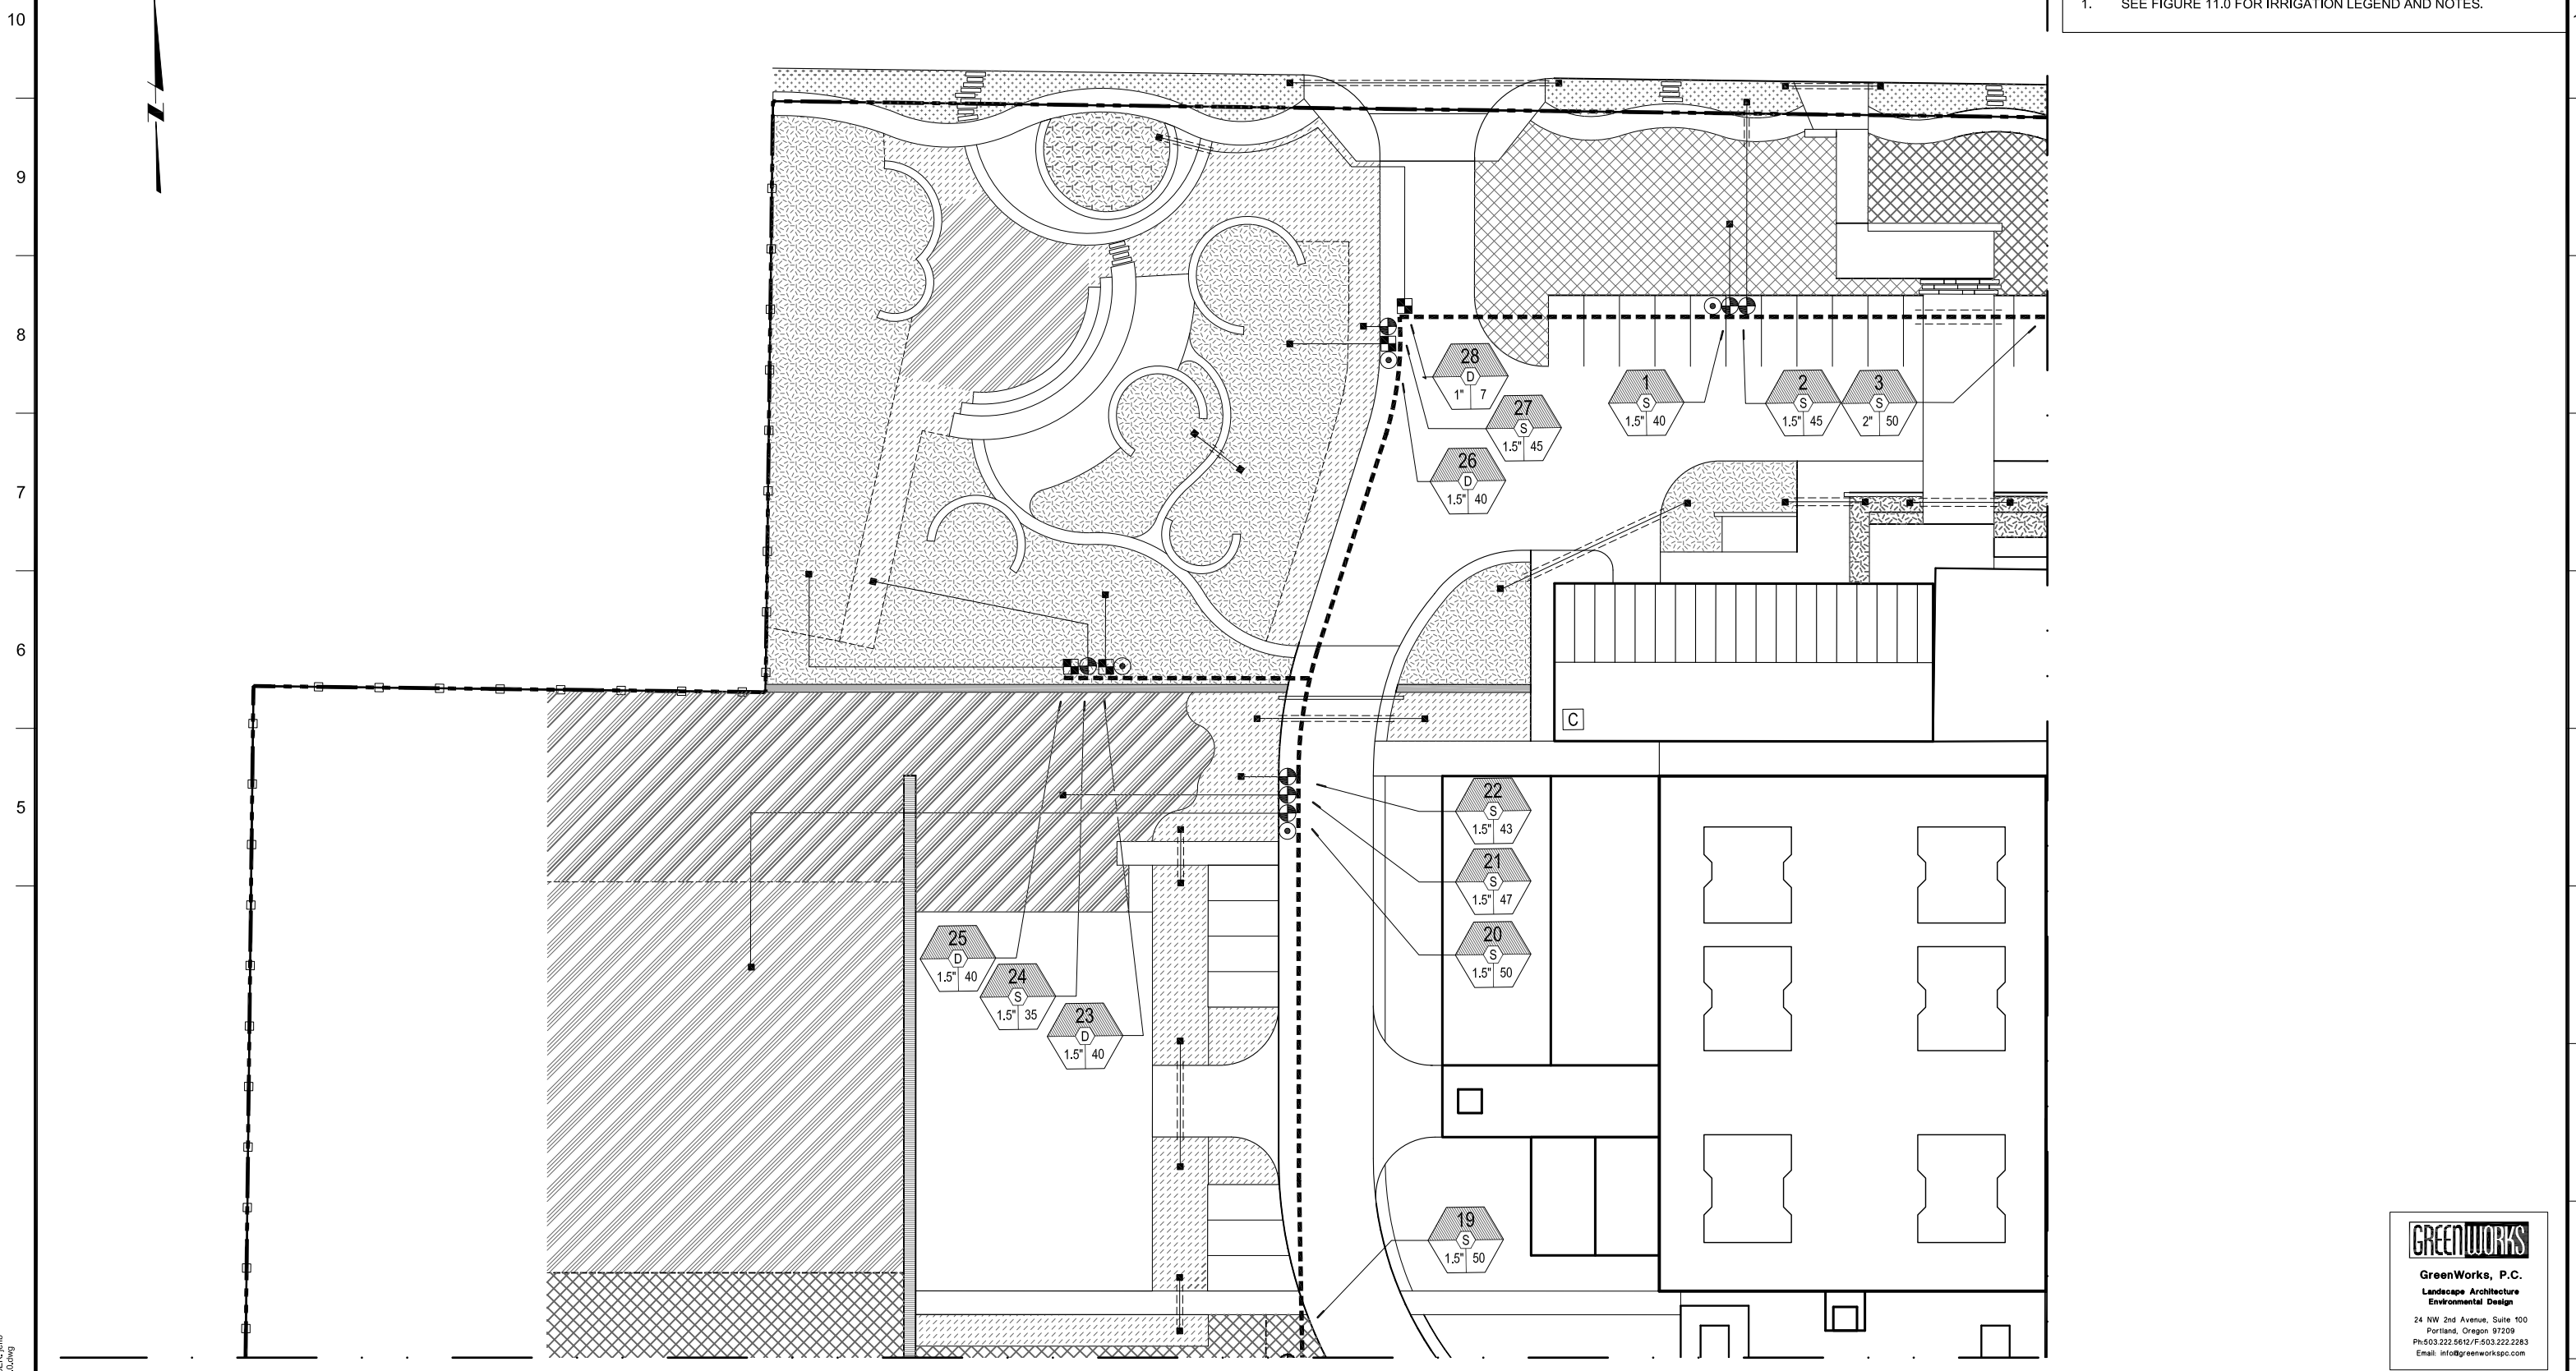

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 Email: info@greenworkspc.com

**MWH**  
 806 SW BROADWAY, SUITE 200  
 PORTLAND, OREGON 97205

LINE IS 2 INCHES  
 AT FULL SIZE  
 (IF NOT 2" - SCALE ACCORDINGLY)

DESIGNED: JB  
 DRAWN: DD  
 CHECKED: JB  
 CHECKED: RT  
 APPROVED: MF

REVISIONS				
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5	LOWTP_L_DESIGN_BASE.dwg			
6	LOWTP_L_IRRIG_EASE.dwg			
7	LOWTP_L_DESIGN_BASE cad 2004.dwg			
8	W01434-BORDER.dwg			

OWNER:  
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 LAKE OSWEGO, OR 97034  
 PHONE: 503-635-0270




LAKE OSWEGO AND TIGARD WATER TREATMENT PLANT  
 DESIGN REVIEW AND CONDITIONAL USE  
**IRRIGATION PLAN  
 AREA A**

FILENAME	
PROJECT NUMBER	
SCALE	1" = 20'
DRAWING/FIGURE NUMBER	13.0
	55 OF

PLOT DATE: January 10, 2012 - 6:49PM USER: mfb FILE: C:\pwwork\cdms5316\LOWTP-A-13.0.dwg

A B C D E F G H I J K L M N O P

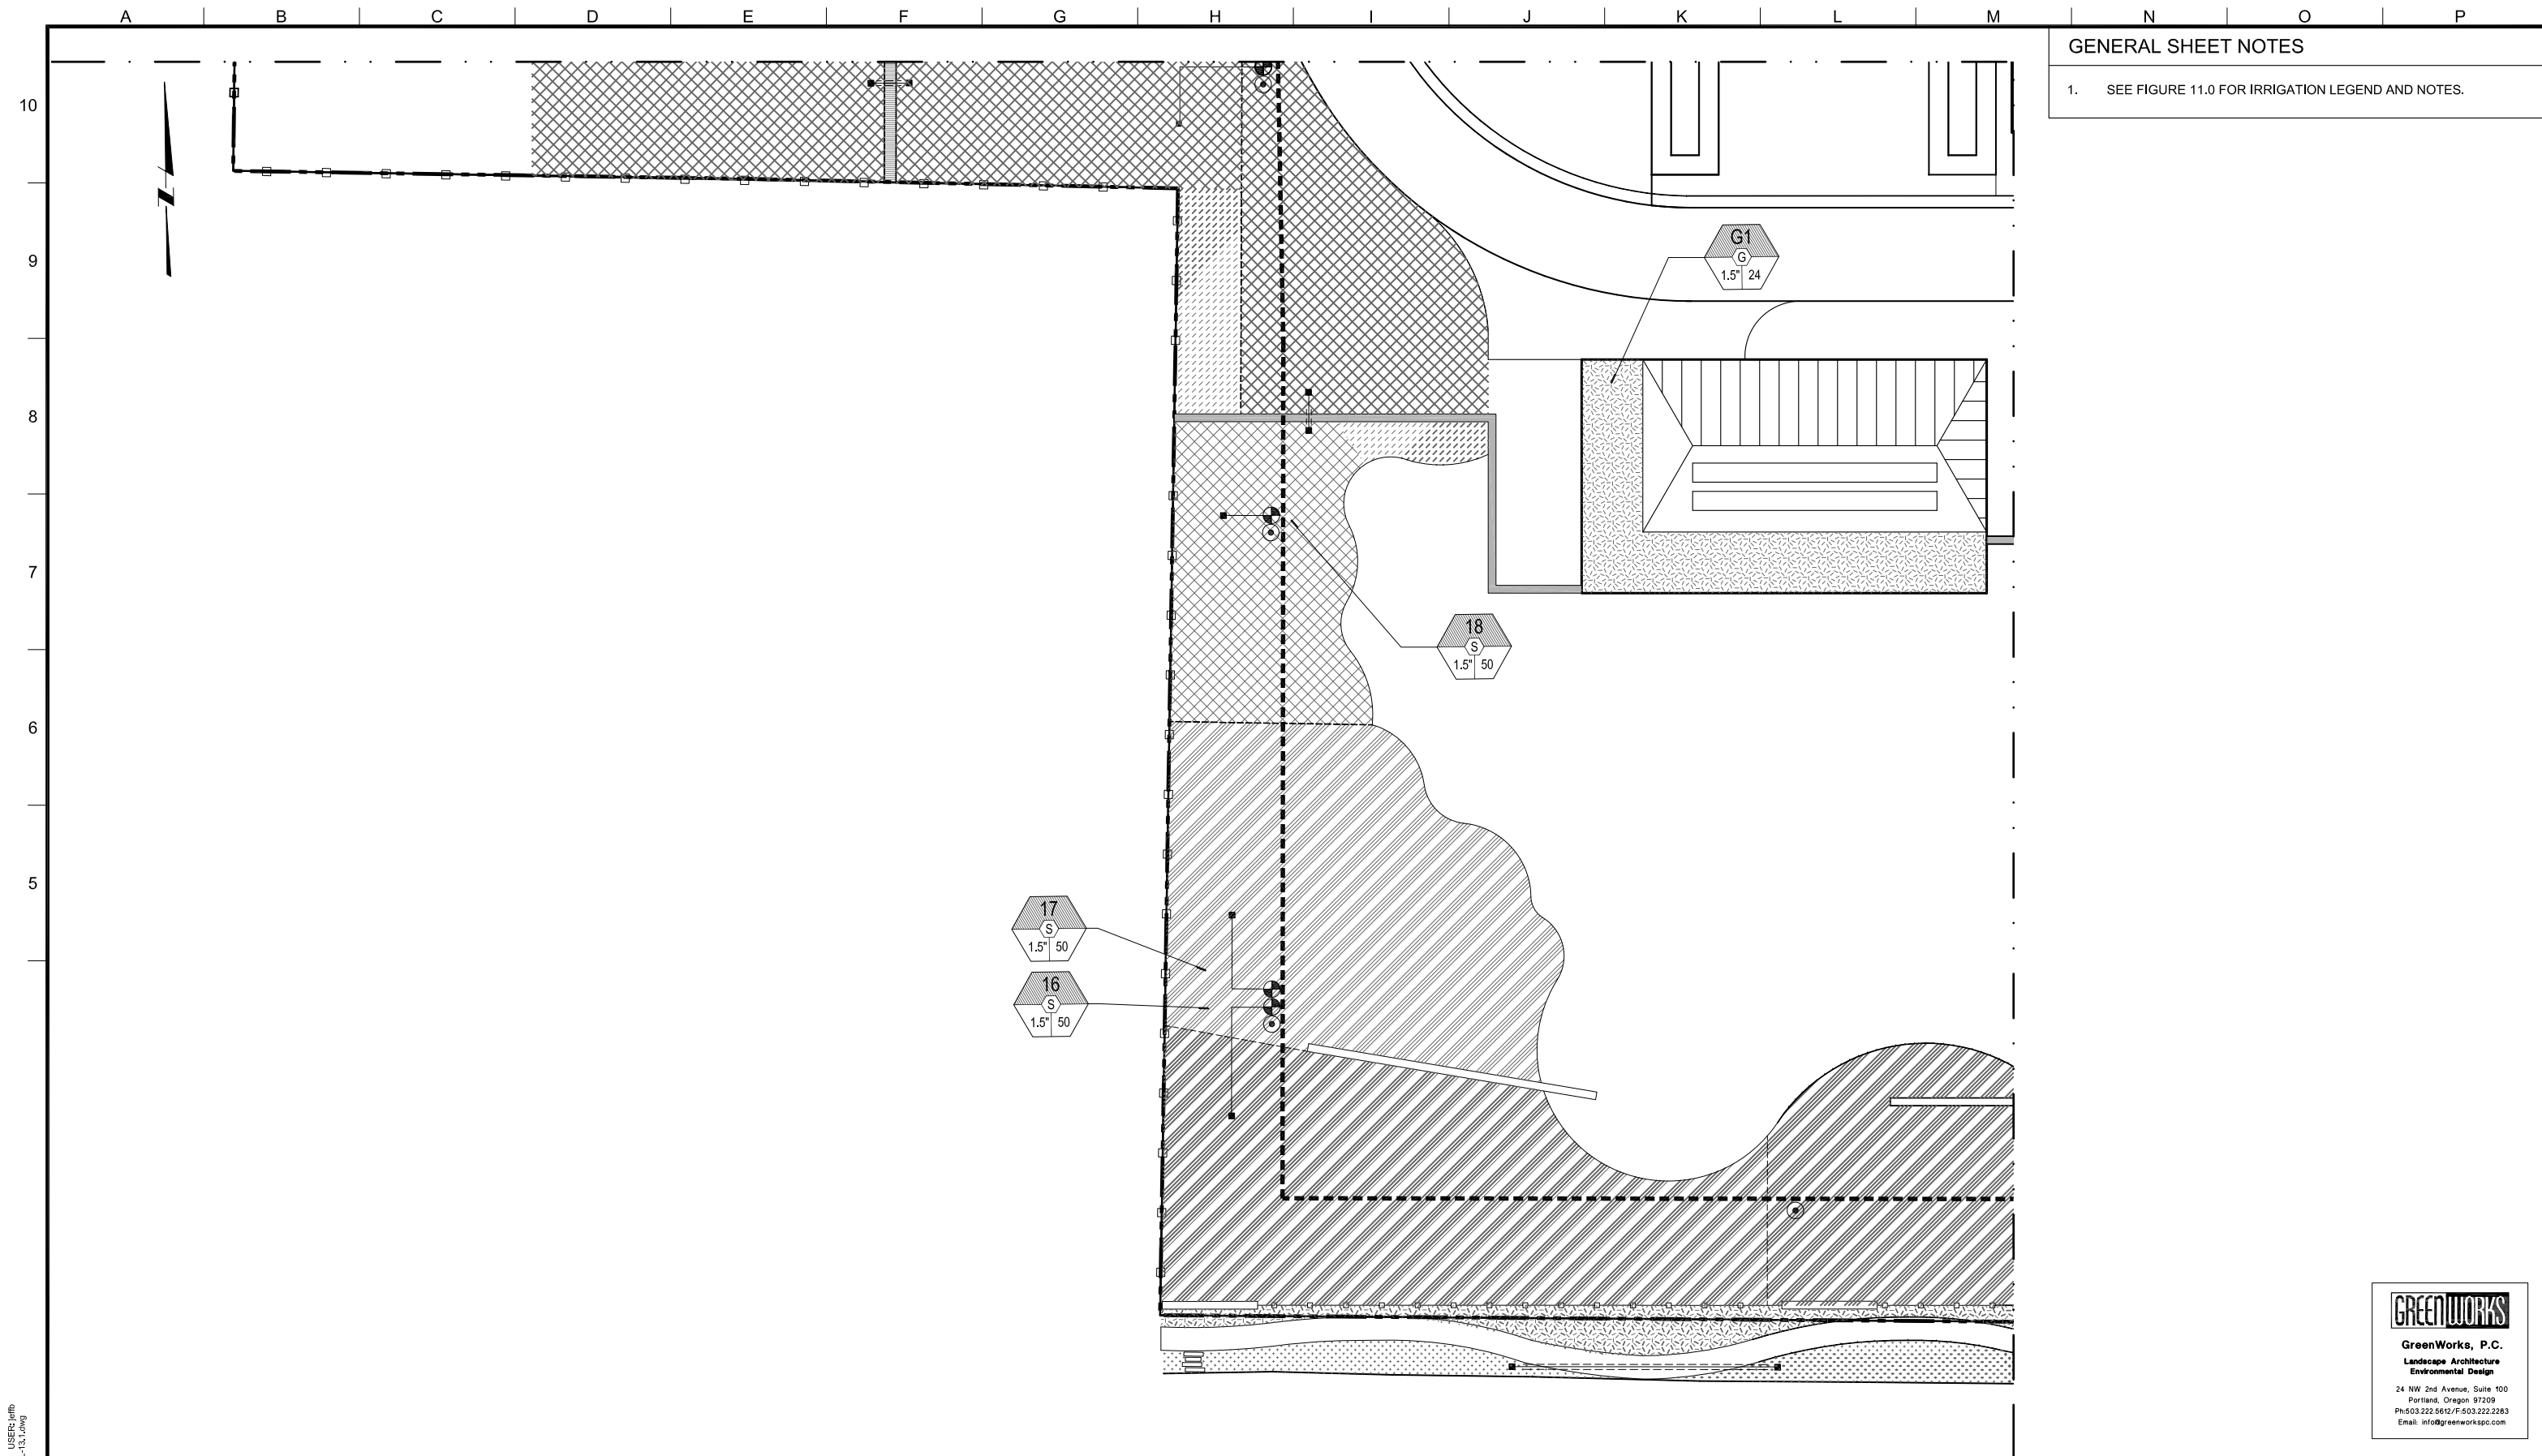

**GENERAL SHEET NOTES**  
 1. SEE FIGURE 11.0 FOR IRRIGATION LEGEND AND NOTES.

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 Email: info@greenworkspc.com

**MWH**  
 806 SW BROADWAY, SUITE 200  
 PORTLAND, OREGON 97205

LINE IS 2 INCHES  
 AT FULL SIZE  
 (IF NOT 2" - SCALE ACCORDINGLY)

DESIGNED: JB  
 DRAWN: DD  
 CHECKED: JB  
 CHECKED: RT  
 APPROVED: MF

REVISIONS				
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4	GW LOGO SQUARE.DWG			
5	LOWTP_L_DESIGN_BASE.dwg			
6	LOWTP_L_IRRIG_PHASE.dwg			
7	LOWTP_fence_model.dwg			
8	LOWTP_L_DESIGN_BASE cad 2004.dwg			
9	W01424-BORDER.dwg			

**OWNER:**  
 CITY OF LAKE OSWEGO  
 380 A AVENUE  
 LAKE OSWEGO, OR 97034  
 PHONE: 503-635-0270




LAKE OSWEGO AND TIGARD WATER TREATMENT PLANT  
 DESIGN REVIEW AND CONDITIONAL USE  
**IRRIGATION PLAN**  
**AREA B**

FILENAME	
PROJECT NUMBER	
SCALE	1" = 20'
DRAWING/FIGURE NUMBER	13.1
	56 OF

PLOT DATE: January 10, 2012 - 6:52PM USER: mhB  
 FILE: C:\pwork\cdms55316\LOWTP-B-L-13.1.dwg

GENERAL SHEET NOTES

1. SEE FIGURE 11.0 FOR IRRIGATION LEGEND AND NOTES.

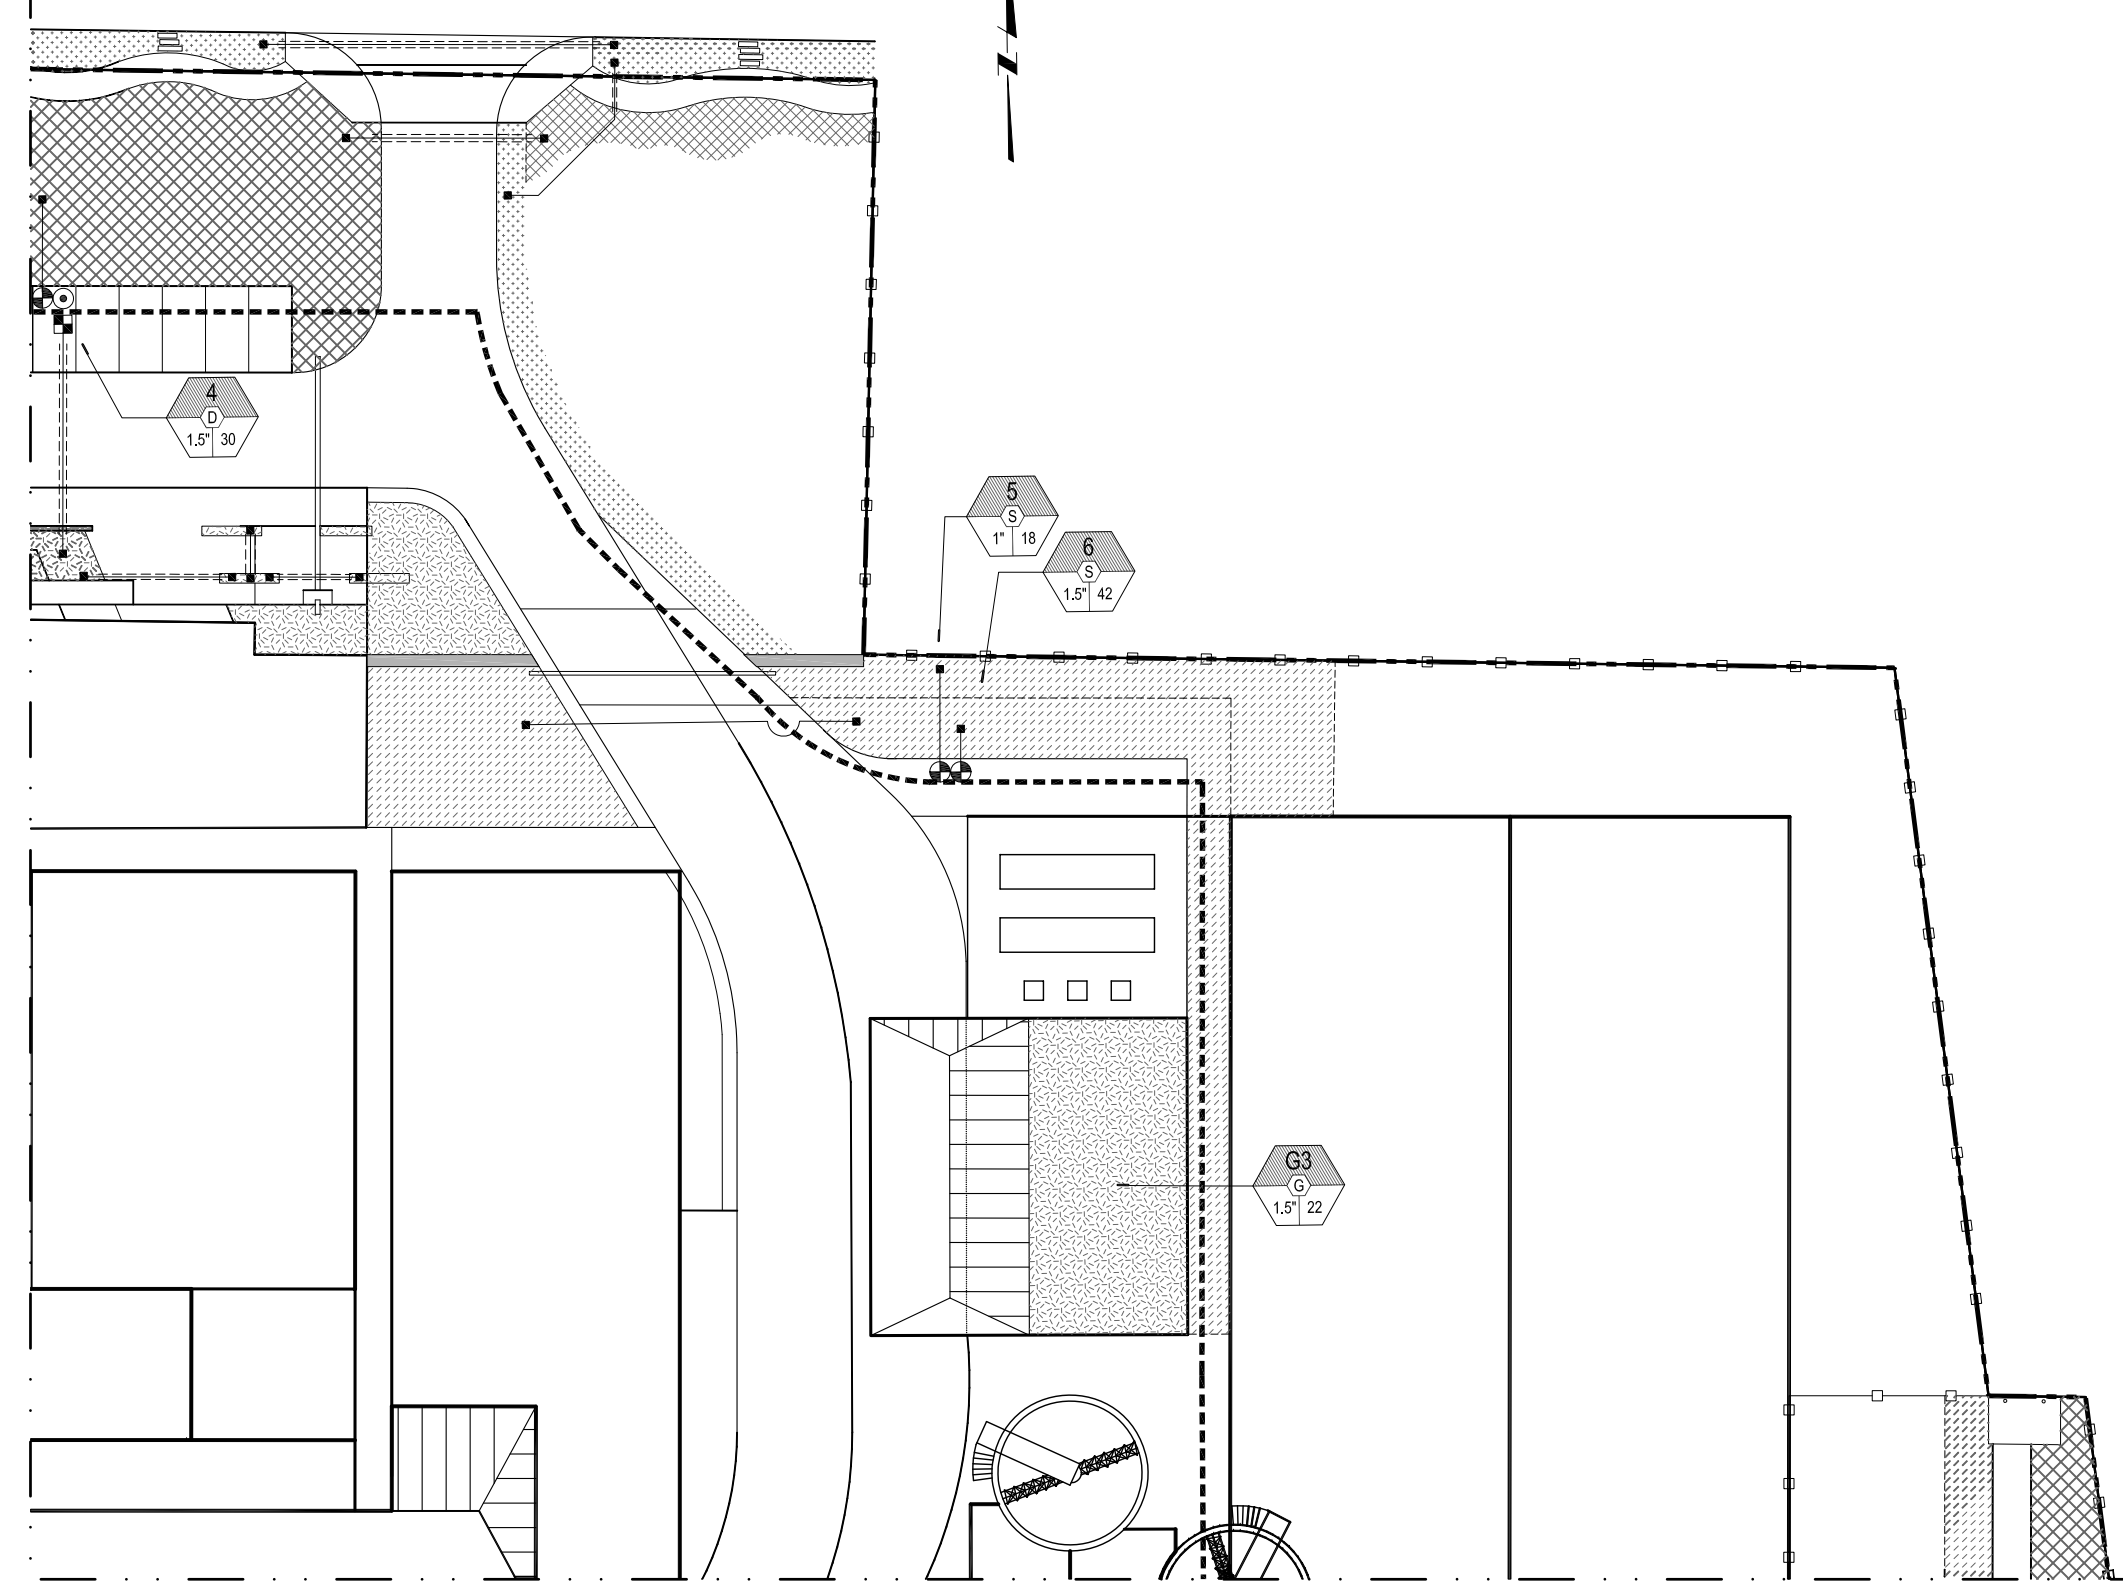

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 Email: info@greenworkspc.com

**MWH**  
 806 SW BROADWAY, SUITE 200  
 PORTLAND, OREGON 97205

LINE IS 2 INCHES  
 AT FULL SIZE  
 (IF NOT 2" - SCALE ACCORDINGLY)

DESIGNED: JB  
 DRAWN: DD  
 CHECKED: JB  
 CHECKED: RT  
 APPROVED: MF

REVISIONS			
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5	LOWTP - DESIGN_BASE.dwg		
6	LOWTP - IRRIG_CASE.dwg		
7	LOWTP - fence_model.dwg		
8	LOWTP - DESIGN_BASE cad 2004.dwg		
9	W01434-BORDER.dwg		

OWNER:  
 CITY OF LAKE OSWEGO  
 380 A AVENUE  
 LAKE OSWEGO, OR 97034  
 PHONE: 503-635-0270




LAKE OSWEGO AND TIGARD WATER TREATMENT PLANT  
 DESIGN REVIEW AND CONDITIONAL USE  
**IRRIGATION PLAN**  
 AREA C

FILENAME	
PROJECT NUMBER	
SCALE	1" = 20'
DRAWING/FIGURE NUMBER	13.2
	57 OF

PLOT DATE: January 10, 2012 - 6:56PM USER: mh/b FILE: C:\pwworkdir\dms55316\LOWTP-C-13.2.dwg

**GENERAL SHEET NOTES**  
 1. SEE FIGURE 11.0 FOR IRRIGATION LEGEND AND NOTES.

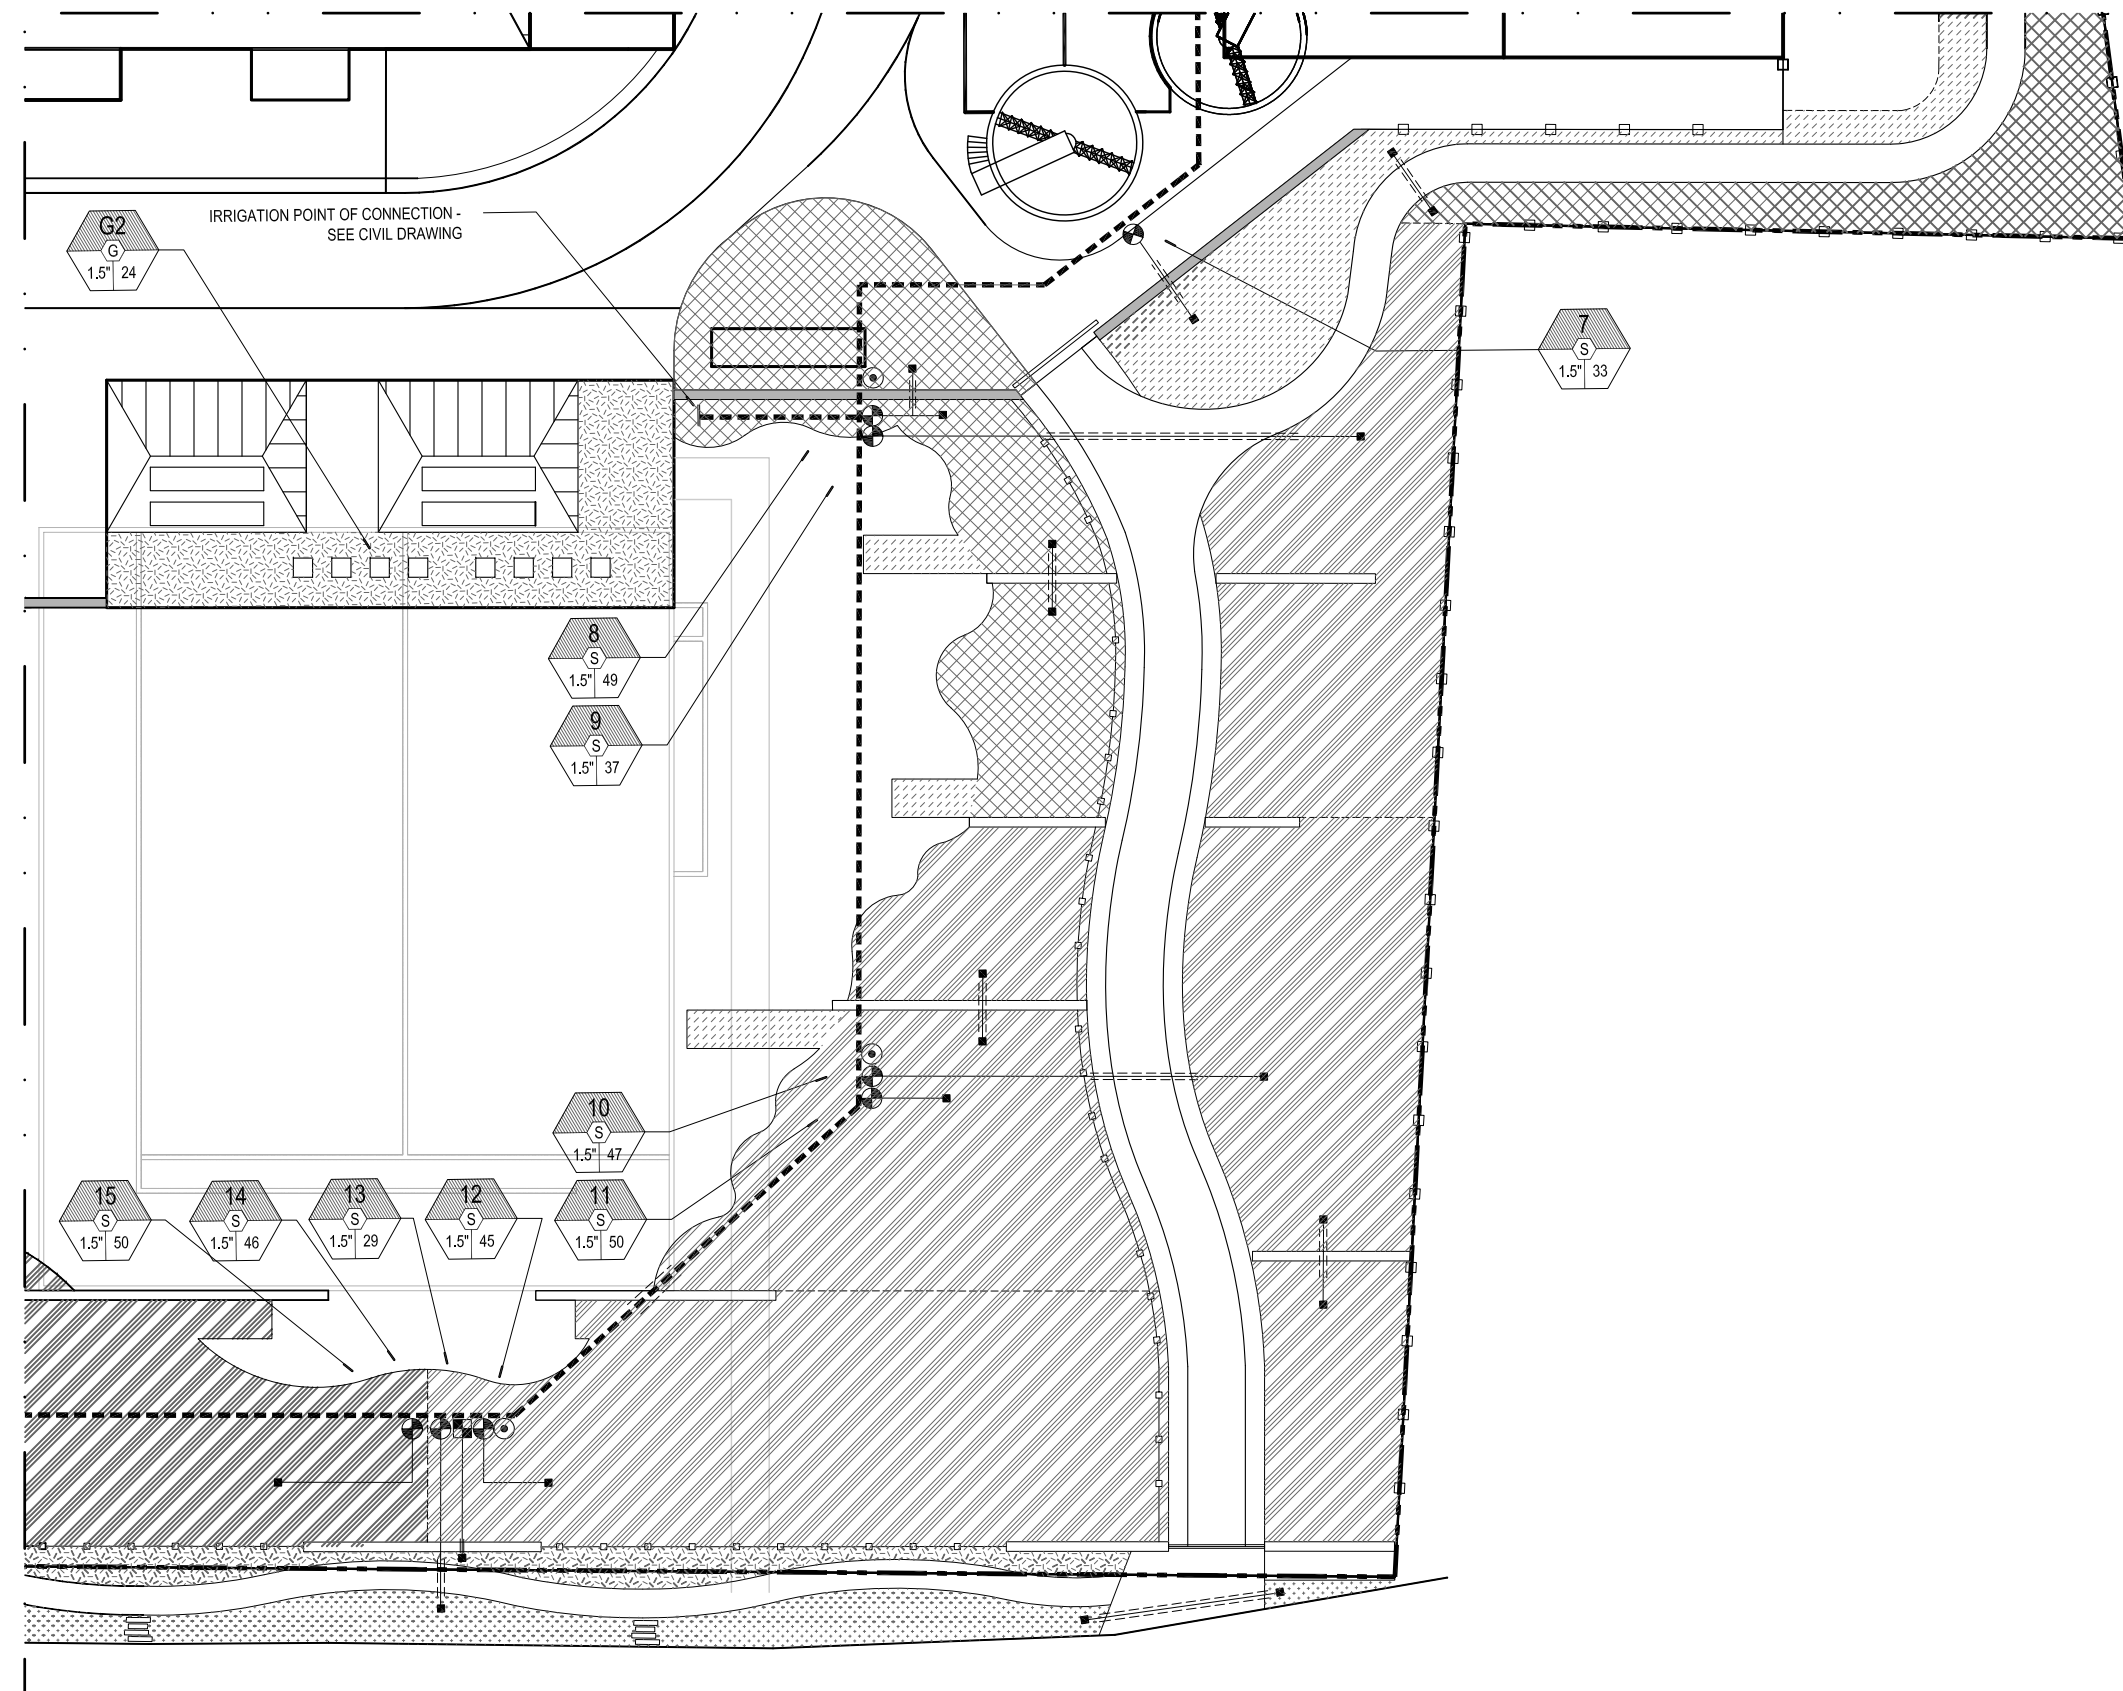

PLOT DATE: January 10, 2012 - 7:01PM USER: jrb  
 FILE: C:\pwwork\cdms55316\LOWTF-D-L-13.3.dwg



LINE IS 2 INCHES  
 AT FULL SIZE  
 (IF NOT 2" - SCALE ACCORDINGLY)

DESIGNED: JB  
 DRAWN: DD  
 CHECKED: JB  
 CHECKED: RT  
 APPROVED: MF

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5	LOWTF - DESIGN_BASE.dwg		
6	LOWTF - JURISD. EASE.dwg		
7	LOWTF - fence_model.dwg		
8	LOWTF - DESIGN_BASE cad 2004.dwg		
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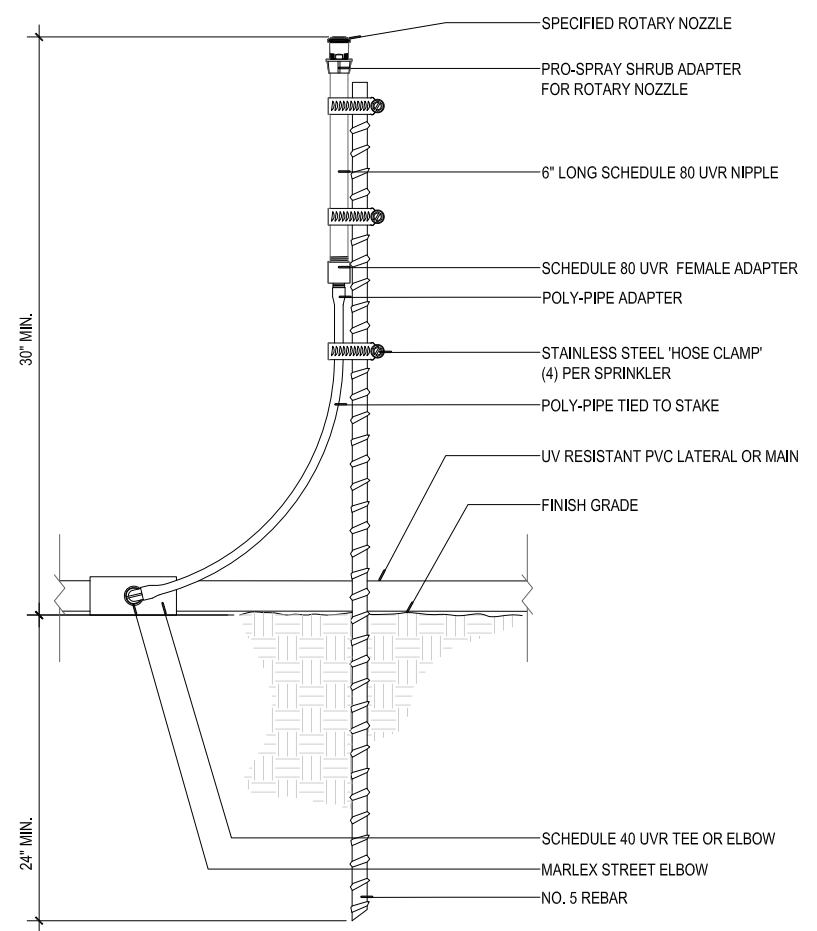
**OWNER:**  
 CITY OF LAKE OSWEGO  
 380 A AVENUE  
 LAKE OSWEGO, OR 97034  
 PHONE: 503-635-0270




LAKE OSWEGO AND TIGARD WATER TREATMENT PLANT  
 DESIGN REVIEW AND CONDITIONAL USE  
**IRRIGATION PLAN**  
 AREA D




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PROJECT NUMBER	
SCALE	1" = 20'
DRAWING/FIGURE NUMBER	13.3
	58 OF




**1** ROTARY NOZZLE - TEMPORARY IRRIGATION ON GRADE  
SECTION NOT TO SCALE

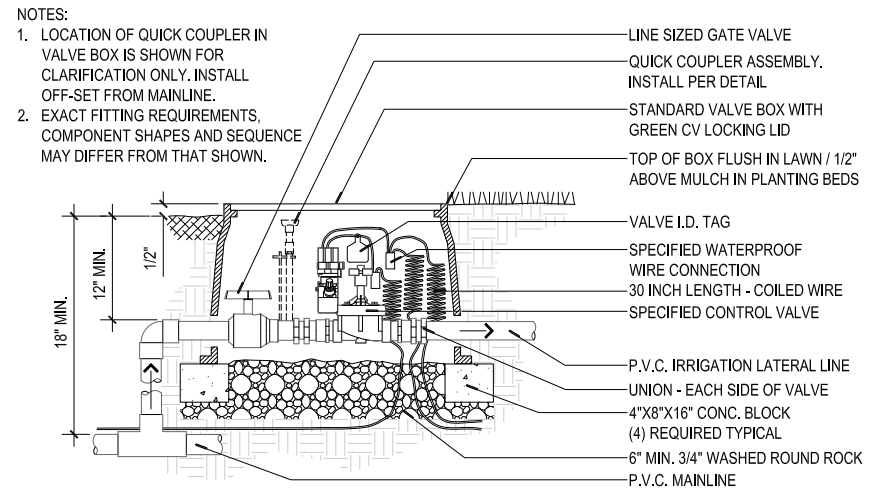


**2** AUTOMATIC CONTROL VALVE ASSEMBLY  
SECTION NOT TO SCALE

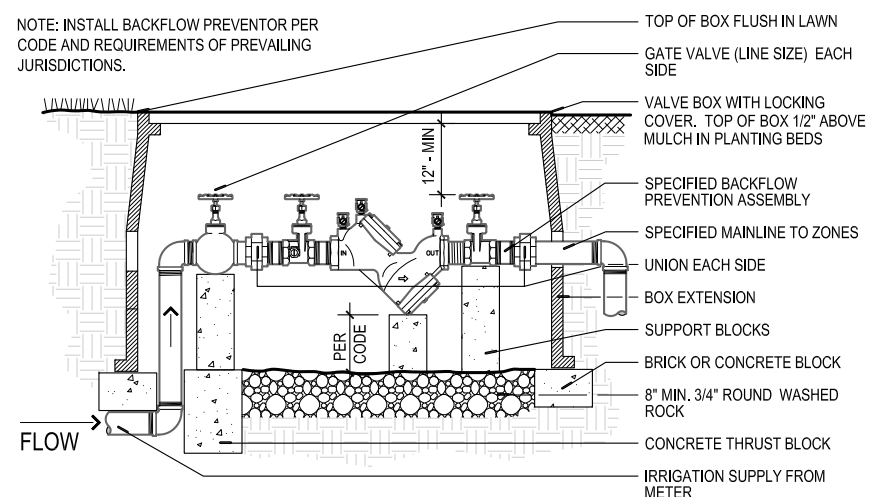

**4** BACKFLOW PREVENTION ASSEMBLY  
SECTION NOT TO SCALE

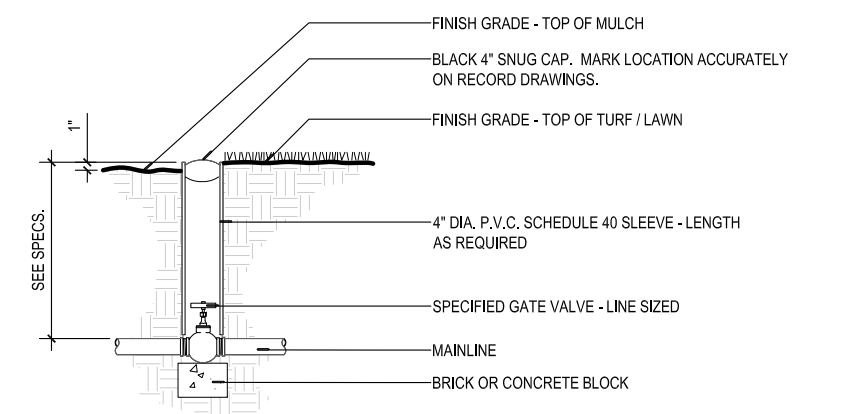

**3** GATE VALVE ASSEMBLY  
SECTION NOT TO SCALE

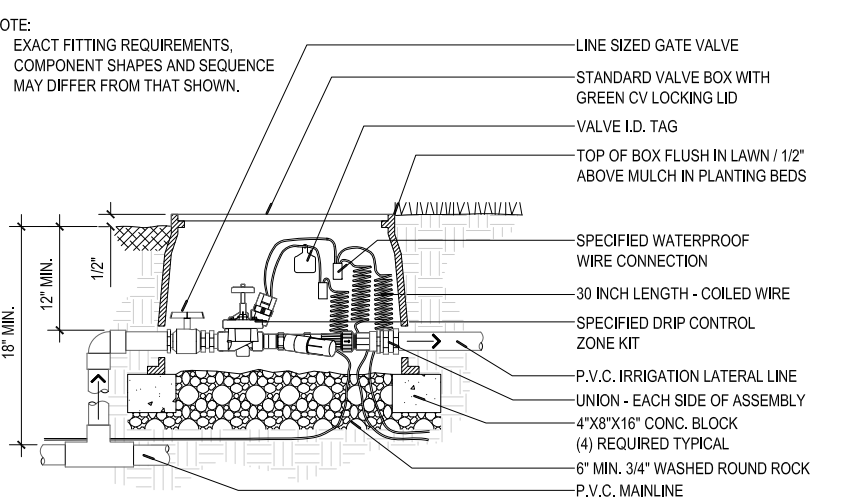

**5** DRIP CONTROL ZONE ASSEMBLY  
SECTION NOT TO SCALE



DESIGNED: JB  
DRAWN: DD  
CHECKED: JB  
CHECKED: RT  
APPROVED: MF

NO.	DATE	DESCRIPTION	BY	APP.
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5		028110_VALVE_003.dwg		
6		028110_VALVE_007.dwg		
7		028110_HEAD_003A.dwg		
8		W01424-BORDER.dwg		

OWNER:  
CITY OF LAKE OSWEGO  
380 A AVENUE  
LAKE OSWEGO, OR 97034  
PHONE: 503-635-0270




LAKE OSWEGO AND TIGARD WATER TREATMENT PLANT  
DESIGN REVIEW AND CONDITIONAL USE  
IRRIGATION PLAN  
DETAILS I




FILENAME	
PROJECT NUMBER	
SCALE	varies
DRAWING/FIGURE NUMBER	13.4
52 OF	

PLOT DATE: January 10, 2012 - 7:17PM USER: mfb FILE: C:\pwworkdir\cims55316\LOW\PL-13.dwg




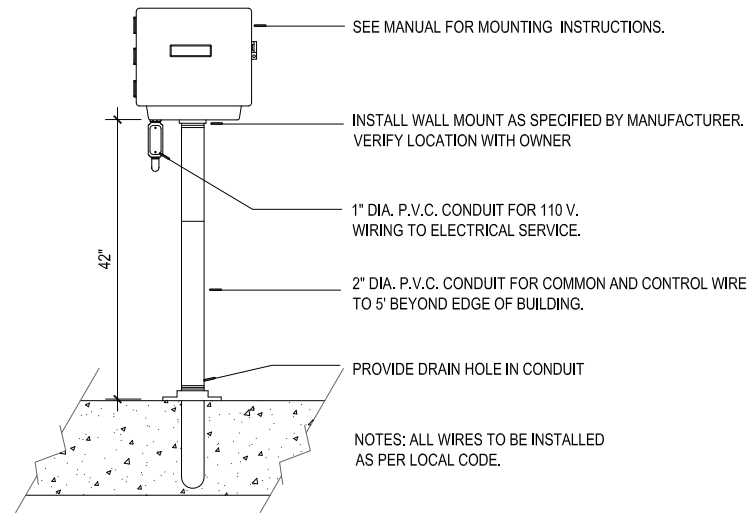


**1 WALLMOUNT CONTROLLER VALVE**  
SECTION NOT TO SCALE

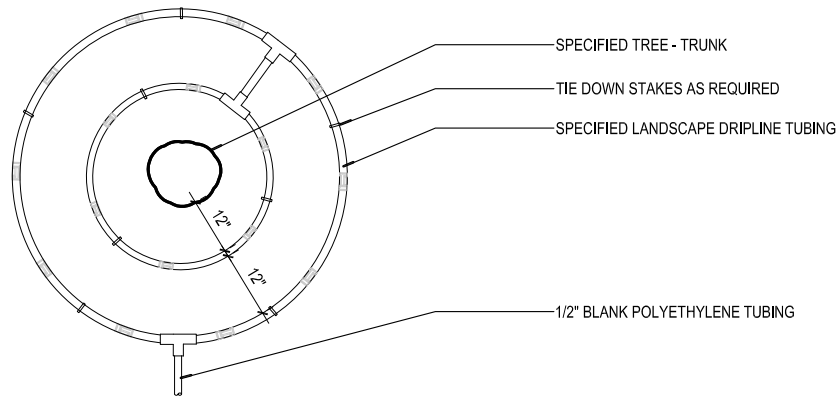


**2 DRIPLINE AROUND TREE**  
TYPE NOT TO SCALE

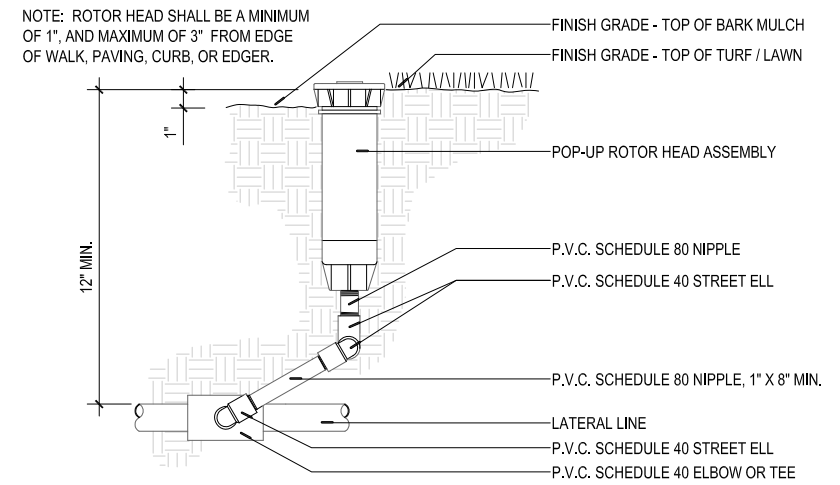


**3 ROTOR HEAD - PVC SWING JOINT ASSEMBLY**  
SECTION NOT TO SCALE

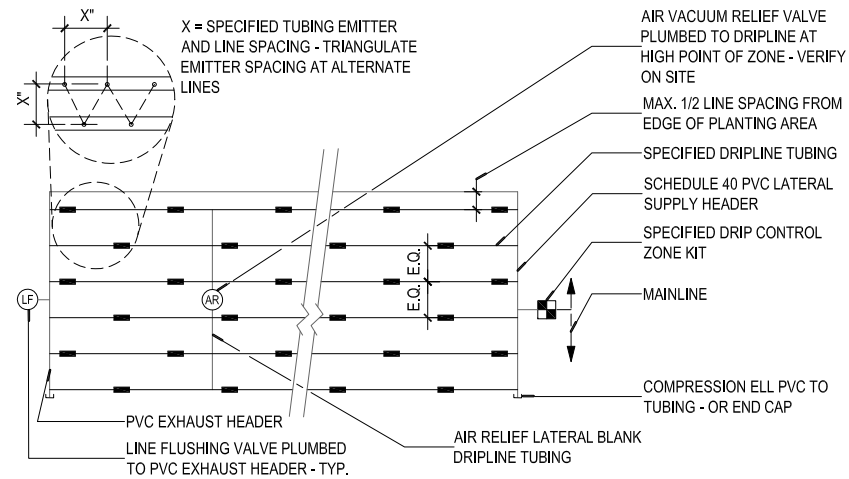

**4 INLINE EMITTER TUBING INSTALLATION**  
PLAN NOT TO SCALE

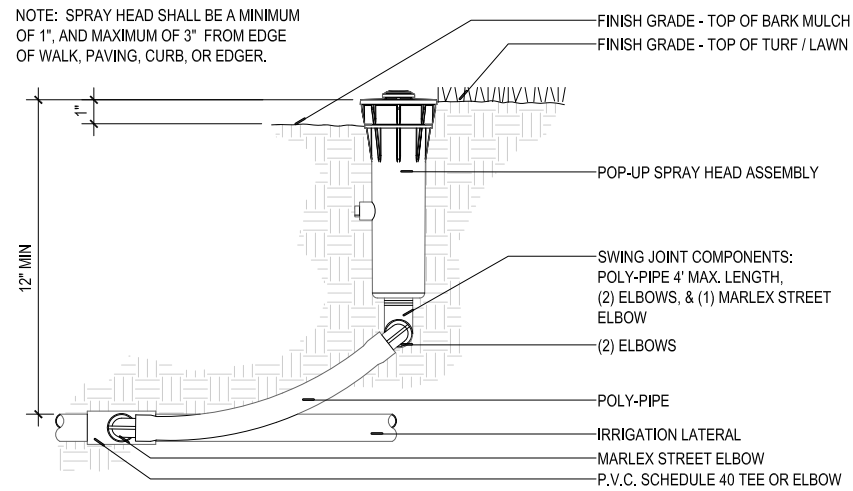

**5 SPRAY HEAD - POLY SWING PIPE ASSEMBLY**  
SECTION NOT TO SCALE

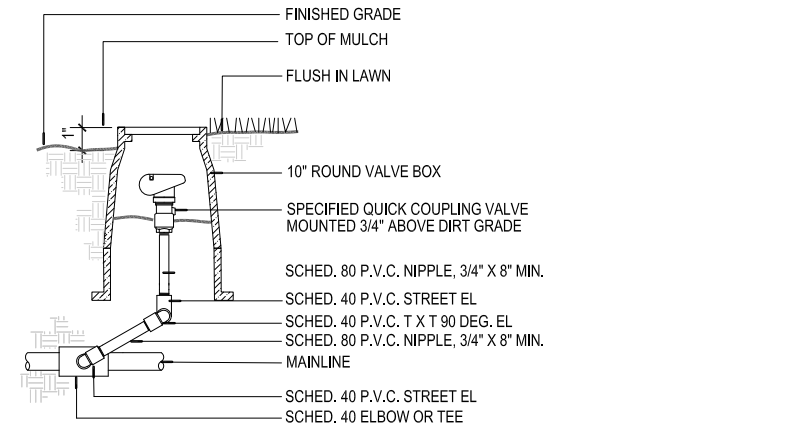

**6 QUICK COUPLER VALVE ASSEMBLY**  
SECTION NOT TO SCALE

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**MWH**  
806 SW BROADWAY, SUITE 200  
PORTLAND, OREGON 97205

LINE IS 2 INCHES  
AT FULL SIZE  
(IF NOT 2" - SCALE ACCORDINGLY)

DESIGNED: JB  
DRAWN: DD  
CHECKED: JB  
CHECKED: RT  
APPROVED: MF


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3	028101-DRIP_001.dwg		
4	028101-DRIP_005.dwg		
5	028101-HEAD_001.dwg		
6	028101-HEAD_002.dwg		
7	028101-CC_001.dwg		
8	W01434-BORDER.dwg		

OWNER:  
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380 A AVENUE  
LAKE OSWEGO, OR 97034  
PHONE: 503-635-0270



**Lake Oswego · Tigard Water Partnership**  
sharing water · connecting communities

LAKE OSWEGO AND TIGARD WATER TREATMENT PLANT  
DESIGN REVIEW AND CONDITIONAL USE  
**IRRIGATION PLAN  
DETAILS II**



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PROJECT NUMBER	
SCALE	varies
DRAWING/FIGURE NUMBER	<b>13.5</b>
60 OF	

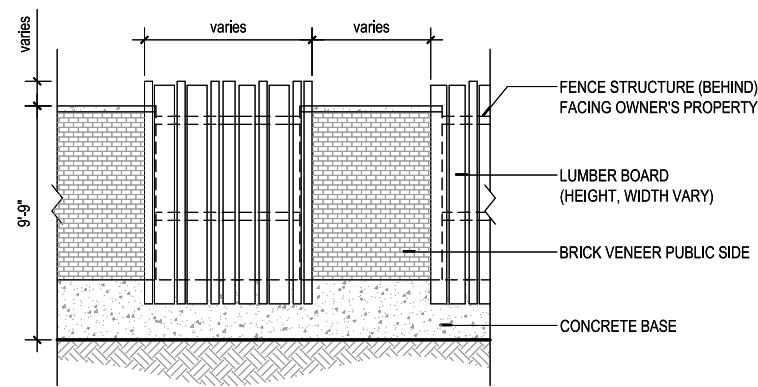


**1 ARCHITECTURAL SECURITY WALL**  
SECTION/ELEVATION FROM ADJOINING PROPERTY

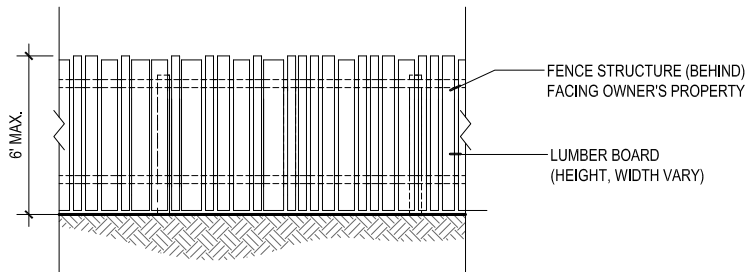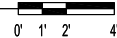



**2 GOOD NEIGHBOR FENCE**  
SECTION/ELEVATION FROM ADJOINING PROPERTY

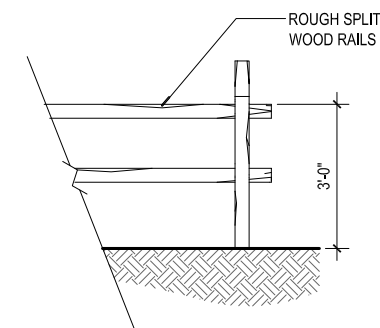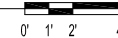


**3 SPLIT RAIL FENCE**  
SECTION/ELEVATION

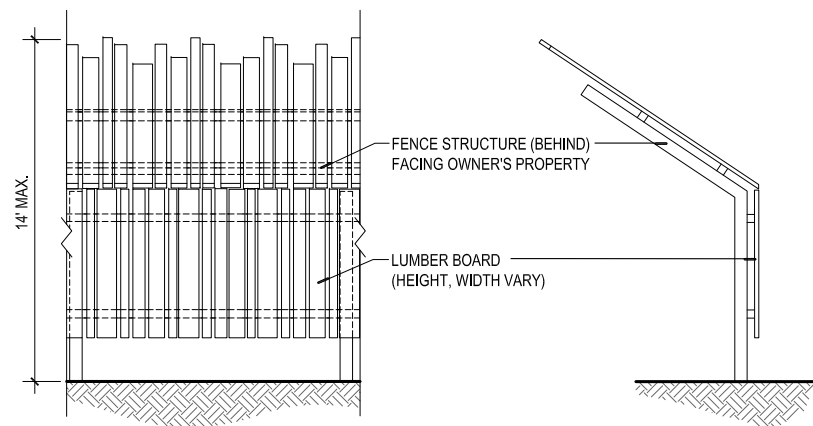

**4 VISUAL SCREEN FENCE**  
SECTION/ELEVATION FROM ADJOINING PROPERTY

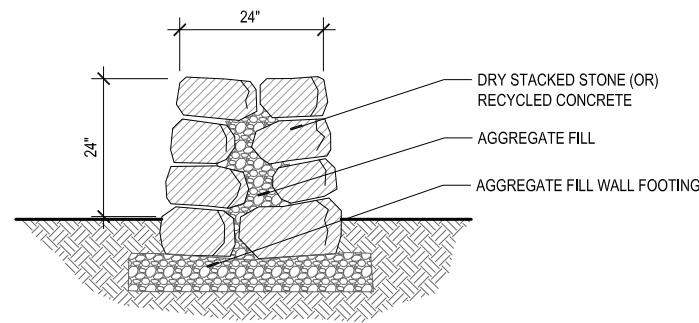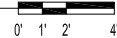

**5 LOW SITE WALL**  
SECTION

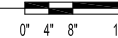

NOTES:  
1. SECURITY CHAINLINK TO BE ADDED WHERE DETERMINED APPROPRIATE ON OWNER'S SIDE

NOTES:  
1. WALL FOOTING TO BE ADJUSTED TO PROTECT EXISTING TREE ROOTS WHERE NECESSARY

**GREENWORKS**  
GreenWorks, P.C.  
Landscape Architecture  
Environmental Design  
24 NW 2nd Avenue, Suite 100  
Portland, Oregon 97209  
Ph: 503.222.5612 / F: 503.222.2283  
Email: info@greenworkspc.com

**MWH**  
806 SW BROADWAY, SUITE 200  
PORTLAND, OREGON 97205

LINE IS 2 INCHES  
AT FULL SIZE  
(IF NOT 2" - SCALE ACCORDINGLY)

DESIGNED: JB  
DRAWN: DS  
CHECKED: JB  
CHECKED: RT  
APPROVED: MF

REVISIONS			
NO.	DESCRIPTION	BY	APP.
1	TITLE BLOCK FOR PERMITTING		
2	GOOD SQUARE DWG		
3	DET_L_FENCE_SECURITYWALL.DWG		
4	DET_L_FENCE_GOODNEIGHBOR.DWG		
5	DET_L_FENCE_SPLITRAIL.DWG		
6	DET_L_FENCE_VISUALSCREEN.DWG		
7	04866_STONE_WALL_DRY.dwg		
8	W01424-BORDER.dwg		


OWNER:  
CITY OF LAKE OSWEGO  
380 A AVENUE  
LAKE OSWEGO, OR 97034  
PHONE: 503-635-0270

**Lake Oswego · Tigard Water Partnership**  
sharing water · connecting communities



LAKE OSWEGO AND TIGARD WATER TREATMENT PLANT  
DESIGN REVIEW AND CONDITIONAL USE  
HARDSCAPE & MATERIALS PLAN  
DETAILS I  
FENCES & WALLS

FILENAME	
PROJECT NUMBER	
SCALE	varies
DRAWING/FIGURE NUMBER	14.0
52 OF	

PLOT DATE: January 10, 2012 - 7:52 PM USER: mhb  
FILE: C:\pwworking\dm553161\LOWTP\14.dwg

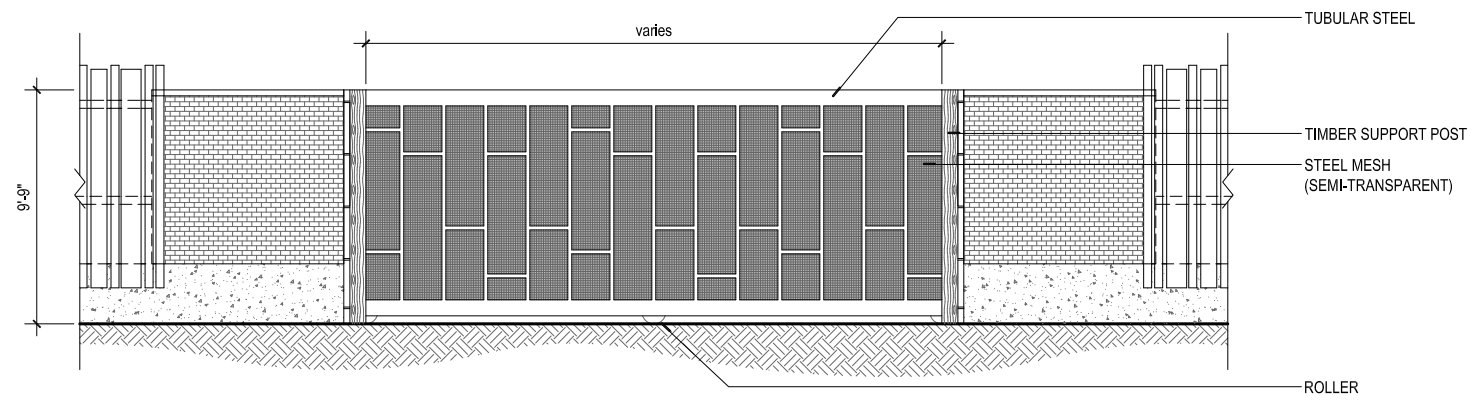

**1** ARCHITECTURAL SECURITY GATE  
SECTION/ELEVATION

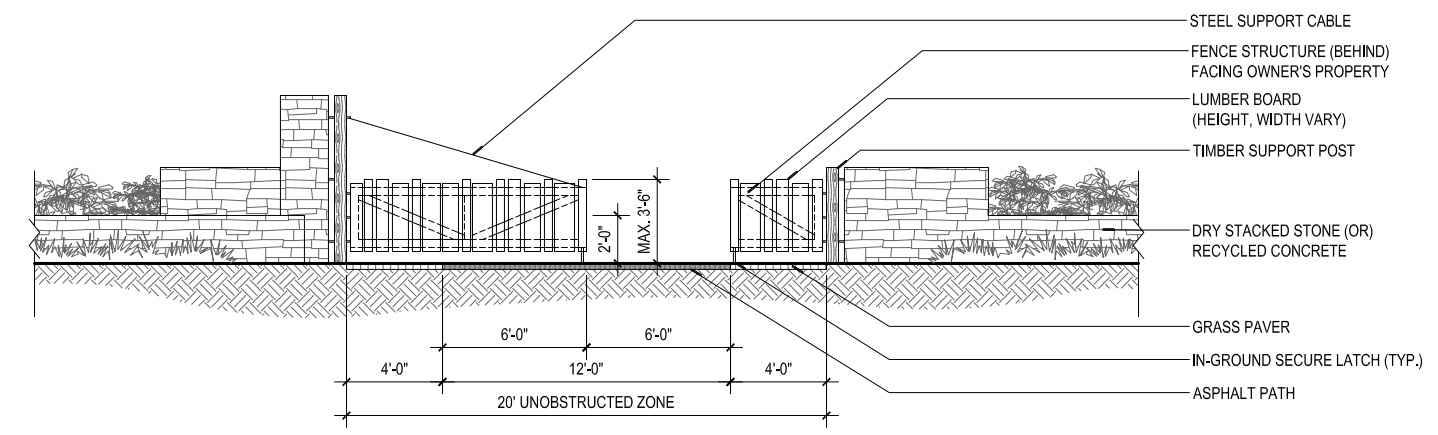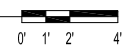

**2** SWING GATE  
SECTION/ELEVATION FROM MAPLETON DRIVE



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Environmental Design  
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**MWH**  
806 SW BROADWAY, SUITE 200  
PORTLAND, OREGON 97205

LINE IS 2 INCHES  
AT FULL SIZE  
(IF NOT 2" - SCALE ACCORDINGLY)

DESIGNED: JB  
DRAWN: DS  
CHECKED: RT  
APPROVED: MF

REVISIONS			
NO.	DESCRIPTION	BY	APP.
1	13824 - TITLE BLOCK FOR PERMITTING		
2	W01424-SQUARE.DWG		
3	DET_GATE_SWINGGATE.dwg		
4	DET_GATE_ARCSECURITYGATE.dwg		
5	W01424-BORDER.dwg		

OWNER:  
CITY OF LAKE OSWEGO  
380 A AVENUE  
LAKE OSWEGO, OR 97034  
PHONE: 503-635-0270

**Lake Oswego · Tigard  
Water Partnership**  
sharing water · connecting communities

LAKE OSWEGO AND TIGARD WATER TREATMENT PLANT  
DESIGN REVIEW AND CONDITIONAL USE  
HARDSCAPE & MATERIALS PLAN  
DETAILS II  
GATES

FILENAME	
PROJECT NUMBER	
SCALE	varies
DRAWING/FIGURE NUMBER	14.1
52 OF	

PLOT DATE: January 10, 2012 - 7:23PM USER: mhB  
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