
### SHADY HOLLOW VILLAGE WILLAMETTE DRIVE (OR43) AND SHADY HOLLOW WAY PUBLIC IMPROVEMENTS

TAX LOT 45, 46 & 47, LOCATED IN THE SE 1/4 OF SECTION 14, T.2S, R.1E., WILLAMETTE MERIDIAN, CITY OF WEST LINN, CLACKAMAS COUNTY, STATE OF OREGON

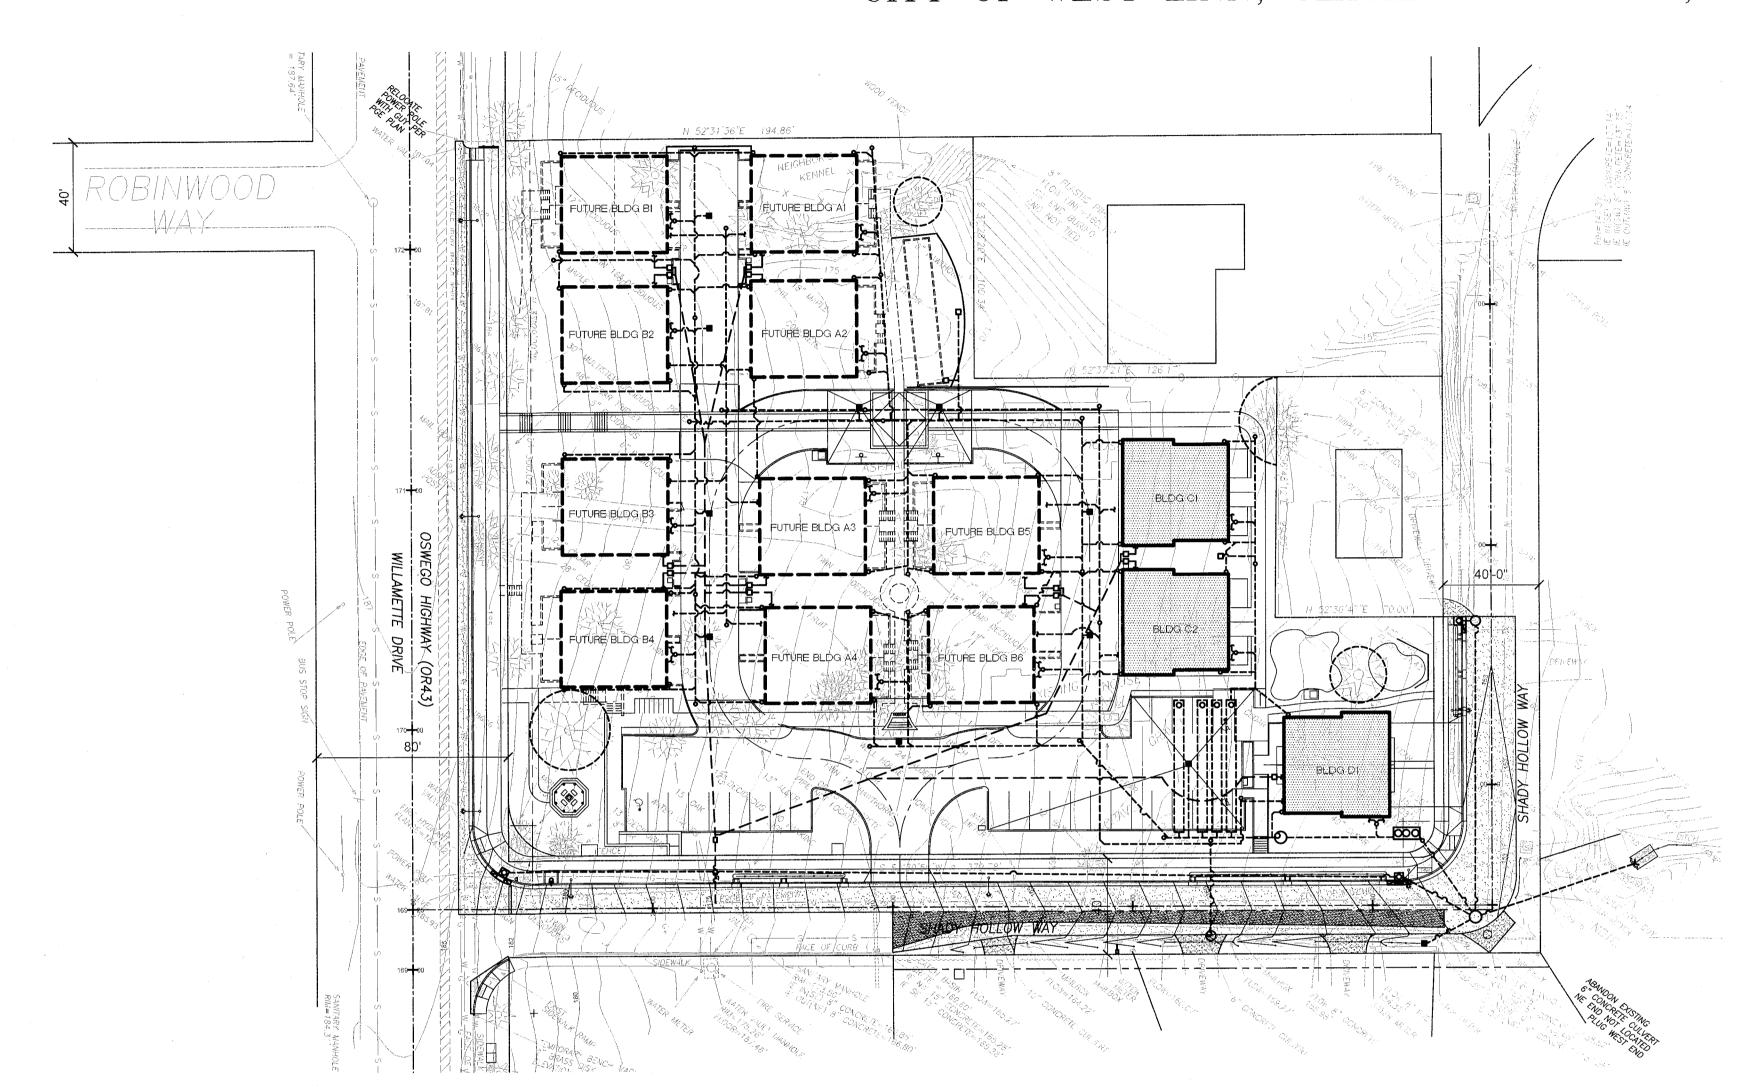

OVERALL SITE PLAN

GM GAS METER

ص UTILITY POLE

GUY ANCHOR

♥ LIGHT POLE

--- TRAFFIC SIGN

MB MAIL BOX

ELECTRIC METER

TELEPHONE PEDISTAL



### LEGEND:

FOUND MONUMENT AS NOTED

WATER LINE

WATER METER

G - NATURAL GAS LINE

WATER VALVE

SS - SANITARY SEWER LINE

FIRE HYDRANT

G - NATURAL GAS LINE

STORM DRAINAGE LINE

IRRIGATION CONTROL BOX

G - NATURAL GAS LINE

STORM DRAINAGE LINE

UNDERGROUND TELECOM. LINE

D STORM MANHOLE

XO.OGRND SPOT ELEVATION GROUND

CATCH BASIN

XO.OOEC SPOT ELEVATION EDGE OF CONCRETE

AREA DRAIN

XO.OOEP SPOT ELEVATION TOP OF ASPHALT


CONCRETE

CASS VALVE

XO.OOFFE SPOT ELEVATION FINISHED FLOOR

XO.OOTC SPOT ELEVATION TOP OF CURB

STATIONING ALONG OR43 IS BASED OFF OF RIGHT OF WAY MAP NO. 4B-5-1

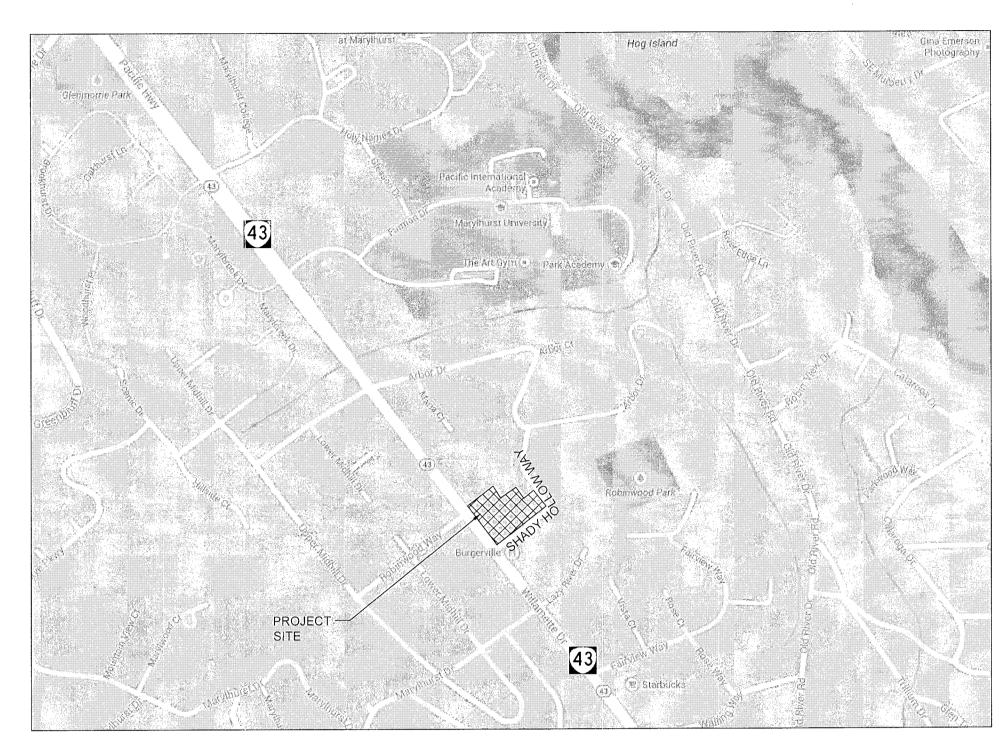

VICINITY MAP - CITY OF WEST LINN

SCALE: N.T.S.



INDEX OF CS SHEETS Sheet No. PUBLIC IMPROVEMENTS COVER SHEET PUBLIC IMPROVEMENTS STANDARD NOTES OSWEGO HIGHWAY (OR43) (WILLAMETTE DRIVE) IMPROVEMENTS CS2.0A OSWEGO HIGHWAY (OR43) (WILLAMETTE DRIVE) STRIPING PLAN ODOT STADARD DRAWINGS CS2.0C ODOT STADARD DRAWINGS CS2.0D ODOT STADARD DRAWINGS CS2.0E ODOT STADARD DRAWINGS ODOT STADARD DRAWINGS SHADY HOLLOW WAY PLAN & PROFILE SHADY HOLLOW WAY PLAN & PROFILE CS2.2 WDY SECTION DETAILS PUBLIC IMPROVEMENT DETAILS CS3.1 PUBLIC IMPROVEMENT DETAILS PUBLIC IMPROVEMENT DETAILS

STEWART GORDON STRAUS ARCHITEC 6775 SW 111TH AVENU SUITE 20 BEAVERTON, OR 97000 (503) 672-7517 (OFFICE

sgs@s-straus.com (e-mail

O W D Y

6443 SW Beaverton-Hillsdale Hwy, suite 2 Portland, Oregon 97221 ph:503.203.8111 fx:503.203.8122

THESE RECORD DOCUMENTS
HAVE BEEN PREPARED BASED
ON INFORMATION COLLECTED IN
THE FIELD BY WDY AND ALSO
INFORMATION PROVIDED BY THE
GENERAL CONTRACTOR. WDY
HAS NOT VERIFIED THE
ACCURACY AND/OR)
COMPLETENESS OF ALL
INFORMATION PROVIDED BY THE
GENERAL CONTRACTOR AND
SHALL NOT BE RESPONSIBLE
FOR ERRORS OR OMISSIONS

INFORMATION PROVIDED BY THE GENERAL CONTRACTOR AND SHALL NOT BE RESPONSIBLE FOR ERRORS OR OMISSIONS WHICH MAY BE INCORPORATED HEREIN AS A RESULT.

SHADY HOLLOW AND WILLAMETTE
WEST LINN, OREGON

**PROJECT** 1335 NUMBER: DATE BY DRAWING DESIGN 20 NOV 2013 S 11 FEB 2014 **DES REV** 12 MAR 2014 PERMIT 22 AUG 2014 PLAN CHECKS 21 OCT 2014 06 JAN 2015 23 JAN 2015 25 FEB 2015 16 MAR 2015 SHEET TITLE

COVER SHEET

SHEET # CS1.0

### GENERAL

- ALL WORK AND MATERIALS SHALL CONFORM TO THESE PLANS AND PROVISIONS OF THE CITY OF WEST LINN MINIMUM DESIGN STANDARDS FOR EXTENSIONS AND IMPROVEMENTS TO THE PUBLIC WATER AND SANITARY SEWER SYSTEM. IMPROVEMENTS DEPICTED ON THESE PLANS FORM THE INTENT OF COMPLYING WITH PUBLIC STREET AND PUBLIC STORM IMPROVEMENTS AS REQUIRED BY CITY OF WEST LINN. SEE SHEET SD4.0 FOR ADDITIONAL APPLICABLE CONSTRUCTION NOTES.
- THE CONTRACT DOCUMENTS, WHICH INCLUDE THE CITY OF WEST LINN STANDARDS DRAWINGS, AND ANY OTHER PERTINENT SPECIFICATIONS, PERMITS, REGULATIONS AND REQUIREMENTS UNIQUE TO THE PROJECT, WILL GOVERN THE WORK TO BE DONE. WHEN A PARTICULAR SPECIFICATION, REGULATION, OR REQUIREMENT IS REFERRED TO IN THE CONTRACT DOCUMENTS, SUCH REFERENCE SHALL BE TO CURRENT REVISIONS OR AMENDMENTS. ITEMS MENTIONED IN THE CONTRACT DOCUMENTS AND NOT SHOWN ON THE DRAWINGS OR STANDARD DETAILS SHALL BE OF LIKE EFFECT AS THOUGH SHOWN OR MENTIONED IN BOTH. SPECIFICATIONS AND DRAWINGS REFERRED TO IN ANY OF THE CONTRACT DOCUMENTS SHALL BE CONSIDERED AS BEING INCLUDED IN THE DOCUMENT IN WHICH SUCH REFERENCE IS
- 3. IN ORDER TO PROTECT UNDERGROUND FACILITIES, EXCAVATORS PERFORMING THE WORK SET FORTH ON THESE PLANS MUST COMPLY WITH THE PROVISIONS OF OREGON STATE LAW (REQUIRES CONTRACTOR TO NOTIFY UTILITIES AT LEAST 48 HOURS, BUT NO MORE THAN 10 BUSINESS DAYS, PRIOR TO ANY EXCAVATIONS.)
- 4. THE LOCATION OF EXISTING UTILITIES SHOWN ON THE PLANS IS APPROXIMATE AND SHOWN FOR INFORMATION PURPOSES ONLY. THE CONTRACTOR SHALL HAVE ALL UTILITIES LOCATED PRIOR TO COMMENCING CONSTRUCTION. NOTIFY ENGINEER OF ANY DISCREPANCIES PRIOR TO CONSTRUCTION. ADDITIONAL UNDERGROUND UTILITIES MAY EXIST.
- VERTICAL DATUM: REFER TO TOPOGRAPHIC SURVEY.
- TOPOGRAPHIC SURVEY BY: TOWNSHIP SURVEYING, INC., OREGON CITY, OR. THE CONTRACTOR SHALL CONTROL TRAFFIC THROUGH THE PROJECT SITE IN CONFORMANCE WITH THE LATEST EDITION OF "MANUAL ON UNIFORM TRAFFIC CONTROL DEVICES", "OREGON SUPPLEMENTS". THE CONTRACTOR SHALL AT ALL TIMES MAINTAIN LOCAL ACCESS FOR HOMEOWNERS AND BUSINESSES ALONG THE PROJECT SITE. ROAD CLOSURES ARE NOT ALLOWED.
- PRIOR TO ANY STREET WORK, THE CONTRACTOR MUST SUBMIT A TRAFFIC PLAN TO THE CITY TO REVIEW AND APPROVE. NO STREET WORK AFFECTING LANES OF TRAFFIC SHALL BEGIN PRIOR TO SUCH APPROVAL
- THE CONTRACTOR AND/OR SUB-CONTRACTOR SHALL HAVE A MINIMUM OF TWO (2) SETS OF APPROVED CONSTRUCTION PLANS ON THE JOB SITE AT ALL TIMES DURING THE CONSTRUCTION PHASES. ONE SET SHALL BE DEDICATED TO RECORDING "AS-BUILT" CONDITIONS. THE AS-BUILT MARKED SET SHALL BE RETURNED TO THE ENGINEER.
- 10. CONTRACTOR SHALL COORDINATE AND SCHEDULE ALL EARTHWORK, TRENCH BACKFILL AND ROAD CONSTRUCTION COMPACTION TESTS AND GEOTECHNICAL REVIEWS WITH THE PROJECT GEOTECHNICAL ENGINEERING OFFICE AS REQUIRED FOR ACCEPTANCE OF PROJECT WORK BY CITY OF WEST LINN AND AS REQUIRED BY THESE PLANS.
- 11. CONTRACTOR SHALL CAREFULLY MAINTAIN BENCHMARKS, PROPERTY CORNERS, MONUMENTS, AND OTHER REFERENCE POINTS. IF SUCH POINTS ARE DISTURBED OR DESTROYED BY CONSTRUCTION ACTIVITIES, THE CONTRACTOR SHALL PAY FOR THEIR REPLACEMENT BY EMPLOYING THE PROJECT'S PROFESSIONAL LAND SURVEYOR TO RESET PROPERTY CORNERS AND OTHER SUCH MONUMENTS.
- 12. PRIOR TO BEGINNING WORK, THE CONTRACTOR SHALL PRESENT A LIST AT THE PRECONSTRUCTION MEETING OF SUBCONTRACTORS, A PROJECT SCHEDULE, A TRAFFIC CONTROL PLAN AND A 24 HOUR PHONE NUMBER FOR CONTRACTOR CONTACT FOR EMERGENCIES.
- 13. FINAL CLEANUP PRIOR TO FINAL ACCEPTANCE AND PAYMENT, THE CONTRACTOR SHALL CLEAN THE WORK SITE AND ADJACENT AREAS OF ANY DEBRIS, DISCARDED ASPHALTIC CONCRETE MATERIAL OR OTHER ITEMS DEPOSITED BY THE CONTRACTOR'S PERSONNEL DURING THE PERFORMANCE OF THIS WORK.
- 14. THE CONTRACTOR SHALL, AS A MINIMUM, COORDINATE THE PROPOSED CONSTRUCTION ACTIVITIES WITH THE OWNER, NEIGHBORS AND THE LOCAL PUBLIC AGENCIES. UTLITIIES AND COMPANIES DURING CONSTRUCTION TO AVOID DAMAGE AND TO PREVENT THE INTERRUPTION OF SERVICES AND UTILITIES TO RESIDENTS AND
- 15. THE CONTRACTOR SHALL PROVIDE SUBMITTALS OF ALL MATERIALS AND ACCESSORIES TO THE ARCHITECT FOR REVIEW AND APPROVAL PRIOR TO SITE DELIVERY.
- 16. CONTRACTOR SHALL VERIFY ALL DIMENSIONS AND CONDITIONS ON DRAWINGS AND IN FIELD. NOTIFY OWNER'S REPRESENTATIVE OF ANY DISCREPANCIES PRIOR TO PROCEEDING WITH WORK.
- 17. EXISTING UTILITIES AND SITE INFORMATION SHOWN HEREON ARE BASED ON RECORD DRAWINGS PROVIDED BY OR MADE AVAILABLE BY THE OWNER. THE CONTRACTOR IS REQUIRED TO FIELD VERIFY THE LOCATION OF EXISTING FEATURES AND UTILITIES PRIOR TO CONSTRUCTION, AND SHALL ARRANGE FOR THE RELOCATION OF ANY IN CONFLICT WITH THE PROPOSED WORK. MINOR ADJUSTMENTS BASED ON FIELD CONDITIONS SHALL BE MADE BY THE CONTRACTOR AT NO ADDITIONAL COST TO THE
- 17. ALL CONSTRUCTION ACTIVITY SHALL BE DONE IN A SAFE AND NEAT MANNER AND UNDER OBSERVATION BY CITY FORCES.
- 18. THE CONTRACTOR SHALL BE SOLELY RESPONSIBLE FOR COMPLYING WITH ALL CONSTRUCTION SAFETY, HEALTH AND OTHER RULES AND REGULATIONS OF STATE AND LOCAL REGULATING AGENCIES FOR SAFETY AND INSTALLATION OF THE WORK INCLUDING BUT NOT LIMITED TO SHORING, BRACING, ERECTION / INSTALLATION, FALL PROTECTION, GUARDRAILS, ETC.
- 19. ALL TRENCH EXCAVATIONS SHALL BE PROPERLY SHORED AND BRACED TO PREVENT CAVING. UNUSUALLY DEEP EXCAVATIONS MAY REQUIRE EXTRA SHORING AND BRACING. ALL SHEETING, SHORING, AND BRACING OF TRENCHES SHALL CONFORM TO OREGON STATE REGULATIONS AND CITY OF THE DALLES CONSTRUCTION STANDARDS.
- 20. ALL UNDERGROUND UTILITIES SHALL BE INSTALLED PRIOR TO CONSTRUCTION OF CURBS, RETAINING WALLS, OR PAVEMENT.
- 21. CONTRACTOR TO REMOVE FROM SITE EXCESS SOIL OR OTHER MATERIALS NOT REUSABLE FOR THIS PROJECT, AND COMPLY WITH ALL RECOMMENDATIONS OF THE PROJECT GEOTECHNICAL REPORT.
- 22. APPROPRIATE BENCHING OF FILLS IS REQUIRED FOR FILLS OVER 5 FEET IN HEIGHT ON SLOPES IN EXCESS OF 5 HORIZONTAL TO 1 VERTICAL. THE CONTRACTOR SHALL ARRANGE FOR THE GEOTECHNICAL ENGINEER TO INSPECT EXCAVATED BENCHES PRIOR TO FILL PLACEMENT.
- 23. CUT AND FILL SLOPES SHALL BE PROTECTED FROM EROSION. SUCH CONTROL MAY CONSIST OF APPROPRIATE REVEGETATION OR OTHER ACCEPTABLE MEANS AND METHODS. EROSION CONTROL MEASURES SHALL BE IN PLACE PRIOR TO EARTHWORK OR SITE STRIPPING.
- 24. CRUSHED ROCK BASE MATERIAL AND PIPE ZONE MATERIAL SHALL BE CRUSHED ROCK CONFORMING TO OREGON DEPARTMENT OF TRANSPORTATION AND BE COMPACTED TO 95% OF MAXIMUM DENSITY AS DETERMINED IN ACCORDANCE WITH ASTM D1557.

- 25. 3/4 " 0" CRUSHED ROCK PIPE ZONE AND BACKFILL MATERIAL IS REQUIRED FOR ALL UTILITY LINES, CONDUITS AND LEVELING COURSES BELOW PAVEMENTS AND IN RIGHT-OF-WAYS. REFER TO THE TYPICAL TRENCH AND PAVEMENT DETAILS.
- 26. ASPHALTIC CONCRETE (A.C.) PAVEMENT SHALL BE A 12.5MM DENSE GRADED HOT MIX WITH A 5.8% MINIMUM ASPHALT CONTENT PER OREGON DOT CLASSIFICATION FOR ALL LIFTS. PAVEMENT SHALL BE PLACED ONLY ON DRY, CLEAN AND PROPERLY PREPARED SURFACES, AND WHEN CONDITIONS MEET THE SPECIFICATIONS AS SET FORTH IN THE MOST RECENT EDITION OF THE OREGON DOT SPECIFICATIONS. ALL NEW PAVEMENT AREAS SHALL CONFORM TO THE TYPICAL PAVEMENT SECTION DETAIL. ALL A.C. PAVEMENT TO BE COMPACTED TO 92% OF MAXIMUM DENSITY PER ASTM D2041 FOR SINGLE AND FIRST LIFTS AND 92% COMPACTION SHALL BE REQUIRED FOR SUBSEQUENT LIFTS.
- 27. ALL JOINTS BETWEEN A.C AND CONCRETE STRUCTURES MUST BE TACKED WITH
- BITUMASTIC. NO EXCEPTIONS ALLOWED. 28. ALL PORTLAND CEMENT CONCRETE PAVEMENT SHALL HAVE A 28 DAY MINIMUM ULTIMATE STRENGTH OF 4000 PSI. PROVIDE A MINIMUM OF (4) TEST CYLINDERS IN ACCORDANCE WITH CURRENT IBC AT EACH POUR.
- A. MINIMUM MIX REQUIREMENTS: CEMENT CONTENT PER YARD: 5 SACKS.
- II. MAXIMUM WATER/CEMENT RATIO: 0.45. FLY ASH MEETING ASTM C618 AND WITH LOSS ON IGNITION LESS THAN 3% MAY BE ADDED TO THE CEMENT, BUT NOT MORE THAN 15% BY WEIGHT.
- III. SLUMP: 3 INCH TO 4 INCH. DEVIATING FROM DESIGN SLUMP +1/2 INCH TO -1 INCH. WHEN CONCRETE IS TO BE PUMPED, ADD PLASTICIZERS MEETING ASTM C494 AND PROVIDE A NEW MIX DESIGN. DO NOT ADD WATER.
- IV. ADMIX: PROVIDE WATER REDUCING ADMIX (MASTER BUILDERS) AND REDUCE WATER USED BY 10% MINIMUM FOR ALL SLABS. V. AIR ENTRAINMENT: PER ACI 301 AND 306 AT ALL EXTERIOR SLABS AND FLAT
- VI. ALL ADMIXTURES TO BE COMPATIBLE FROM SAME MANUFACTURER. B. PLACE AND CURE ALL CONCRETE PER ACI CODES AND STANDARDS

### 02.0 CLEARING AND GRUBBING

- ALL CONSTRUCTION AND MATERIALS WITHIN THE PUBLIC RIGHT-OF-WAY SHALL CONFORM TO THESE PLANS AND THE APPLICABLE REQUIREMENTS OF CITY OF WEST LINN, STATE OF OREGON.
- NOTIFY ARCHITECT 2 BUSINESS DAYS BEFORE COMMENCING WORK.
- CONTRACTOR SHALL REMOVE ALL TREES, SHRUBS, RUBBISH, AND MAN-MADE STRUCTURES INCLUDING BUT NOT LIMITED TO CONCRETE SLABS, WALLS, VAULTS, FOOTINGS, ASPHALTIC PAVED SURFACES, GRAVELED AREAS, SHED OR OTHER FREE-STANDING BUILDINGS (CONSTRUCTED OF WOOD, CONCRETE, METAL, ETC.) FOUNDATIONS, FENCES, RAILINGS, MACHINERY, ETC. WITHIN THE CLEARING LIMITS. THE ITEMS LISTED ABOVE SHALL BE DISPOSED OF OFF-SITE. IT SHALL BE THE CONTRACTORS RESPONSIBILITY TO CONFIRM THE NUMBER AND TYPE OF STRUCTURES TO BE REMOVED. CONTRACTOR SHALL OBTAIN ALL NECESSARY DEMOLITION AND WORK PERMITS.
- 4. ALL BURIED STRUCTURES (I.E. TANKS, LEACH LINES, DRAIN TILE, AND PIPES) NOT DESIGNATED TO REMAIN ON THE SITE, SHALL BE REMOVED AND THE RESULTING EXCAVATIONS SHALL BE PROPERLY INSPECTED, BACKFILLED AND COMPACTED PRIOR TO ANY GRADING OR FILLING OPERATIONS. THIS IS TO INCLUDE STUMPS AND ROOTBALLS OF TREES TO BE REMOVED FROM THE SITE. NOTIFY CITY FOR INSPECTIONS AS REQUIRED.
- THE AREA OF THE SITE DESIGNATED ON THE PLAN TO BE REGRADED OR PAVED SHALL BE STRIPPED TO REMOVE ALL ORGANIC MATERIAL DOWN TO FIRM SUBGRADE. THE CONTRACTOR SHALL BE RESPONSIBLE FOR PROTECTING SUBGRADE SOILS FROM OVERWORKING AND PROVIDE REPAIR TO DAMAGED SUBGRADE AT NO ADDITIONAL COST TO THE OWNER.
- ALL UNSUITABLE MATERIAL (SOIL AND VEGETATION) REMOVED DURING THE CLEARING AND GRUBBING OPERATIONS SHALL BE REMOVED BY THE CONTRACTOR AND LEGALLY DISPOSED OF IN A SUITABLE LOCATION OFFSITE.
- EXCAVATORS MUST COMPLY WITH ALL PROVISIONS OF ORS 757.541 TO 757.571 INCLUDING NOTIFICATION OF ALL OWNERS OF UNDERGROUND FACILITIES AT USA LOCATES (681-7044), AT LEAST 48 BUSINESS HOURS, BUT NOT MORE THAN 10 BUSINESS DAYS BEFORE COMMENCING AN EXCAVATION.
- 8. ALL EMBANKMENTS REQUIRED SHALL BE STRUCTURAL FILL MEETING THE REQUIREMENTS AND SPECIFICATIONS OF IBC CHAPTER 18.
- 9. ALL EXCESS MATERIAL NOT UTILIZED ON-SITE SHALL BE LEGALLY DISPOSED OF BY THE CONTRACTOR
- 10. TREES NOT DESIGNATED TO BE REMOVED BY THE ARCHITECT SHALL BE PROTECTED AT ALL TIMES. 11. SAWCUT STRAIGHT LINES TO MATCH EXISTING PAVEMENT WITH THE NEW PAVEMENT.
- 12. CONTRACTOR SHALL PROVIDE AND MAINTAIN ADEQUATE TRAFFIC CONTROL ALONG THE EXISTING ROADS AS REQUIRED BY THE CITY OF WEST LINN.

### PUBLIC STREET

- 1. ALL MATERIAL AND WORKMANSHIP SHALL CONFORM TO THE CURRENT REQUIREMENTS OF CITY OF WEST LINN "CONSTRUCTION STANDARDS FOR PUBLIC WORKS FACILITIES", AND THE MOST CURRENT EDITION OF THE OREGON CHAPTER APWA SPECIFICATIONS.
- CONTRACTOR SHALL NOTIFY THE ENGINEER AND THE CITY OF WEST LINN 24 HOURS BEFORE STARTING CONSTRUCTION OR RESUMING WORK AFTER SHUTDOWNS. EXCEPT FOR NORMAL RESUMPTION OF WORK FOLLOWING SATURDAYS, SUNDAYS, OR HOLIDAYS. CONTRACTOR SHALL ASSIST THE ENGINEER IN PREPARING AS-BUILT DRAWINGS.
- MARK ALL UTILITIES ON CURB WITH AN "S", "SD", AND "W" FOR SANITARY SEWER, STORM DRAIN AND WATER LATERALS.
- CONTROL STAKES ARE REQUIRED FOR ALL CURB LINES AND STREET CENTERLINES FOR CONSTRUCTION, AND MUST BE PROVIDED BY A SURVEYOR LICENSED IN THE STATE OF OREGON.
- SUB-BASE SHALL BE APPROVED BY THE CITY BEFORE PLACING THE BASE ROCK, BY CONDUCTING ON-SITE COMPACTION TESTS AS DEEMED NECESSARY BY THE CITY AND AS REQUIRED BY THE SPECIFICATIONS
- THE SUBGRADE SHALL BE APPROVED BEFORE PLACING THE ASPHALT BY CONDUCTING ON-SITE COMPACTION TESTS AS DEEMED NECESSARY BY THE CITY AND AS REQUIRED BY THE SPECIFICATIONS. ALSO, A DEFLECTION TEST(S) PERFORMED WITH A 10 YARD LOADED DUMP TRUCK WILL BE REQUIRED. THIS TEST MUST BE WITNESSED BY THE CITY AND SOILS ENGINEER. NO DEFLECTION IS ALLOWED AND ALL STREETS MUST BE TESTED.

7. COMPACTION TESTS OF AGGREGATE BASE MUST BE IN ACCORDANCE WITH ASSHTO, METHOD T-180 AND ACHIEVE A RELATIVE DENSITY OF 95%. OVER-EXCAVATION AND GEOTEXTILE FABRIC (MIRAFI 500X OR PRE-APPROVED EQUAL) WILL BE REQUIRED IF

THE SUBGRADE IS SOFT OR UNSUITABLE OR NOTED ON THE PLANS.

- 8. ASPHALTIC CONCRETE (A.C.) PAVEMENT SHALL BE A 12.5MM DENSE GRADED MIX PER OREGON DOT CLASSIFICATION (FORMERLY CLASS C) FOR ALL LIFTS. PAVEMENT WILL BE PLACED ONLY ON DRY, CLEAN AND PROPERLY PREPARED SURFACES, AND WHEN THE CONDITIONS MEET THE SPECIFICATIONS AS SET FORTH IN THE MOST RECENT EDITION OF THE OREGON DOT SPECIFICATIONS. ALL A.C. PAVEMENT TO BE COMPACTED TO 92% OF MAXIMUM DENSITY PER ASTM D2041 FOR SINGLE AND FIRST LIFTS AND 92% FOR SUBSEQUENT LIFTS.
- 9. ALL JOINTS BETWEEN A.C AND CONCRETE STRUCTURES MUST BE TACKED WITH BITUMASTIC. NO EXCEPTIONS ALLOWED.
- ALL REQUIRED UTILITIES (SANITARY SEWER, STORM SEWER, WATER LINES, POWER TELEPHONE, GAS, STREET LIGHTS, ETC.) SHALL BE IN-PLACE AND THEIR LOCATIONS ACCURATELY LOCATED BY THE GENERAL CONTRACTOR ON "AS-BUILT" DRAWINGS. A FINAL INSPECTION BY CITY STAFF WILL BE REQUIRED TO VERIFY UTILITY CONDITION; AND IF DEFICIENCIES ON ANY OF THEM ARE NOTED, THEY MUST BE CORRECTED PRIOR TO PAVING.
- 11. AT ALL SAWCUT JOINTS OF AC PAVEMENT PROVIDE A CONTINUOUS HOT ASPHALT SEAL COAT WITH FULLY SANDED FINISH.

### PUBLIC STORM DRAIN

- 1. ALL STORM SEWER SYSTEM FITTINGS, EQUIPMENT AND MATERIAL SHALL CONFORM TO THE REQUIREMENTS OF THE CITY OF WEST LINN ENGINEERING DEPARTMENT.
- 2. PVC STORM DRAIN PIPE SHALL BE ASTM D3034, SDR-35. COMPATIBLE ASTM D3034 FITTINGS MUST BE USED WITH ASTM D3034 PIPE. ALL ASTM D3034 PIPE USED MUST BE OF WATER-TIGHT JOINTS TESTED FOR ROUNDNESS AFTER BACKFILL. PROVIDE PRESSURE TEST, MANDREL TEST AND TV VIDEO TAPE.
- DUCTILE IRON STORM DRAIN PIPE SHALL BE IN ACCORDANCE WITH AWWA C151, CLASS 52, ASTM 536, AND AWWA C104. JOINTS SHALL BE BELL AND SPIGOT WITH RUBBER GASKETS PER AWWA C111.
- STORM DRAIN LINES SHALL BE LAID IN A STRAIGHT ALIGNMENT AND UNIFORM GRADE BETWEEN MANHOLES OR OTHER JUNCTION STRUCTURES. CONTROL STAKES ARE REQUIRED FOR LOCATING NEW STORM DRAIN PIPE AND MUST BE PROVIDED BY A PROFESSIONAL LAND SURVEYOR REGISTERED IN OREGON.
- 5. ALL NEW STORM SEWER PIPES AND MANHOLES MUST BE THOROUGHLY CLEANED AND PRESSURE TESTED AS REQUIRED BY THE CITY. ALL TESTS MUST BE WITNESSED AND PASSED BY THE CITY PRIOR TO PLACING INTO OPERATION.
- 6. ALL CONNECTIONS TO EXISTING STORM SEWER MAINS REQUIRE ISSUANCE OF A
- PUBLIC WORKS PERMIT AND INSPECTION BY THE CITY PRIOR TO BACKFILLING. 7. ALL OTHER CONSTRUCTION PRACTICES (RELATING TO STORM SEWER) WITHIN THE CITY'S PUBLIC RIGHT-OF-WAY, NOT COVERED IN THESE "GENERAL REQUIREMENTS" AND/OR "CONSTRUCTION DETAILS" SECTIONS, MUST COMPLY WITH THE RULES AND REGULATIONS FOUND IN THE MOST RECENT EDITION(S) OF THE CITY OF WEST LINN

### EARTHWORK SPILLAGE AND DUST CONTROL

CONSTRUCTION STANDARDS.

- AVOID SOILS SPILLAGE AND CREATION OF DUST NUISANCE BY COVERING AND SECURING LOADS WHEN HAULING ON OR ADJACENT TO PUBLIC STREETS OR HIGHWAYS.
- TAKE PRECAUTIONS NECESSARY TO PREVENT EROSION AND TRANSPORTATION OF SOILS DOWNSTREAM. REMOVE SPILLAGE OR DUST AND SWEEP, WASH, OR OTHERWISE CLEAN PROJECT
- ADJACENT PROPERTIES, STREETS, HIGHWAYS, AND DOWNSTREAM DRAINAGE SYSTEMS.

### CONSTRUCTION INSPECTIONS AND MEETINGS

- 1. THE CONTRACTOR SHALL SCHEDULE A PRECONSTRUCTION MEETING WITH CITY PERSONEL, ALL SUBCONTRACTORS, PROJECT ARCHITECT, OWNER'S REPRESENTATIVE, PROJECT GEOTECHNICAL ENGINEER AND PROJECT CIVIL ENGINEER
- PRIOR TO BEGINNING PUBLIC IMPROVEMENT WORK. THE CITY SHALL BE NOTIFIED TO INSPECT ALL PUBLIC IMPROVEMENTS. THE CITY'S REPRESENTATIVES SHALL BE ALLOWED ACCESS TO ALL PARTS OF THE WORK, INCLUDING THE PLANS OF PRODUCERS AND FABRICATORS AT ALL TIMES; AND SHALL BE FURNISHED WITH EVERY REASONABLE FACILITY FOR ASCERTAINING WHETHER OR NOT THE WORK, AS PERFORMED, IS IN ACCORDANCE WITH THE REQUIREMENTS AND INTENT OF THE PLANS AND SPECIFICATIONS. THE CONTRACTOR SHALL FURNISH, AT THE CONTRACTOR'S OWN EXPENSE, SUCH SAMPLES AS ARE CUSTOMARILY REQUIRED FOR TESTING PURPOSES. THE CITY DOES NOT FURNISH FULL-TIME INSPECTION OF NEW PUBLIC IMPROVEMENTS. FOR THIS REASON, IT IS
- IMPERATIVE THAT THE OWNER AND/OR THE OWNER'S CONTRACTORS PROVIDE PROMPT AND COMPLETE NOTIFICATION TO THE CITY AS TO THE PROGRESS OF THE CONSTRUCTION OF UTILITY IMPROVEMENTS. NOTIFICATION MUST BE GIVEN TO THE CITY WHEN THE FOLLOWING WORK IS TO BE SCHEDULED AND AT OTHER TIMES AS INSTRUCTED BY CITY PERSONEL:
- A. PLACEMENT OF EROSION/SEDIMENTATION CONTROLS.
- B. UNDERGROUND UTILITY TRENCHING AND CONDUIT PLACEMENT. C. COMPACTION TESTING/PROOF ROLL OF TRENCH BACKFILL AND FILL AREAS.
- D. ALL TESTING OF UTILITY CONDUITS AND APPURTENANCES. E. CONSTRUCTION OF CONCRETE STRUCTURES (CURBS, INLETS, MANHOLES,
- SIDEWALKS, DRIVEWAYS, ETC.).
- F. PLACEMENT AND COMPACTION OF ASPHALTIC PAVEMENT.
- FAILURE TO GIVE PROPER NOTIFICATION (24 HOURS) OF WORK SCHEDULE MAY INVALIDATE THE WORK PERFORMED AND MAKE NECESSARY REMOVAL OF WORK, AND/OR TESTS AND INSPECTION REPORTS BY AN INDEPENDENT TESTING LABORATORY TO CONFIRM COMPLIANCE WITH THE CONSTRUCTION PLANS AND SPECIFICATIONS. SUCH REMOVAL OF WORK AND TESTS SHALL BE FURNISHED AT THE EXPENSE OF THE CONTRACTOR.

### CIVIL ABBREVIATIONS

	CIVIL ABBREVIAT	IONS	
A. B.	ANCHOR BOLTS	HDPE	HIGH-DENSITY-POLYETHYLENE
ABBR A. C.	ANCHOR BOLTS ABBREVIATION ASPHALT CONCRETE	HORIZ H. P.	HORIZONTAL HIGH POINT
ACCDG	ACCORTING	HT	HEIGHT
A. D.	AREA DRAIN AMERICANS WITH DISABILITIES ACT	I.E.	INVERT ELEVATION
ADA	AMERICANS WITH DISABILITIES ACT	INFO	INFORMATION
A. F. F. AHD	ABOVE FINISH FLOOR AHEAD	INT I. R.	INTERIOR IRON ROD
AHD ALT APPX	ALTERNATE	JT.	JOINT
APPX	APPROXIMATELY	L	LENGTH
ARCH	ARCHITECTURAL	LBS OR # L.F.	POUNDS LINEAR FEET
A. R. V. B. C. R.	BEGIN CURB RETURN	L. F. LIN	LINEAR
BF	AHEAD ALTERNATE APPROXIMATELY ARCHITECTURAL AIR RELIEF VALVE BEGIN CURB RETURN BACKFLOW BUILDING BLOW-OFF BOTTOM BEGIN RETURN BACK OF SIDEWALK BETWEEN	LT	LEFT
BLDG	BUILDING	M. B.	MACHINE BOLT
B. 0. B0T	BUTTOM BUTTOM	MANUF MBR	MANUFACTURER MEMBER
B. R.	BEGIN RETURN	MAT'L	MATERIAL
B. R. B. S.	BACK OF SIDEWALK	MAX	MAXIMUM
BTWN BW	BETWEEN BACKWATER	mc or r	MECHANICAL TOINT
C. B.	CATCH RASIN	M.J. MH	MECHANICAL JOINT MANHOLE
C. I.	CAST IRON OR CURB INLET	MIN	MINIMUM
C. J.	COLD JOINI	( N)	NEW
C. L. CLR	CENTER LINE CLEAR	Ň. Ś.	NON SHRINK
CNTR	CENTER	N. T. S. O. C.	ON CENTER
CO	CLEANOUT	0. H. OR O. P. P.	OPPOSITE HAND
COL	COLUMN	0. W. S.	OIL WATER SEPARATOR
CONC CONN	CONCRETE CONNECTION	PL P. L.	PLATE
CONT	CONTINUOUS	P C	PROPERTY LINE POINT OF CURVATURE
COP	COPPER	P. C. C.	POINT OF COUNTER CURVATURE
C. O. T. G.	CLEAN OUT TO GRADE	PERF	PERFORATED
CPLG CULV	COUPLING CULVERT	PLY <b>W</b> D	PLYWOOD
	DALIBLE.	P. P. PROP	PRIMARY POWER/POWER POLE PROPOSED
D. C.	DOUBLE CHECK	PSF	POUNDS-PER-SQUARE-FOOT
DCDA	DOUBLE CHECK DETECTOR ASSEMBLY	P. T.	POINT OF TANGENCY
D. F.	DOUGLAS FIR	PVC P. U. E.	POLYVINYL-CHLORIDE PUBLIC UTILITY EASEMENT
D. I.	DUCTILE IRON OR DITCH INLET	P. W.	PUBLIC WORKS
DIA OR	DIAMETER	R OR RAD	RADIUS
DIB	DOUBLE CHECK DOUBLE CHECK DETECTOR ASSEMBLY DETAIL DOUGLAS FIR DUCTILE IRON OR DITCH INLET DIAMETER DIMENSION DIRECTION DITTO DOMESTIC DEEP DRAWING DOWN SPOUT DRY WELL DRIVEWAY EACH END CURB RETURN EXISTING GRADE EXPANSION JOINT ELEVATION ELECTRIC EMBEDMENT EDGE OF PAVEMENT ENGINEER OF RECORD EQUAL END RETURN EACH WAY EXISTING EXPANSION EXTERIOR FLANGED COUPLING ADAPTER FOUND	R. D.	ROOF DRAIN
DO DO	DITTO	REINF	REINFORCEMENT/REINFORCING
DOM	DOMESTIC	REQ D REHAR	REQUIRED REHABILITATION
DP DP DWC	DEEP	RDCR	REDUCER
DS DRWG	DOWN SPOUT	R. P.	RADIUS POINT
D. <b>W</b> .	DRY WELL	RT R/W or R.O.W.	RIGHT
D/W	DRIVEWAY	SCHED	SCHEDULE
EA	EACH STUDY	SED	SEDIMENTATION
E. C. R. F. G	END CURB RETURN  EXISTING GRADE	SERV	SERVICE
E. J.	EXPANSION JOINT	SHT	
EL OR ELEV	ELEVATION	SPECS	SIMILAR SPECIFICATIONS SQUARE
ELEC	ELECTRIC	SQ	SQUARE
F.O.P.	ENDERMENT	STD	STANDARD
E. O. R.	ENGINEER OF RECORD	STD S. S. STA ST. D. STIFF	SANITARY SEWER
EQ	EQUAL	ST. D.	STORM DRAIN
E.R.	END RETURN	STIFF	OTTIT LINEIN
EX OR EXIST	EXISTING	STL	STEEL
EXP	EXPANSION	SDWLK	STRUCTURAL SIDE <b>W</b> ALK
EXT	EXTERIOR	T. C.	TOP OF CURB
F. C. A. FD	FOUND	TELEP	TELEPHONE
r. D. C.	FIRE DEFARIMENT CONNECTION	T. 0. F.	TOP OF FOOTING TOP OF SLAB TOP OF WALL
FNDN	FOUNDATION	T. O. S. T. O. <b>W</b> .	TOP OF WALL
F. F. F. G.	FINISH FLOOR	TYP	TYPICAL UNDERGROUND ELECTRICAL UNLESS OTHERWISE NOTED UNDERGROUND POWER UNREINFORCED MASONRY
F. H.	FIRE HYDRANT	U. E.	UNDERGROUND ELECTRICAL
FIN	FINISH	U. U. N. II P	UNDERGROUND POWER
F. L.	FLOW LINE	U. R. M.	UNREINFORCED MASONRY
FLG FLR	FLANGE FLAOR	0. 1.	UNDERGROUND TELEPHONE
F. P.	FOUNDATION FINISH FLOOR FINISH GRADE FIRE HYDRANT FINISH FLOW LINE FLANGE FLOOR FINISH PAVEMENT FACE OF CURB FOOTING GAGE OR GAUGE GALVANIZED GRADE BREAK	V. B. VERT	VALVE BOX
F. O. C.	FACE OF CURB	VERT VLT	VERTICAL VAULT
FTG	FOOTING	W	WATER
GA GALV	GAGE OK GAUGE GALVANIZED	₩. J.	WET JOINT
G. B.	GRADE BREAK	W. M.	WATER METER
GEN	GENERAL	W. Q. W. W. F.	WATER QUALITY WELDED WIRE FABRIC
GR	GROUND SHOT	W/	WITH
G. S. G. S. P.	GROUND SHOT GALVANIZED STEEL PIPE	w/o	WITHOUT
GUT	GUTTER		
G. V.	GATE VALVE		

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PROJECT **NUMBER:** 

> DATE BY DRAWING DESIGN 20 NOV 2013

1335


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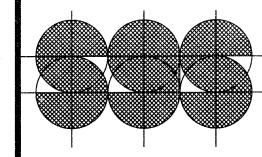
22 AUG 2014 PLAN CHECKS 21 OCT 2014 -06 JAN 2015

23 JAN 2015 25 FEB 2015 16 MAR 2015

SHEET TITLE **NOTES AND ABBREVIATIONS** 

SHEET #



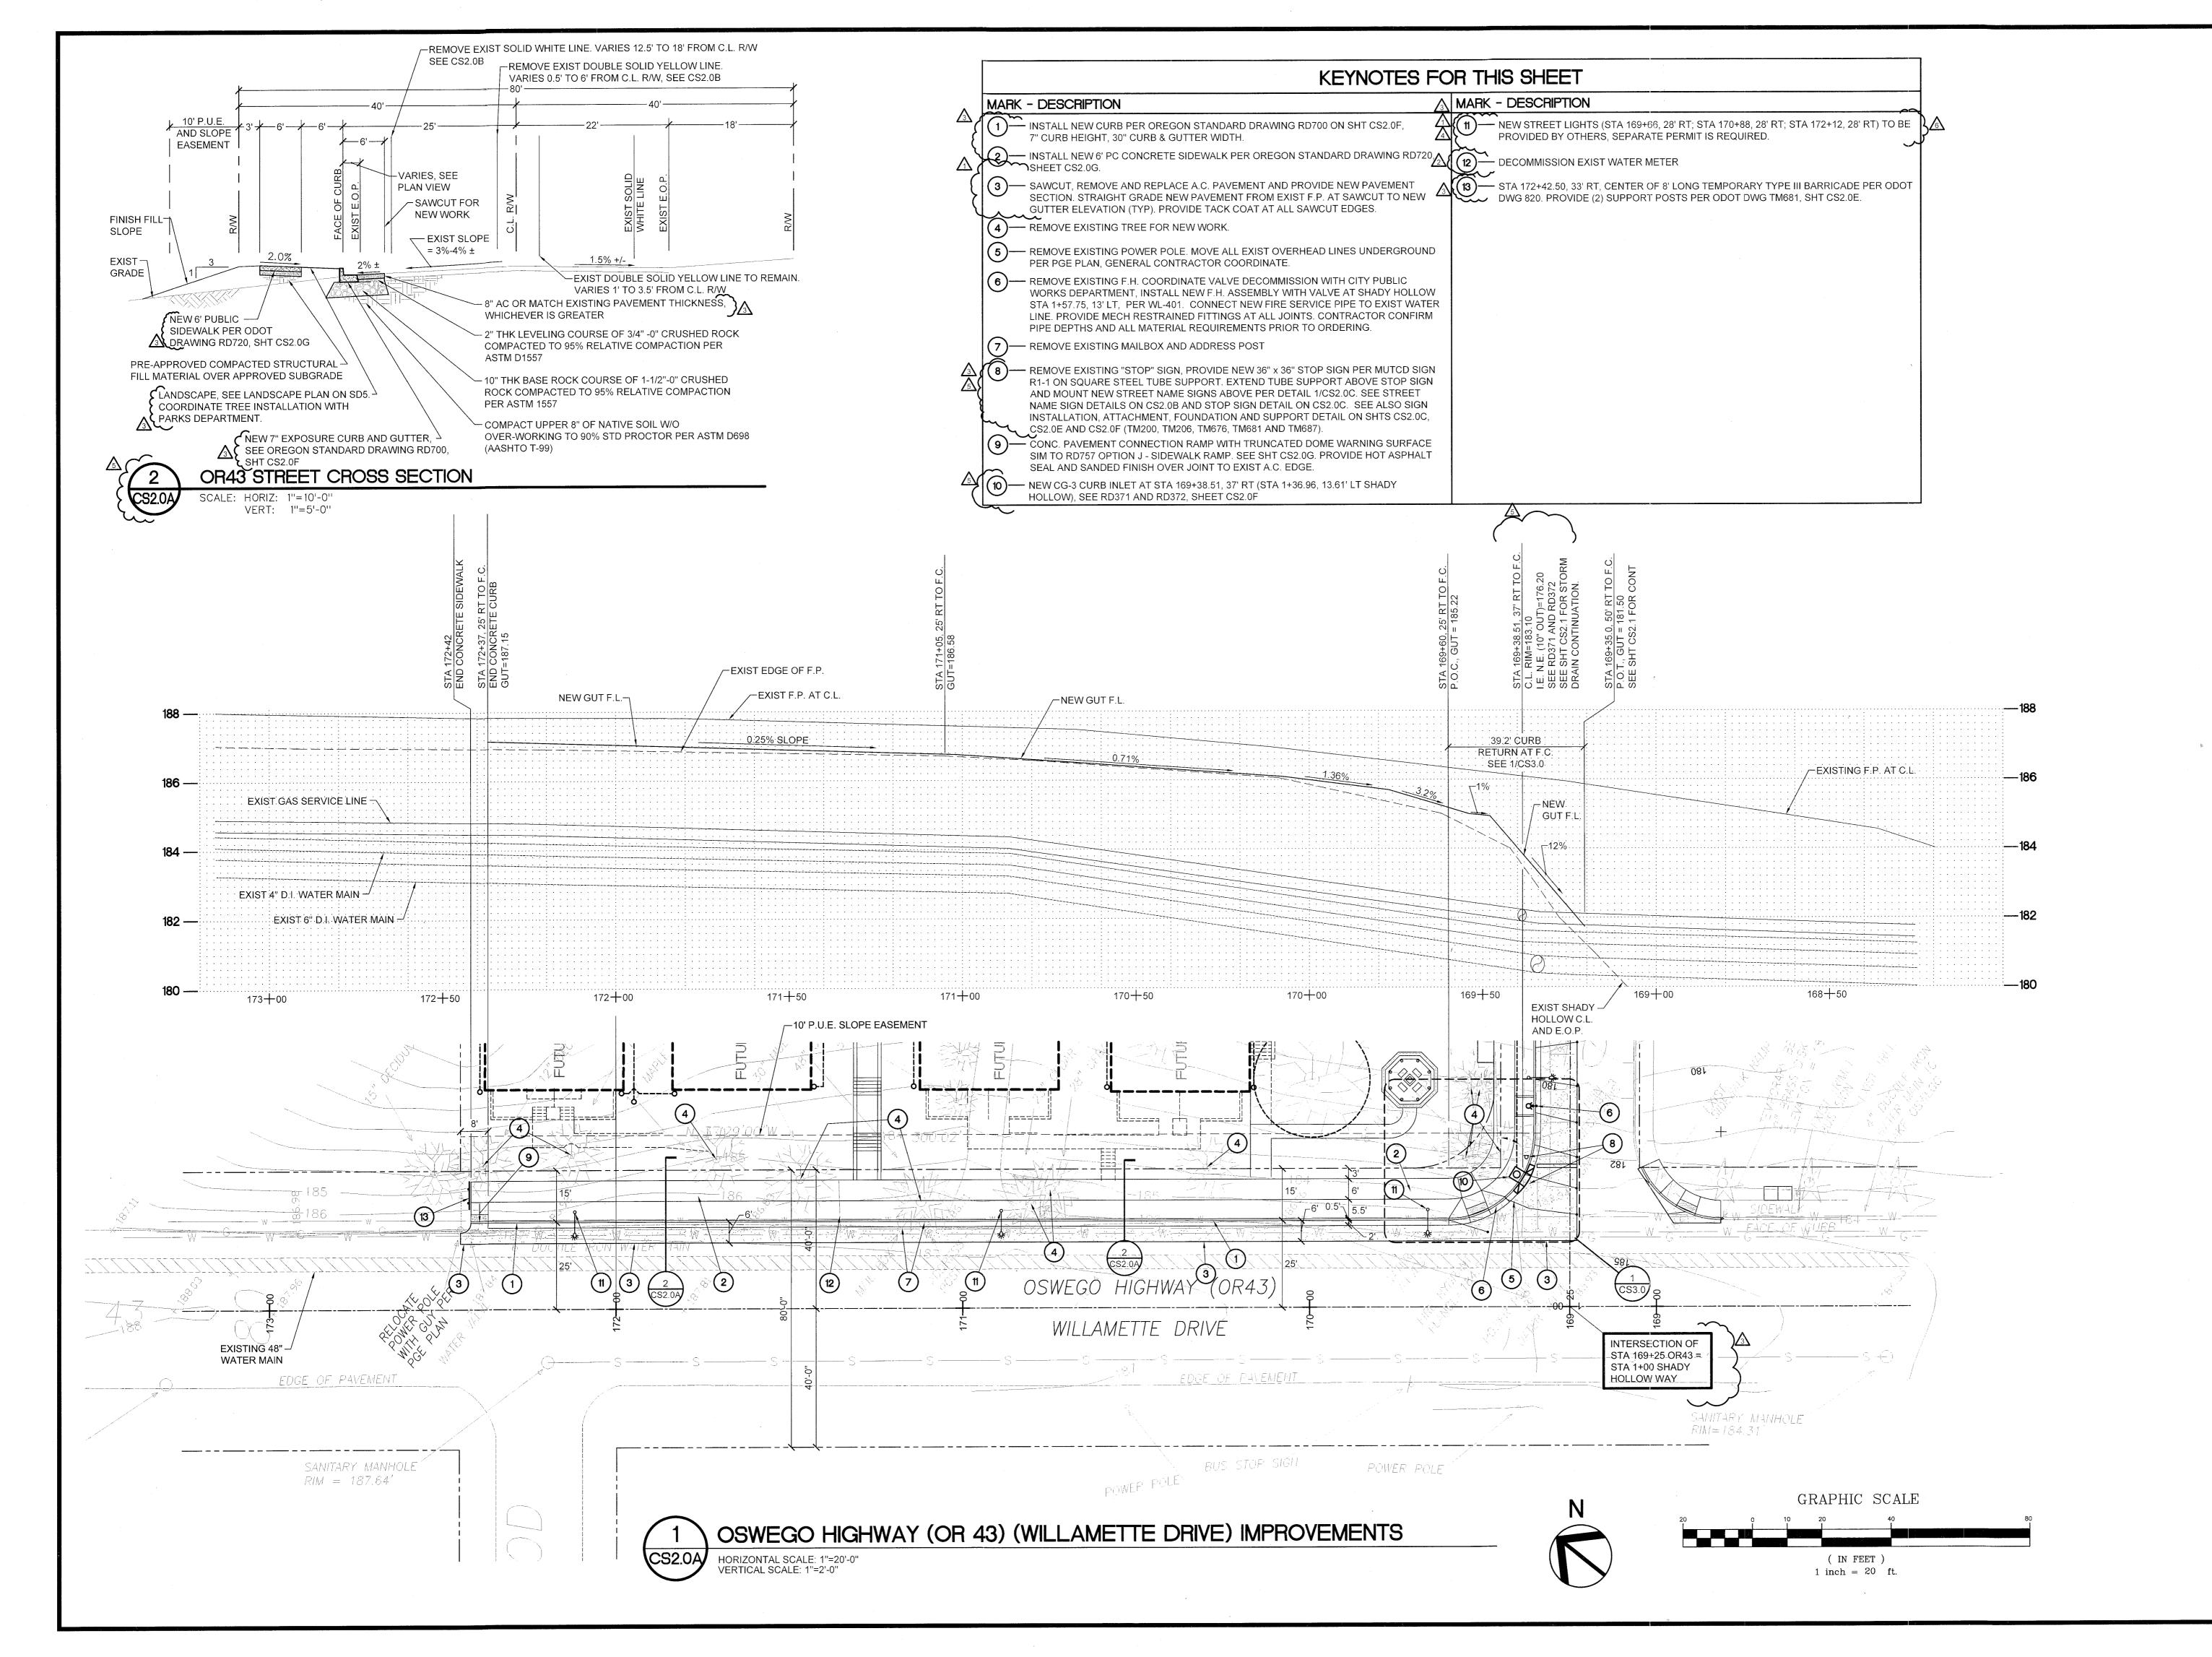

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(503) 672-7808 (FAX)

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HEREIN AS A RESULT.


SHADY HOLLOW AND WILLAMETTE DRIVE


PROJECT 1335 NUMBER: DATE BY DRAWING DESIGN 20 NOV 2013 11 FEB 2014 DES REV 12 MAR 2014 PERMIT 22 AUG 2014 PLAN CHECKS 21 OCT 2014 06 JAN 2015 23 JAN 2015 25 FEB 2015 16 MAR 2015 SHEET TITLE


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IMPROVEMENTS


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**PROJECT** NUMBER:


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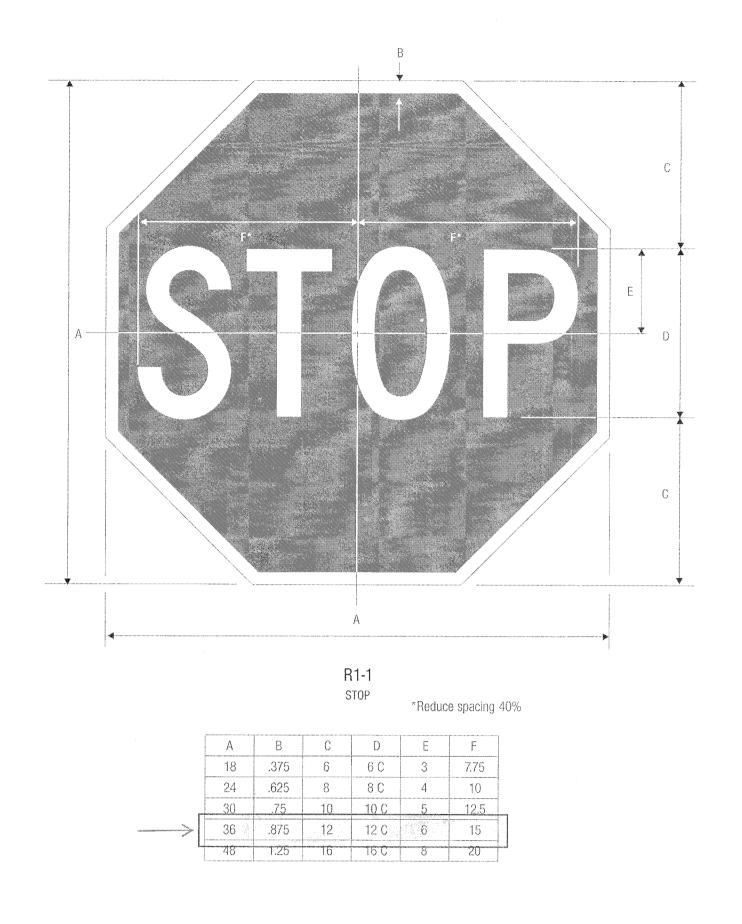
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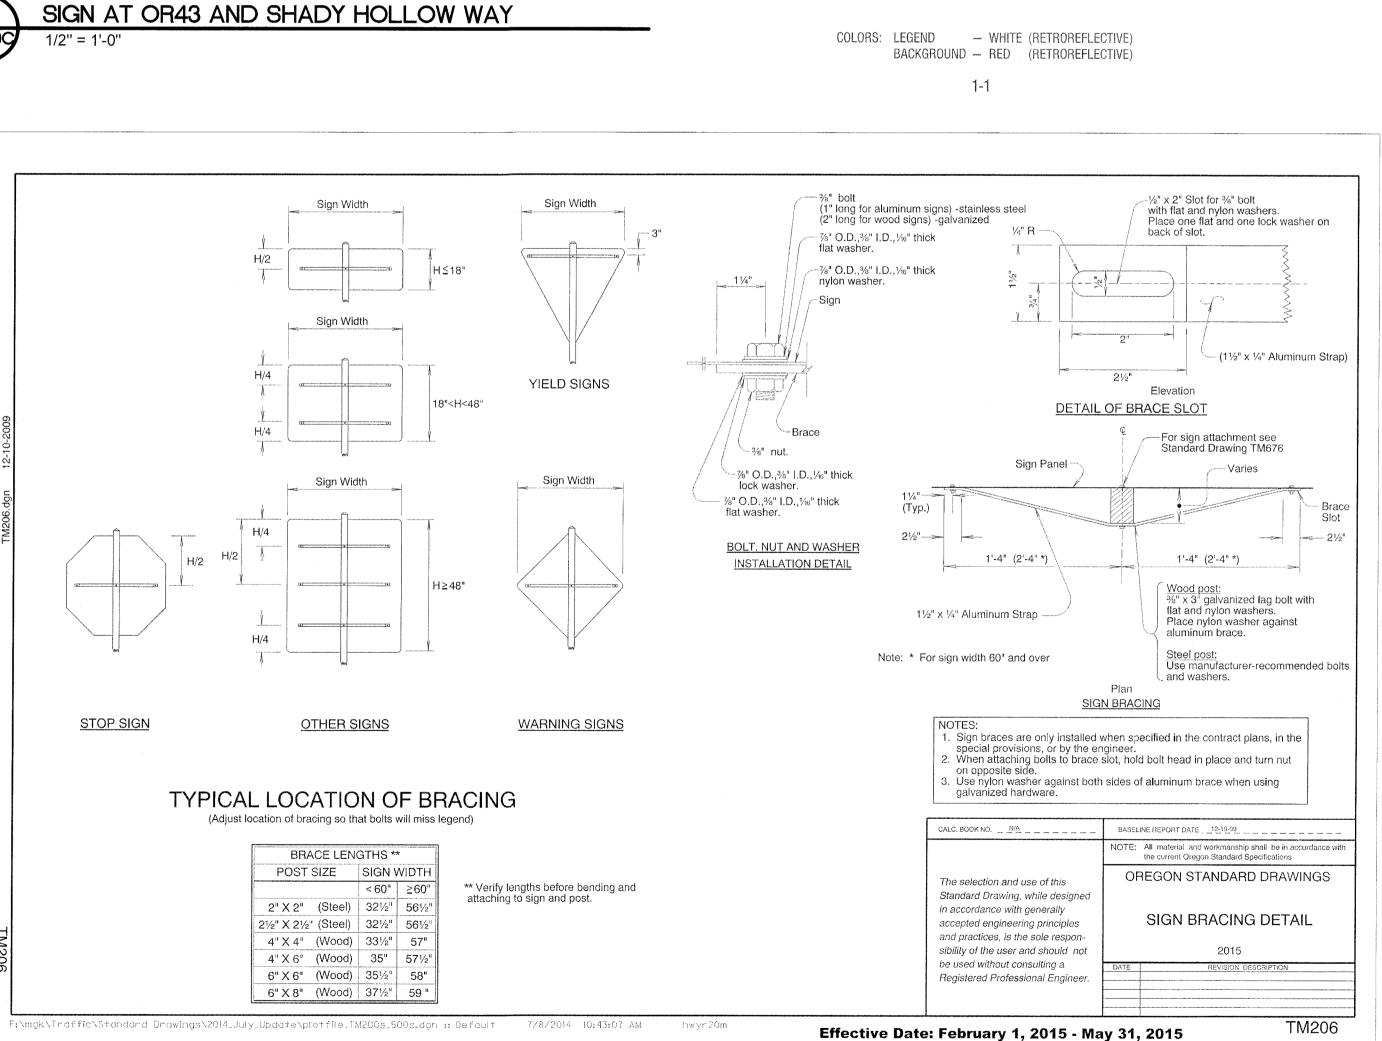
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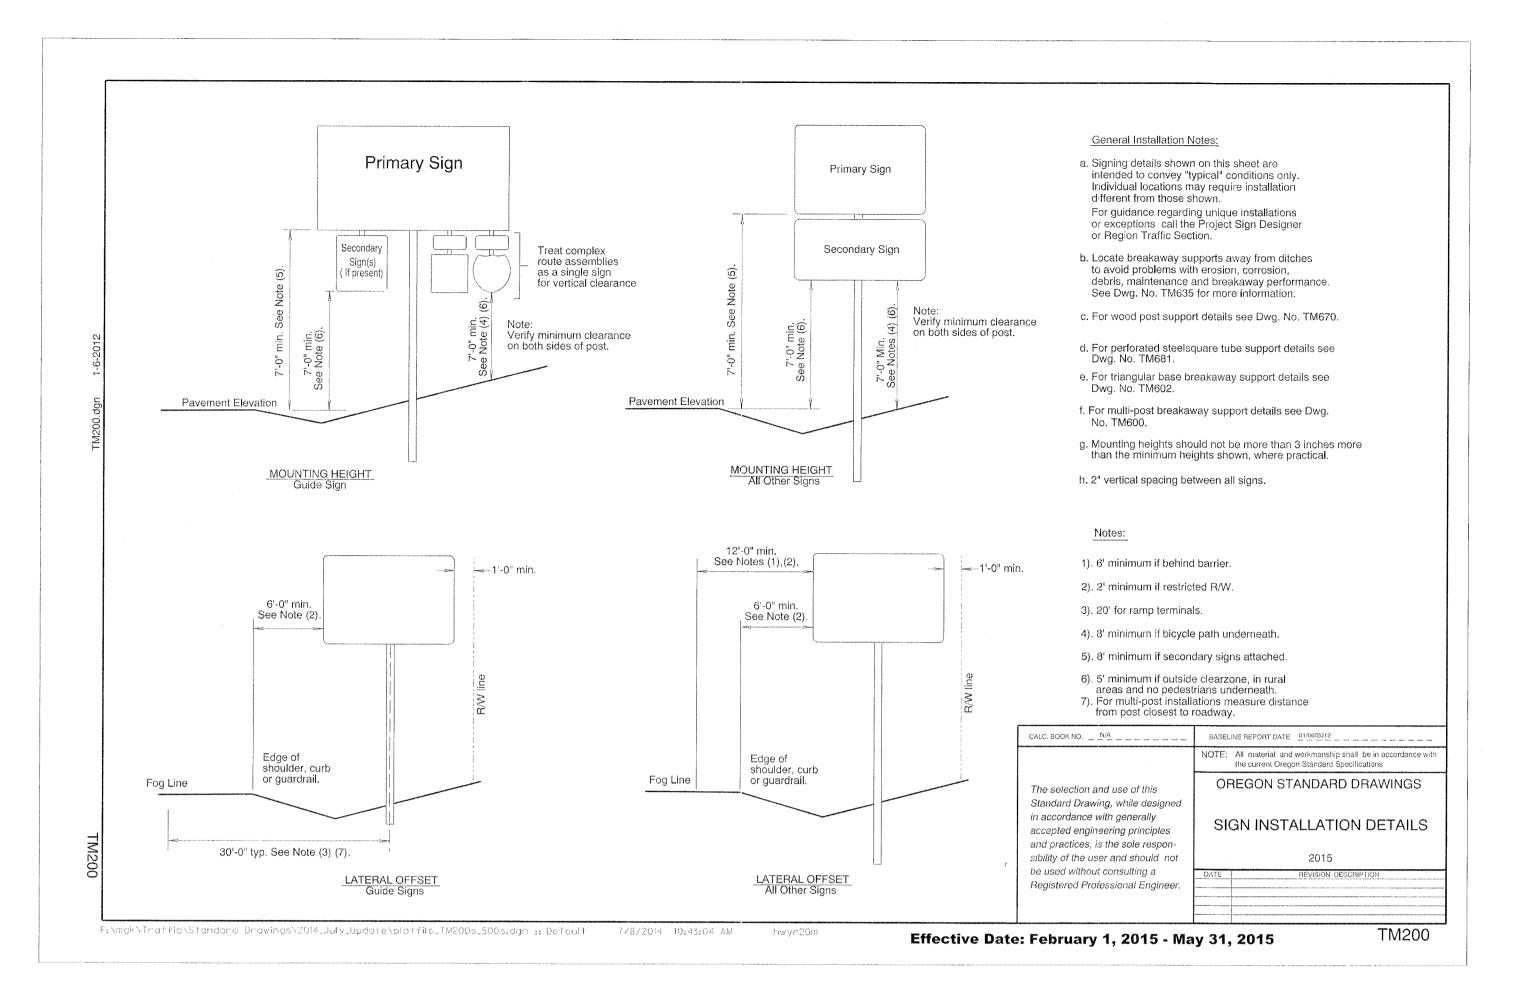
1 inch = 20 ft.

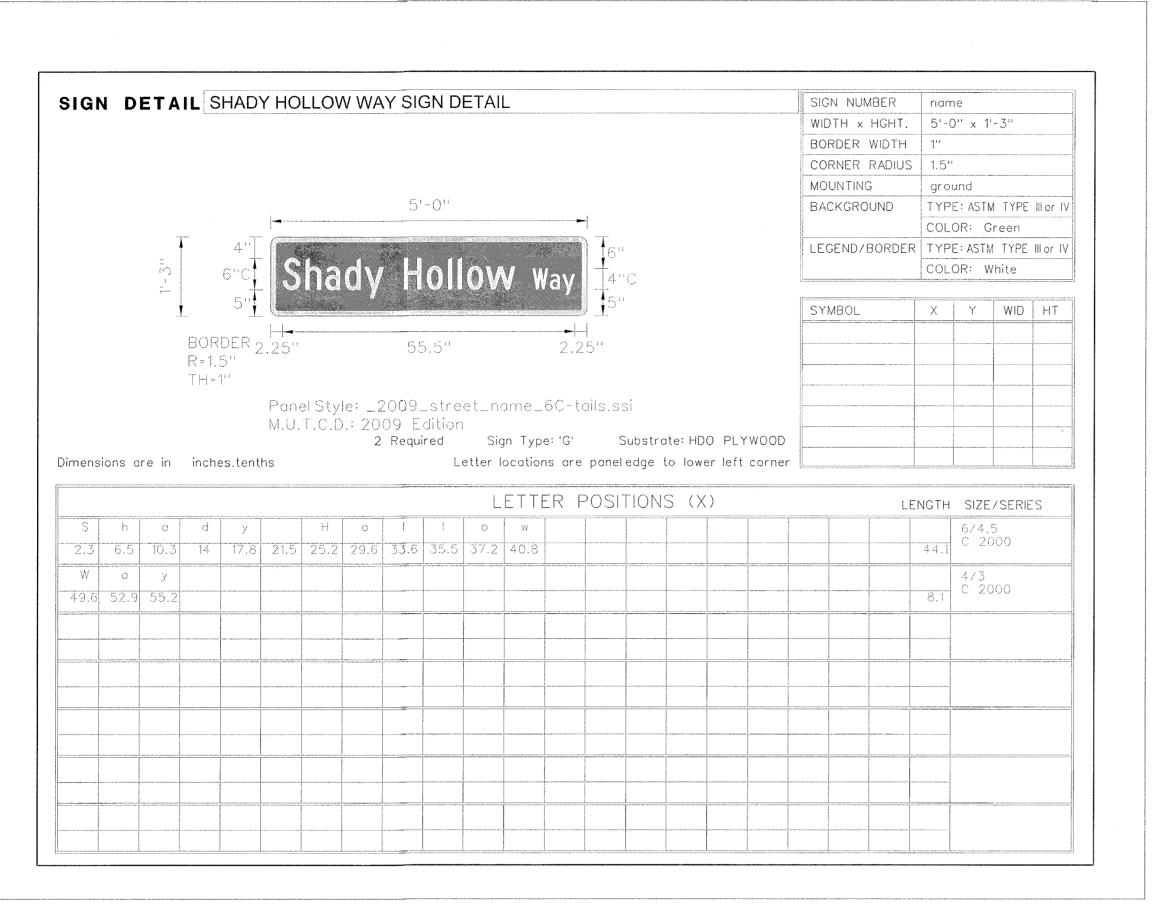
SHEET # CS2.0B

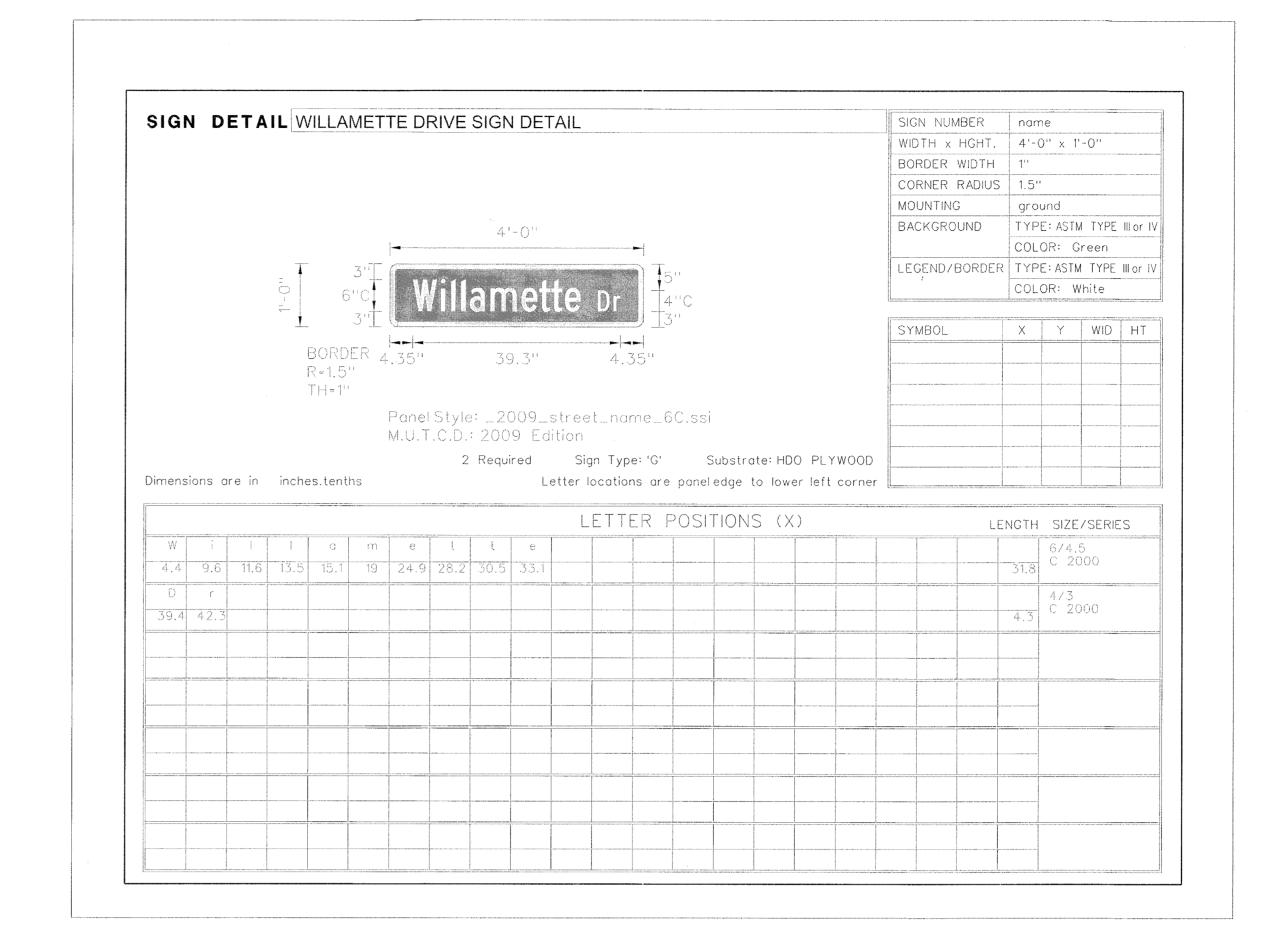


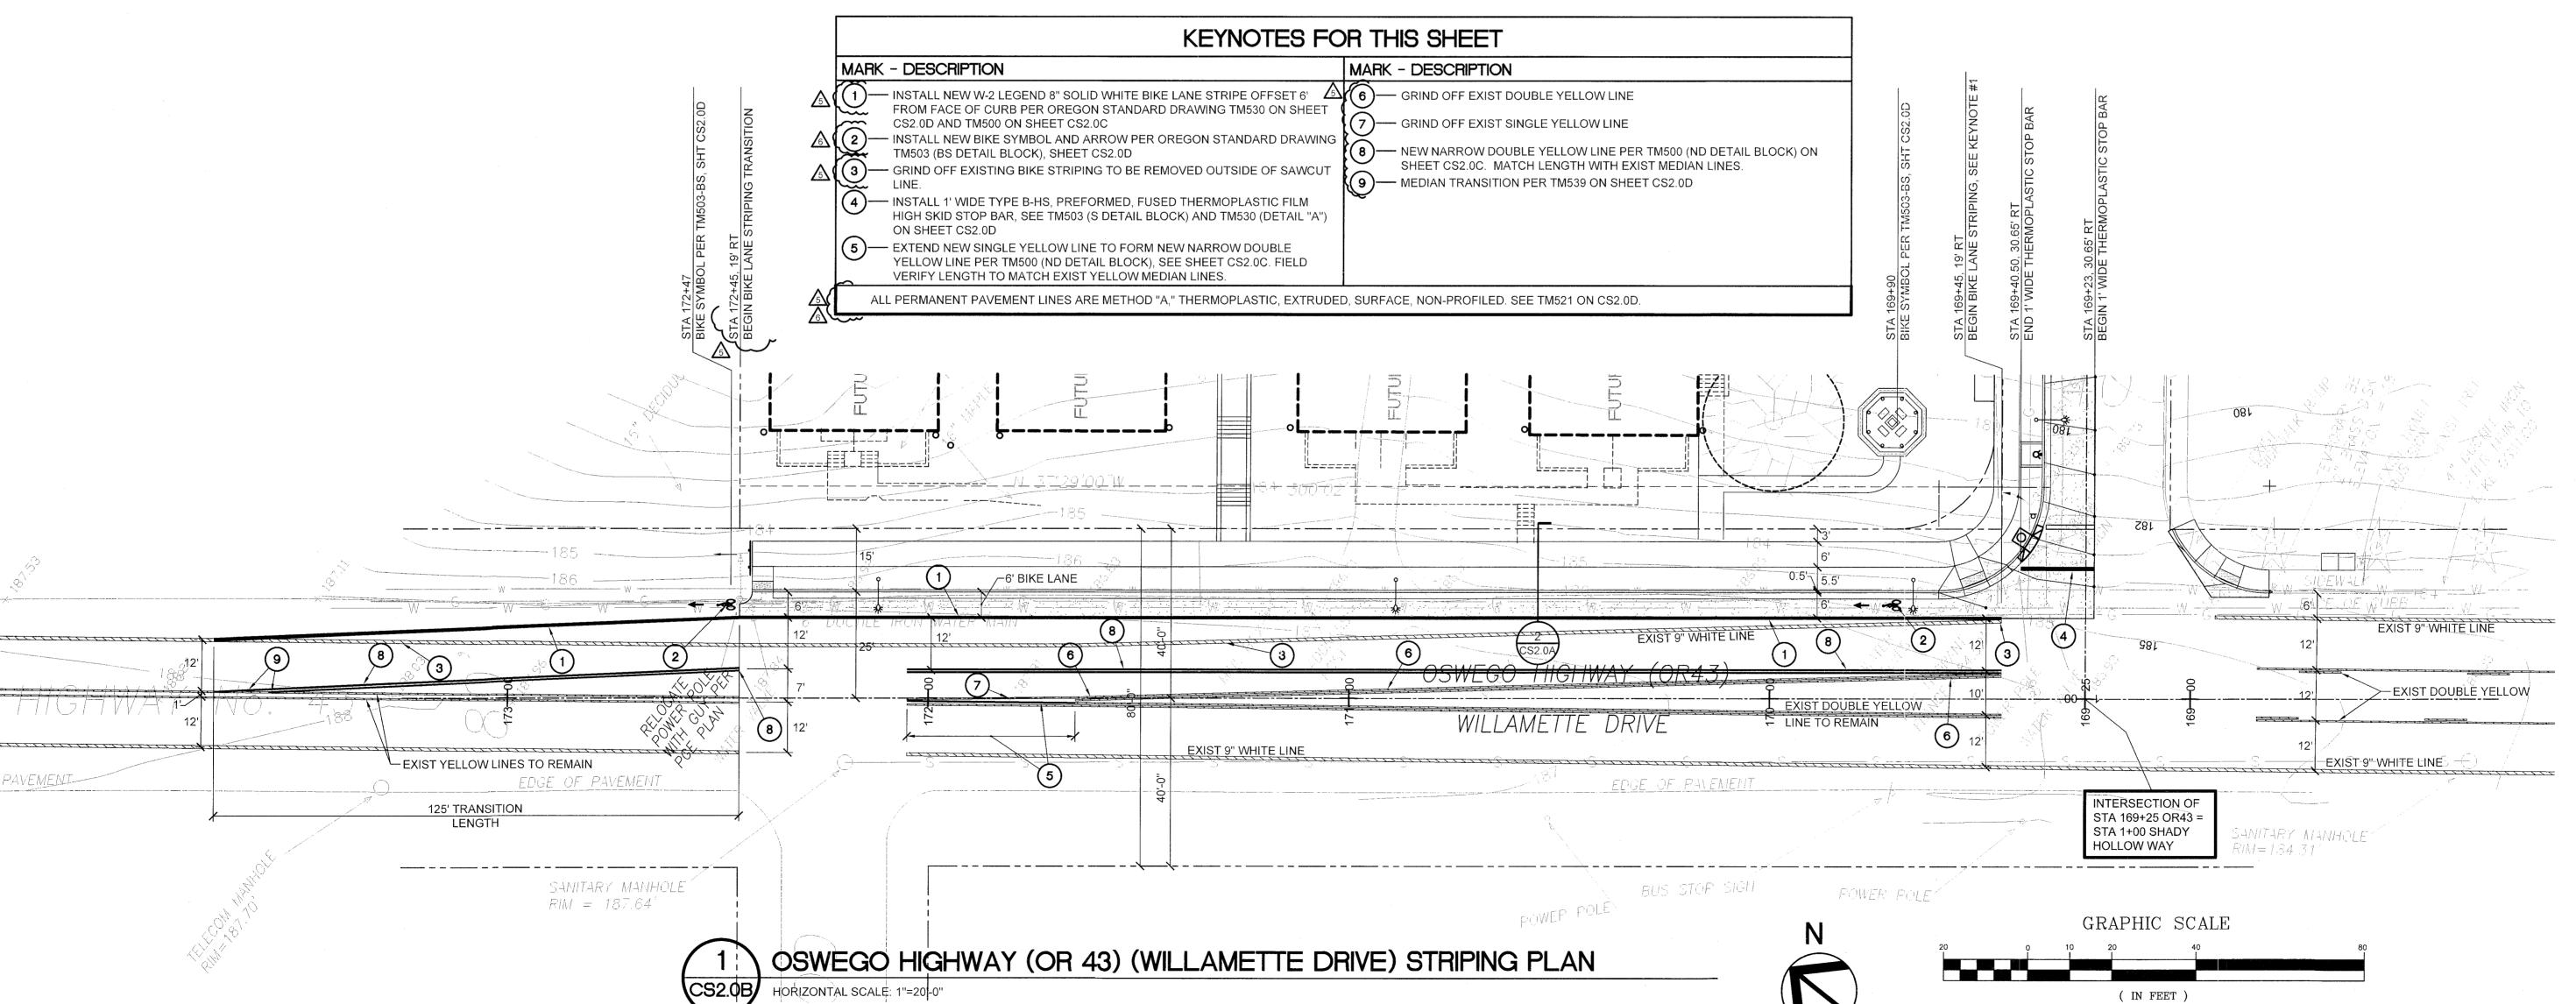

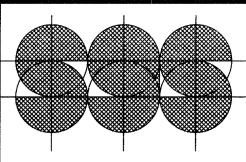

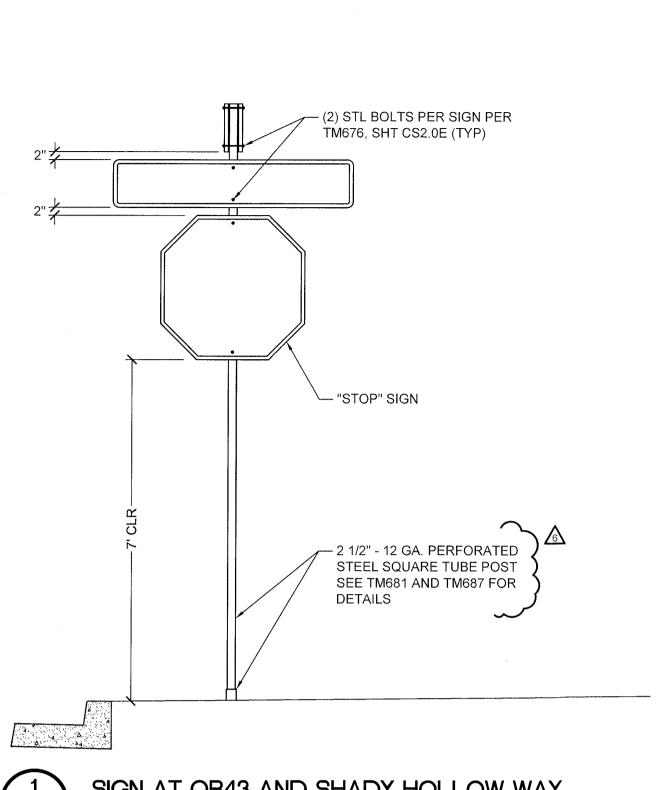

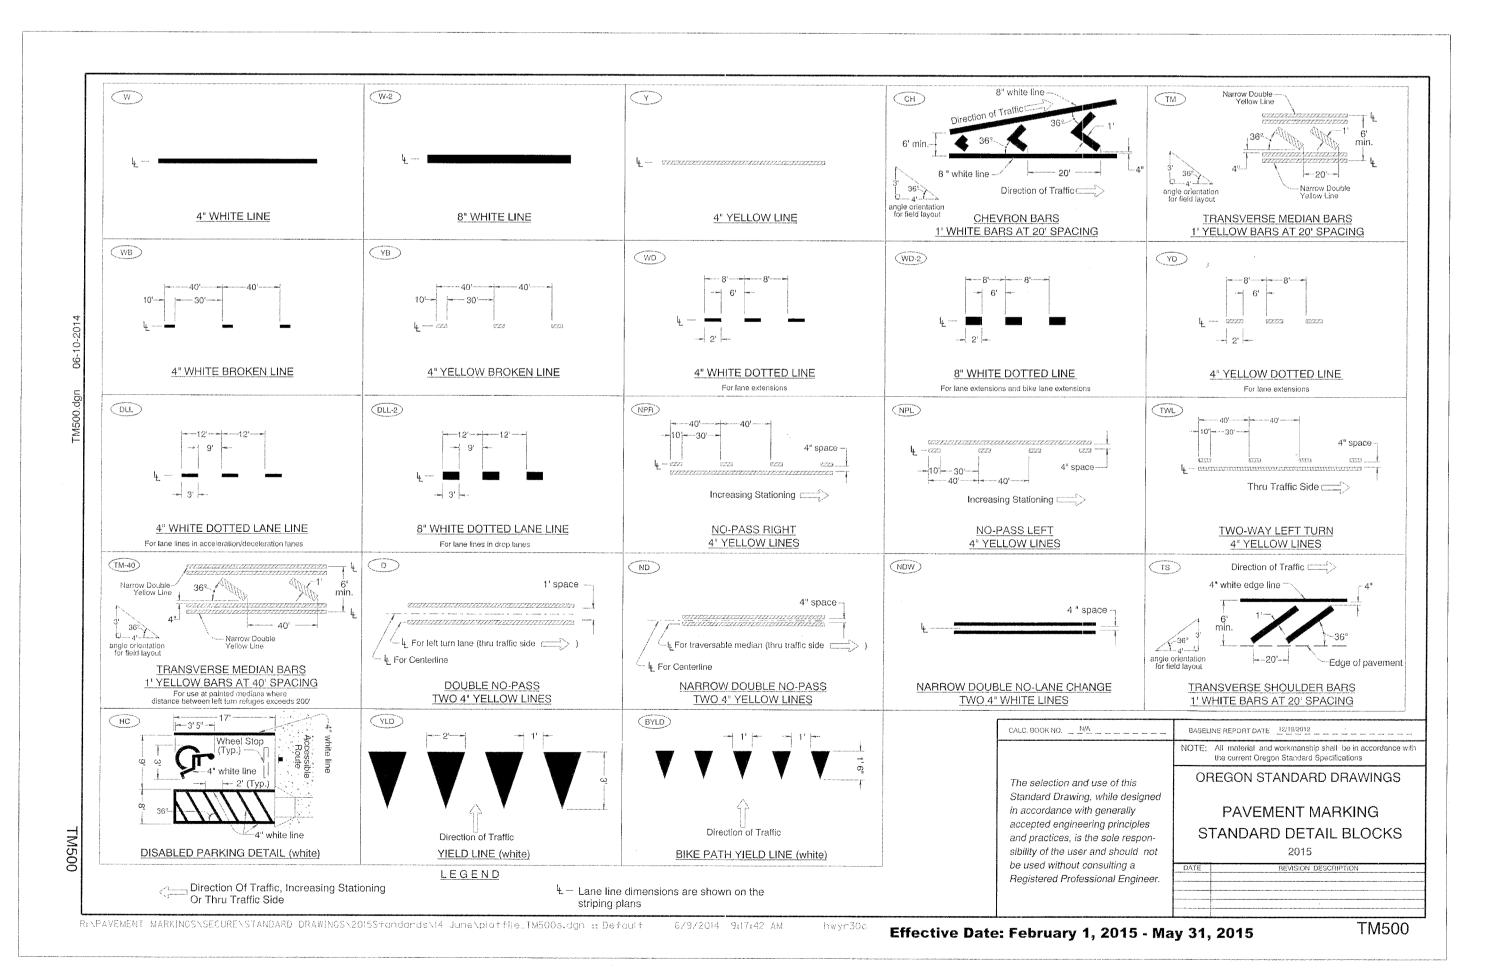

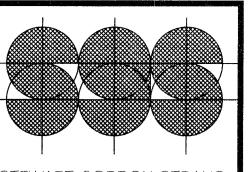

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ARCHITECT
6775 SW 111TH AVENUE
SUITE 20
BEAVERTON, OR 97008
(503) 672-7517 (OFFICE)

(503) 672-7808 (FAX)

sgs@s-straus.com (e-mail)

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SHADY HOLLOW AND WILLAMETTE DRIVE WEST LINN, OREGON

PROJECT NUMBER: 1335

DATE BY

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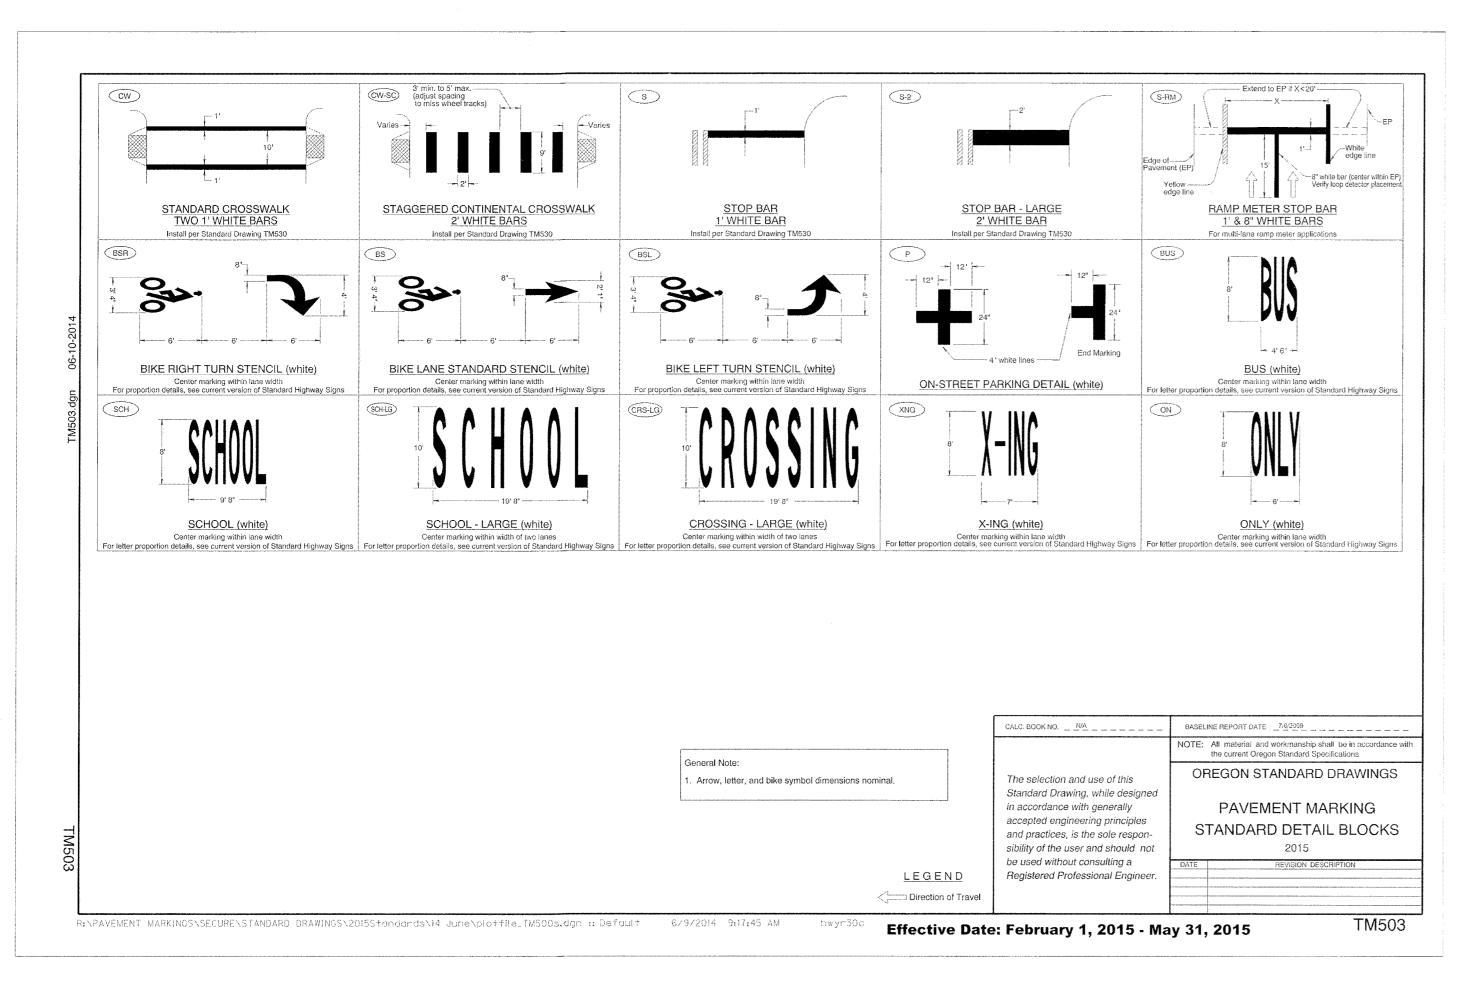
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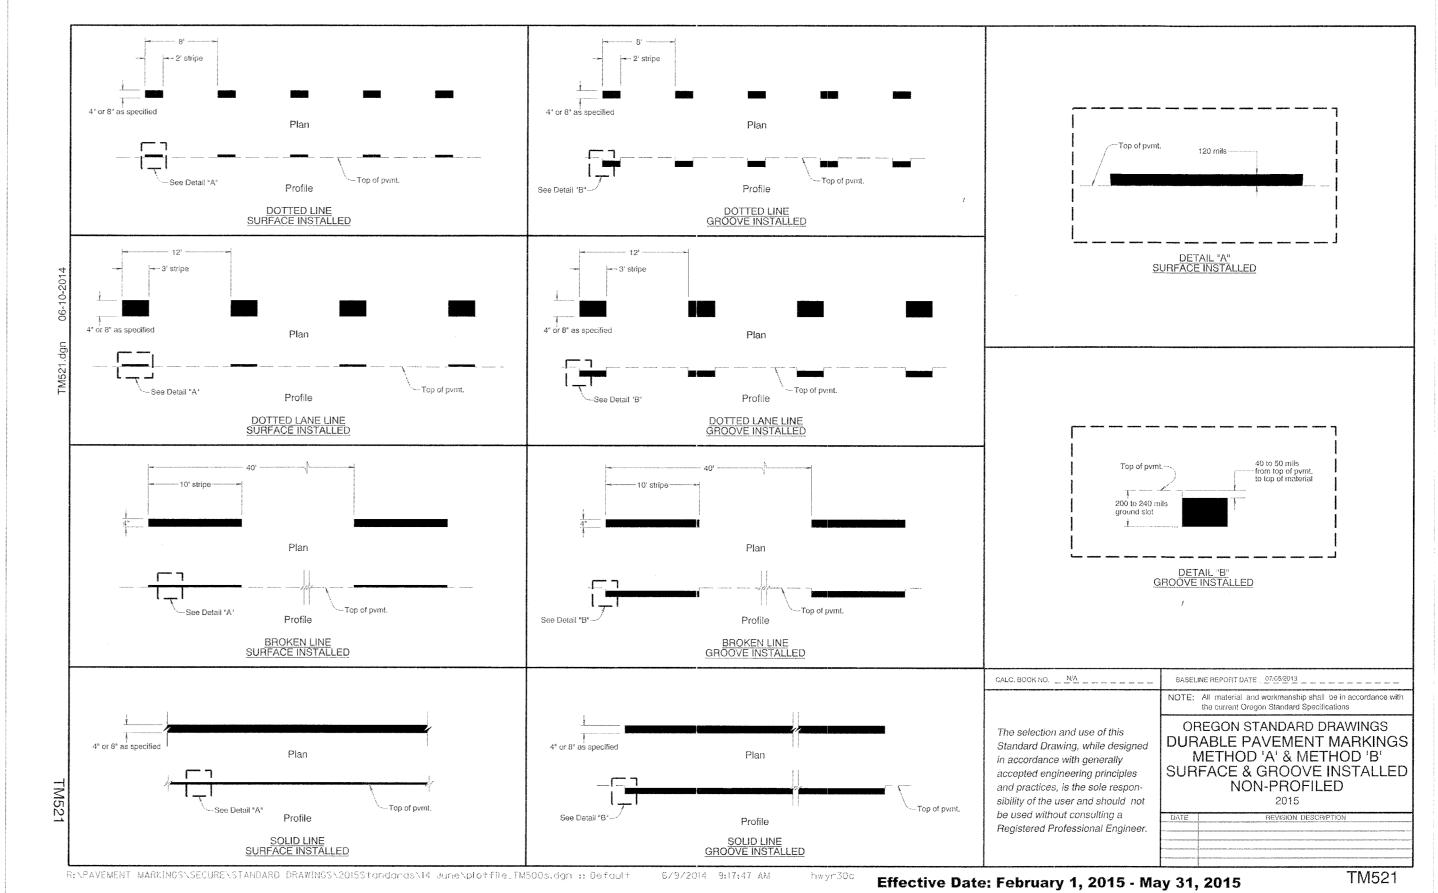
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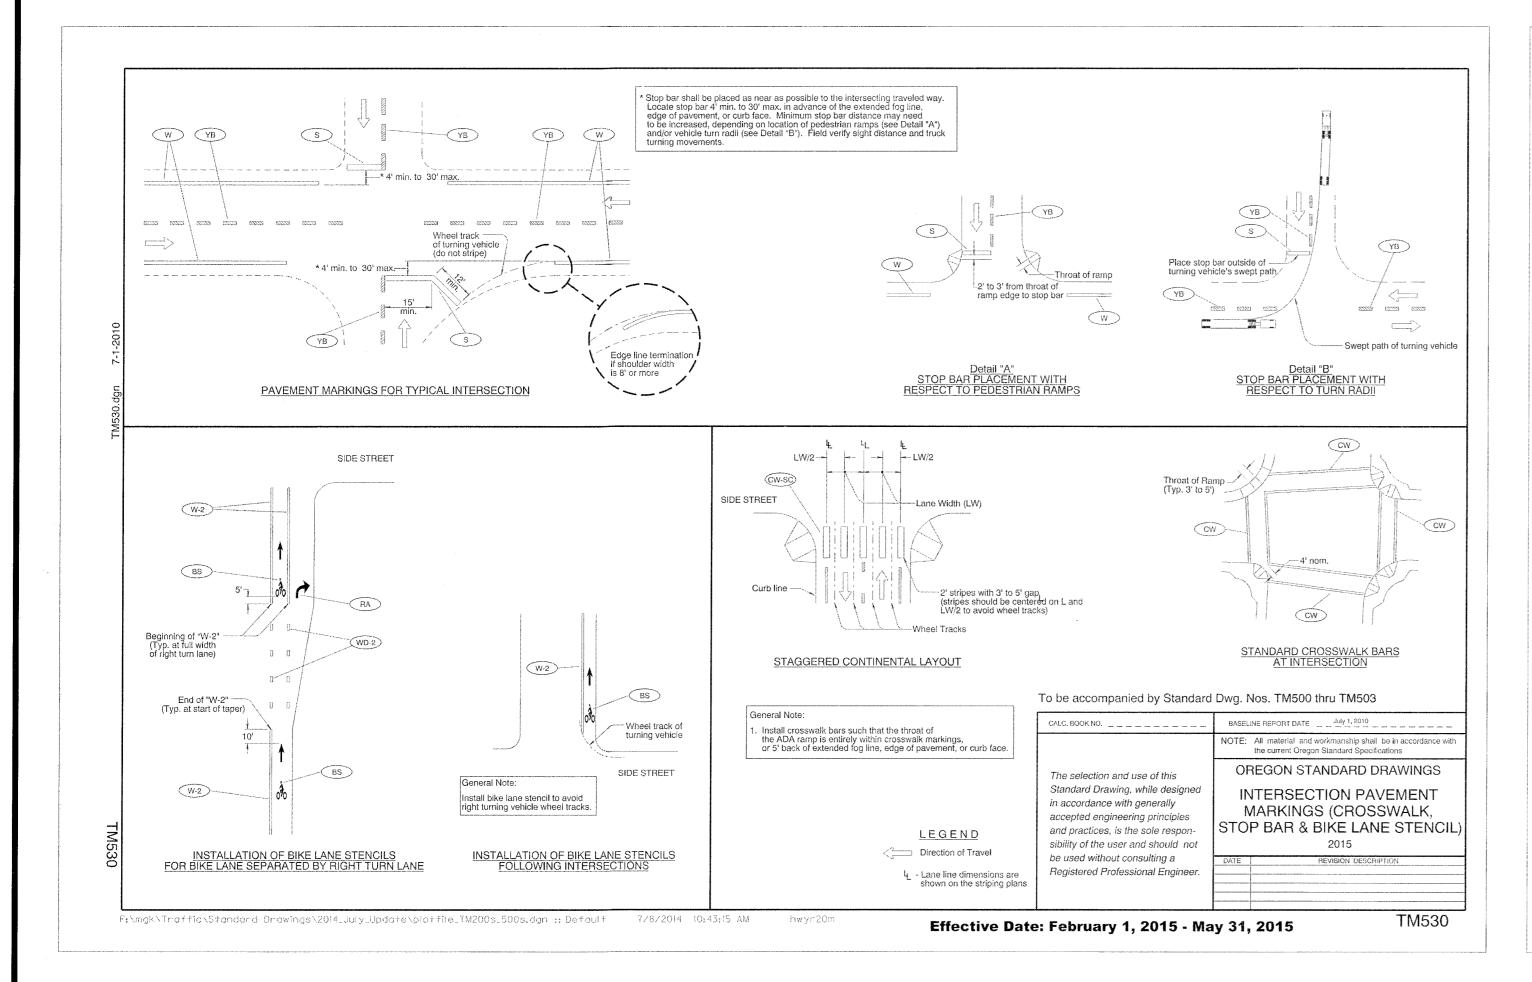
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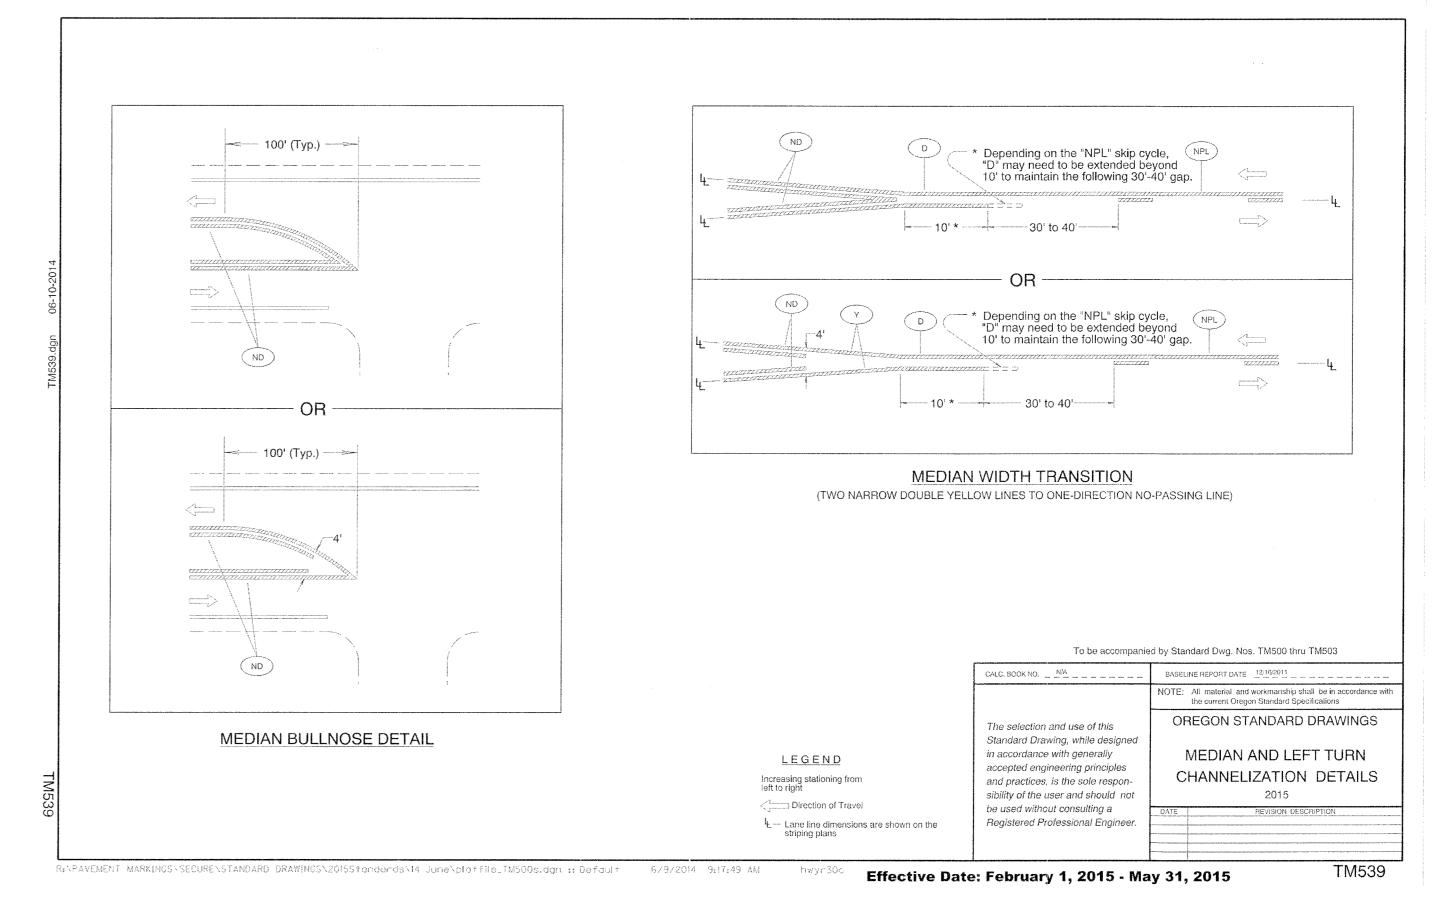
ODOT DETAILS


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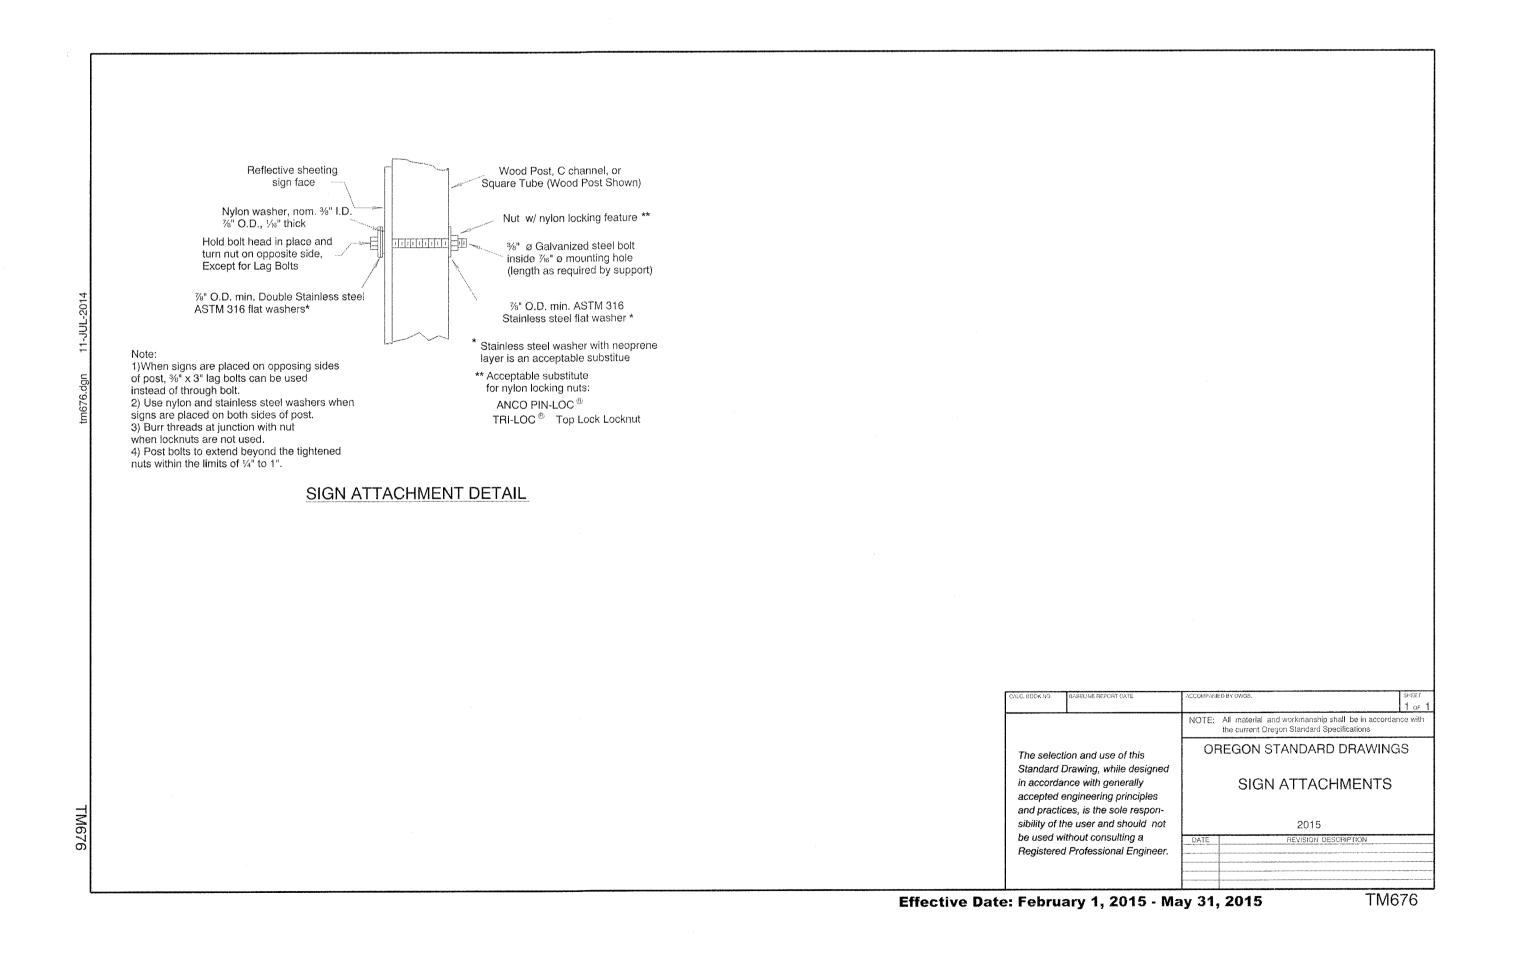
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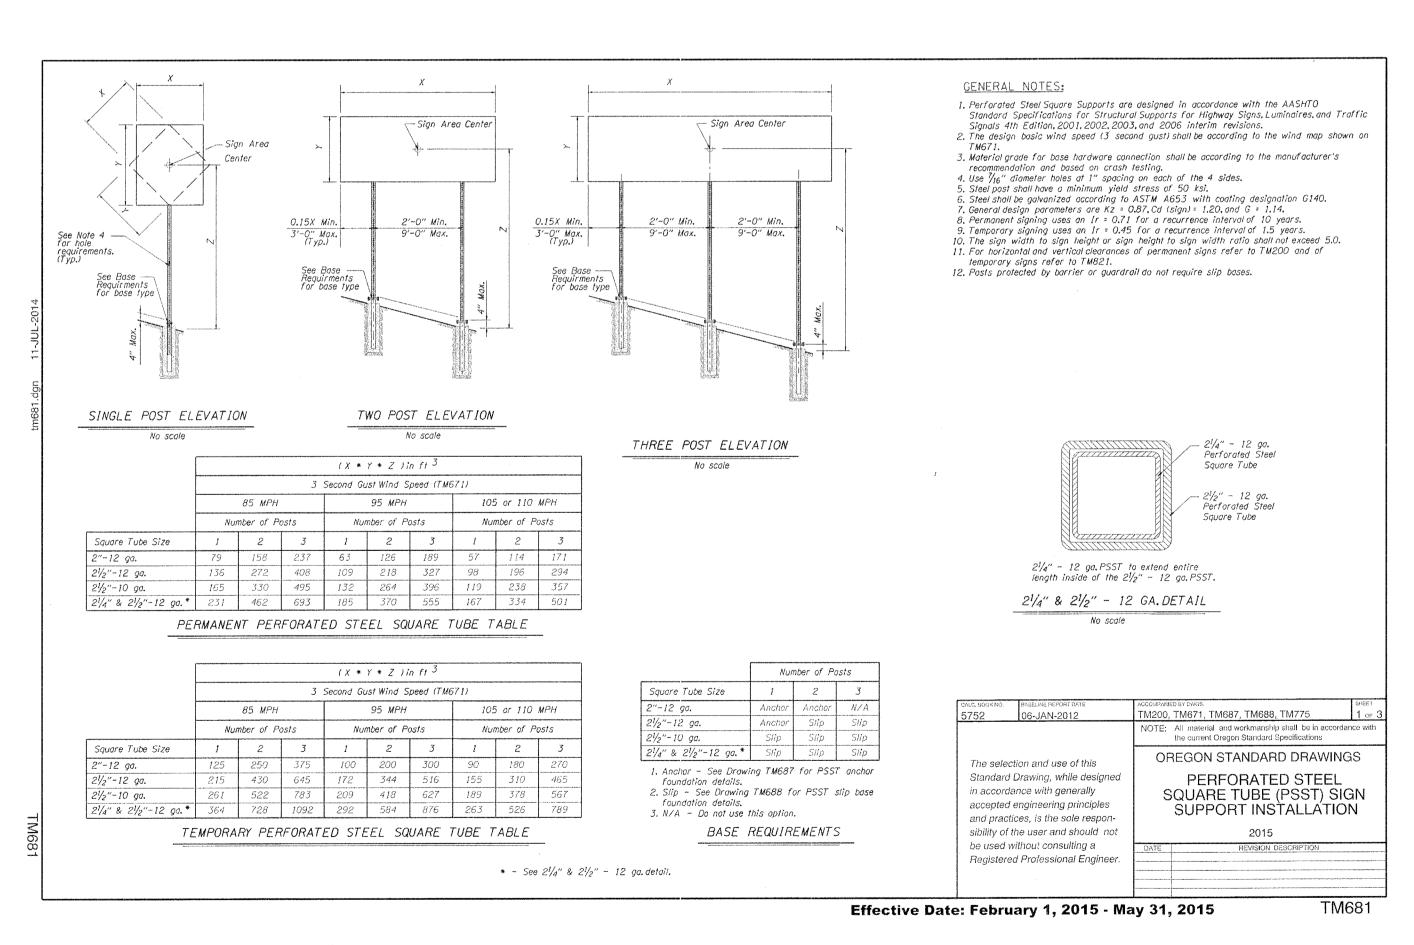
## SHADY HOLLOW AND WILLAMETTE DRIVE WEST LINN, OREGON

PROJECT 1335 NUMBER: DATE BY DRAWING DESIGN 20 NOV 2013 S 11 FEB 2014 DES REV 12 MAR 2014 | 9 PERMIT 22 AUG 2014 S PLAN CHECKS 21 OCT 2014 C 06 JAN 2015 23 JAN 2015 25 FEB 2015 16 MAR 2015 SHEET TITLE

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**ODOT DETAILS** 



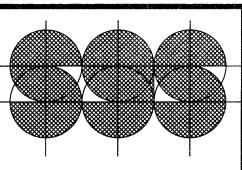

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SHADY HOLLOW AND WILLAMETTE

PROJECT NUMBER: 1335


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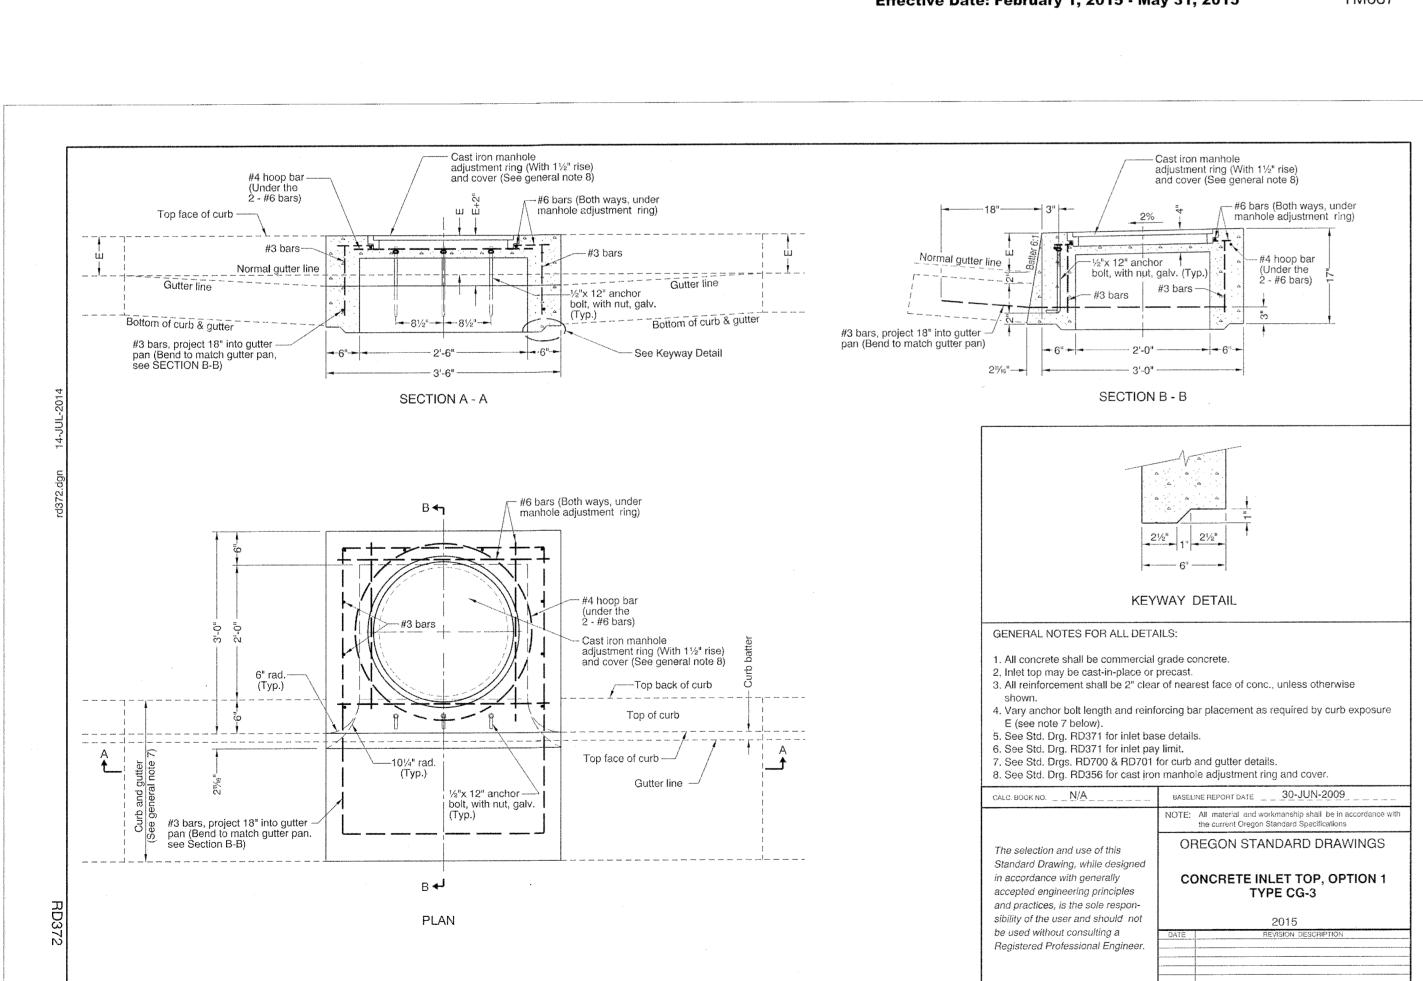
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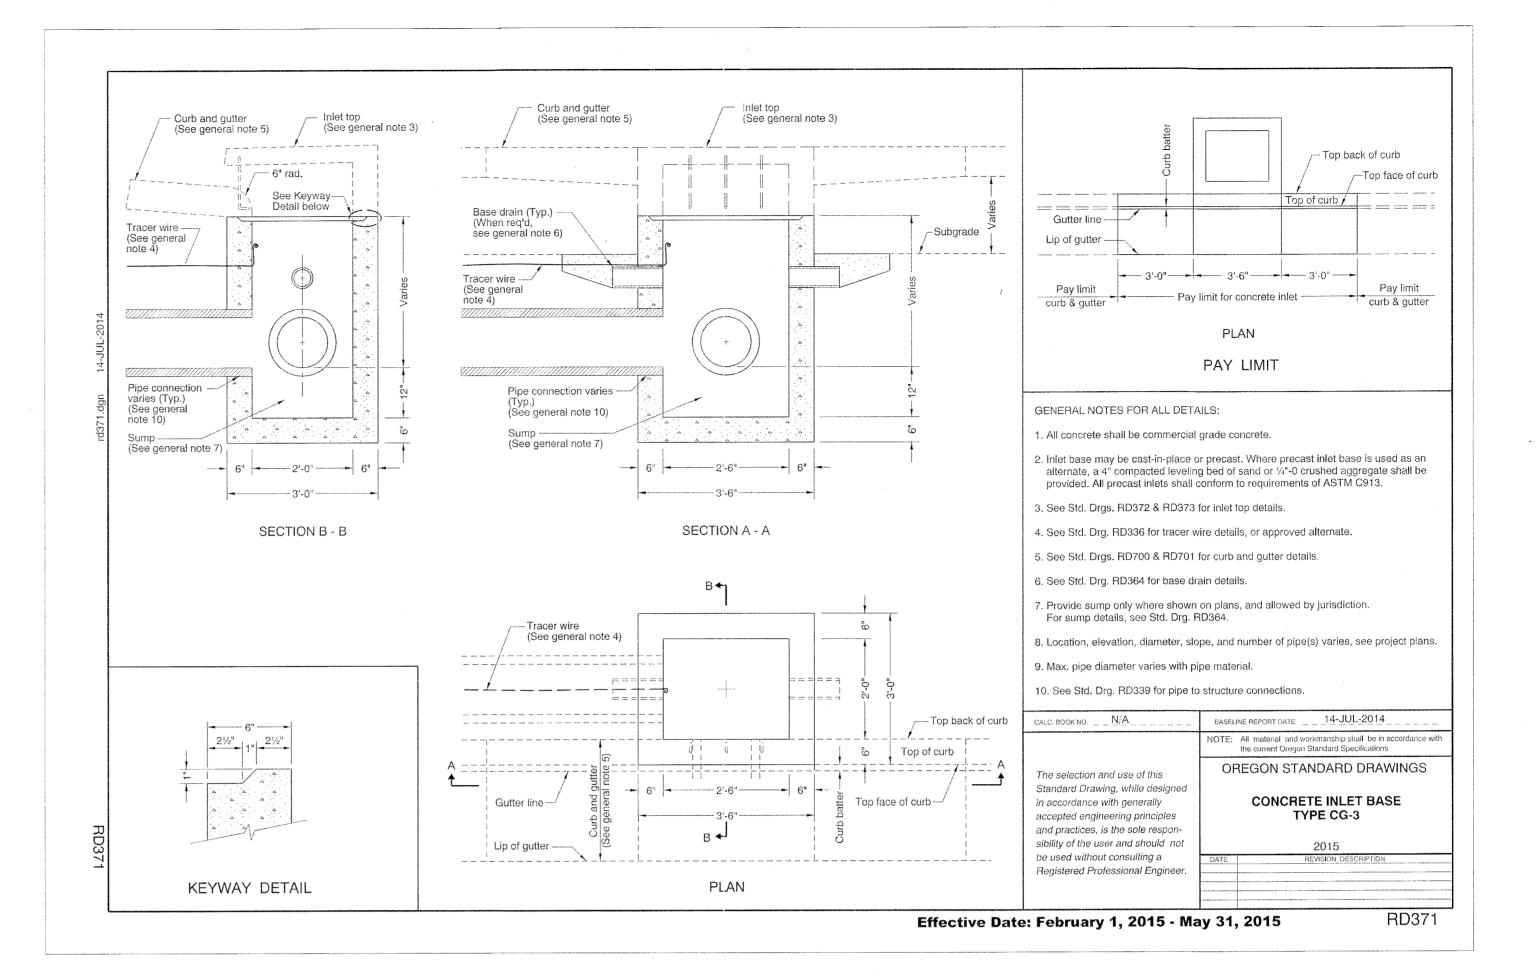
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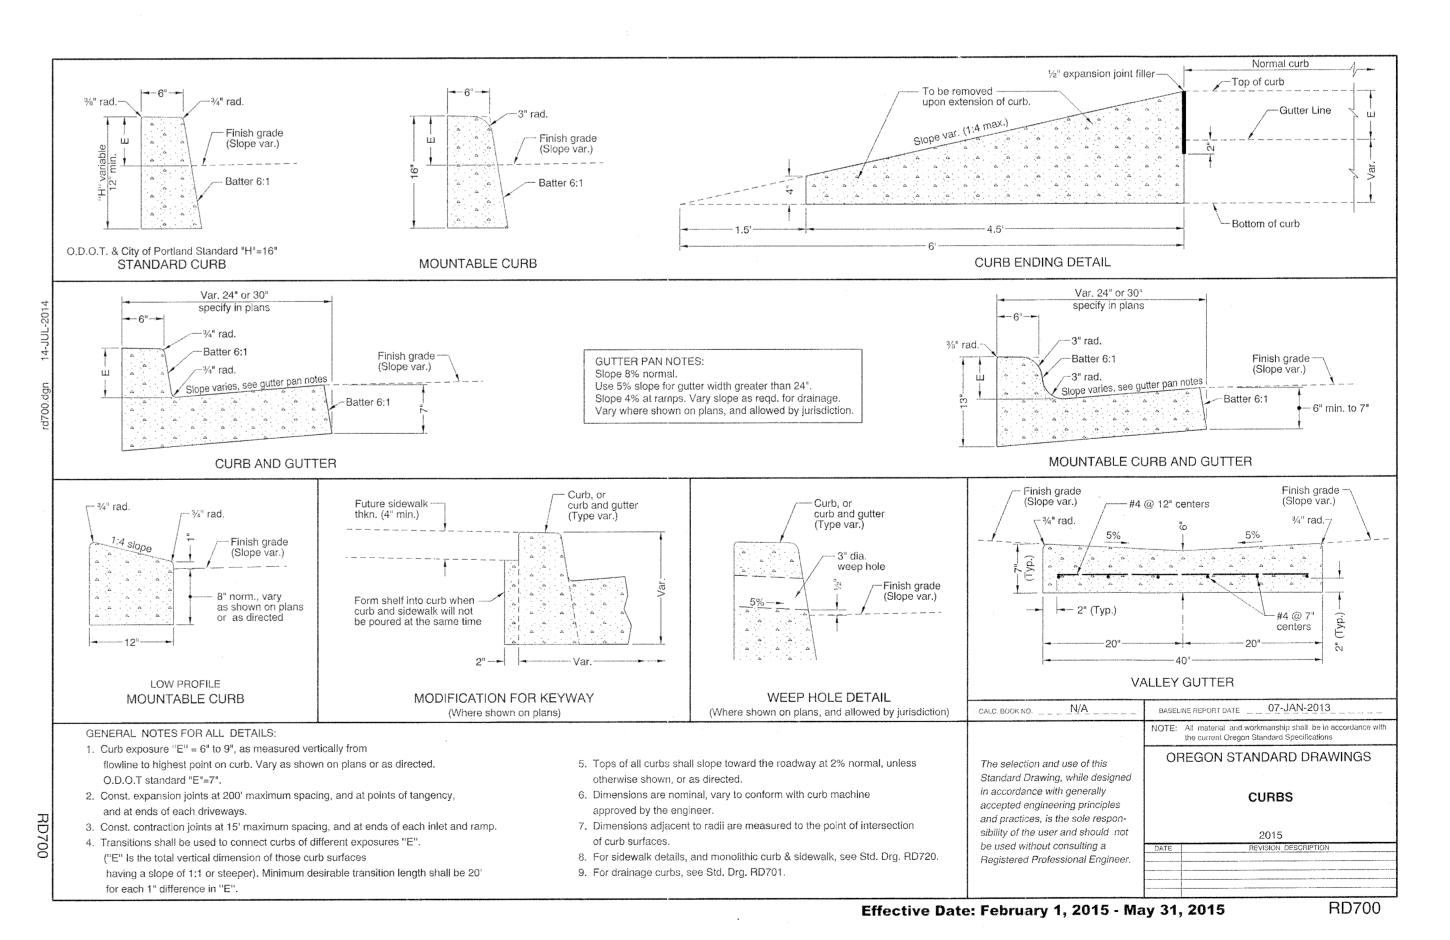





RD372

Effective Date: February 1, 2015 - May 31, 2015



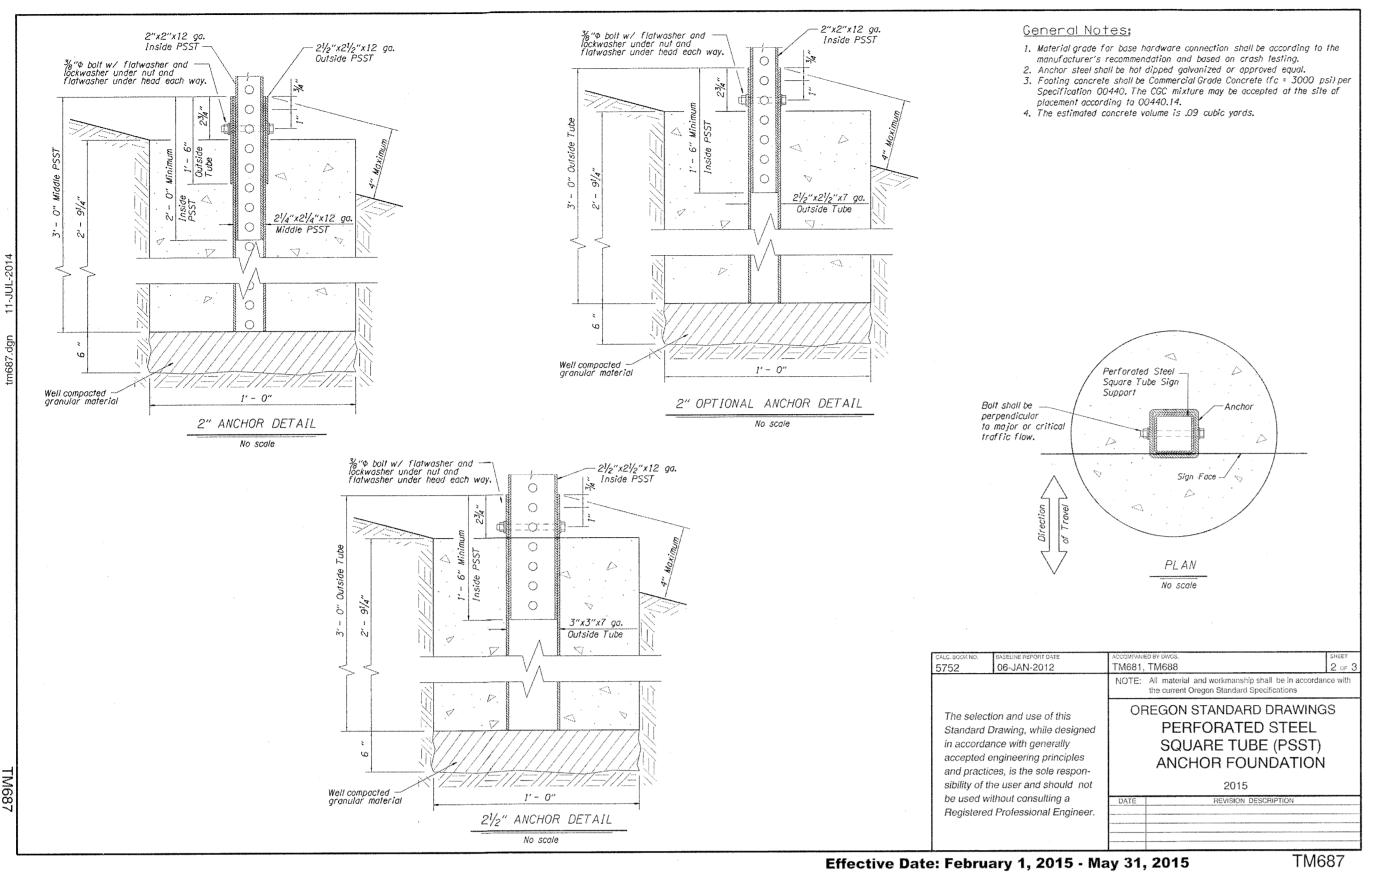

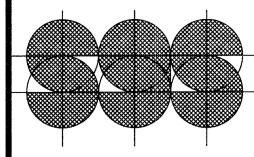

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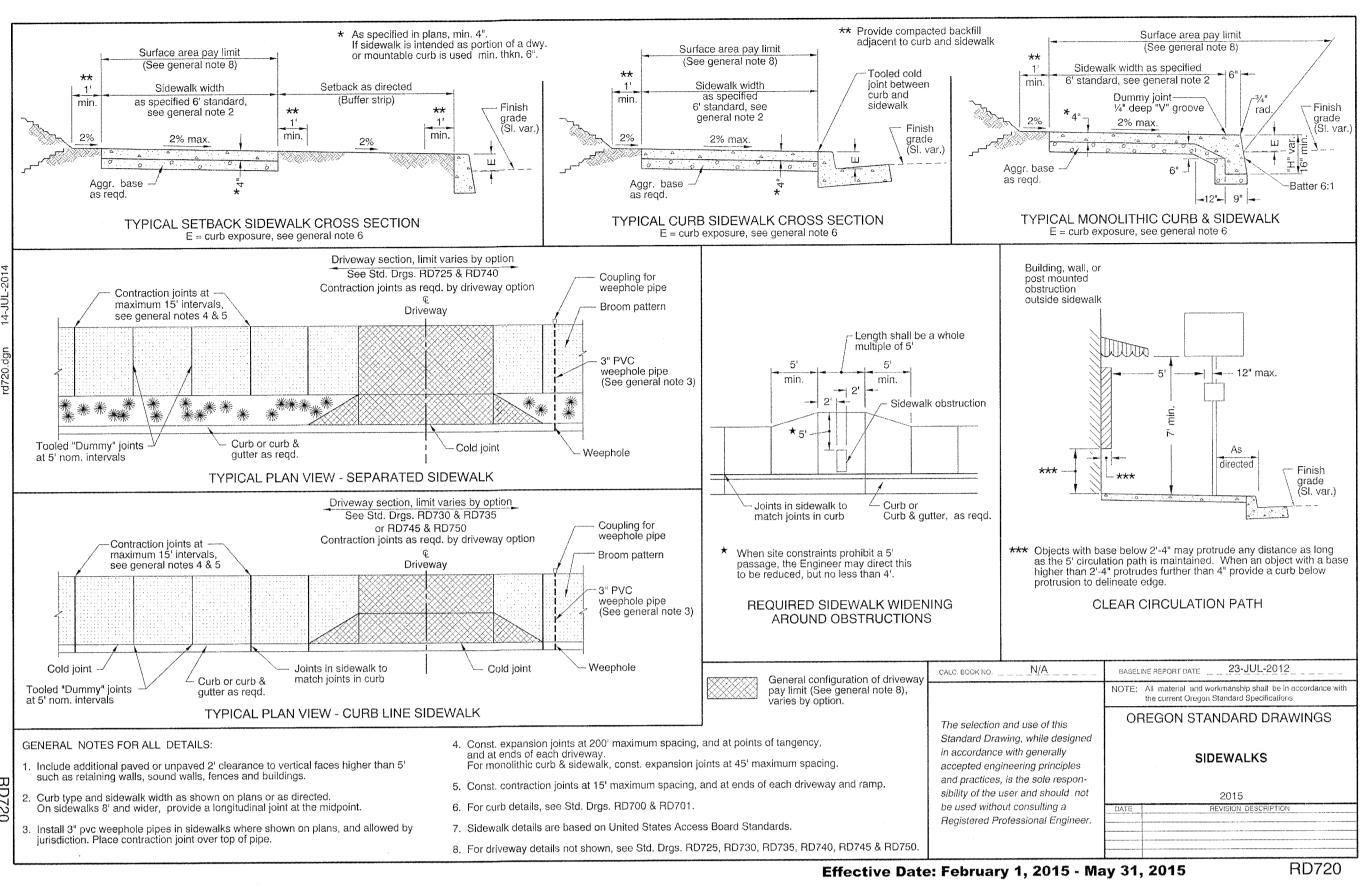
SHADY HOLLOW AND WILLAMETTE DRIVE WEST LINN, OREGON


**PROJECT** 1335 NUMBER: DATE | BY DRAWING DESIGN 20 NOV 2013 11 FEB 2014 **DES REV** 12 MAR 2014 **PERMIT** 22 AUG 2014 PLAN CHECKS 21 OCT 2014 06 JAN 2015 23 JAN 2015 25 FEB 2015 16 MAR 2015

SHEET TITLE

ODOT DETAILS


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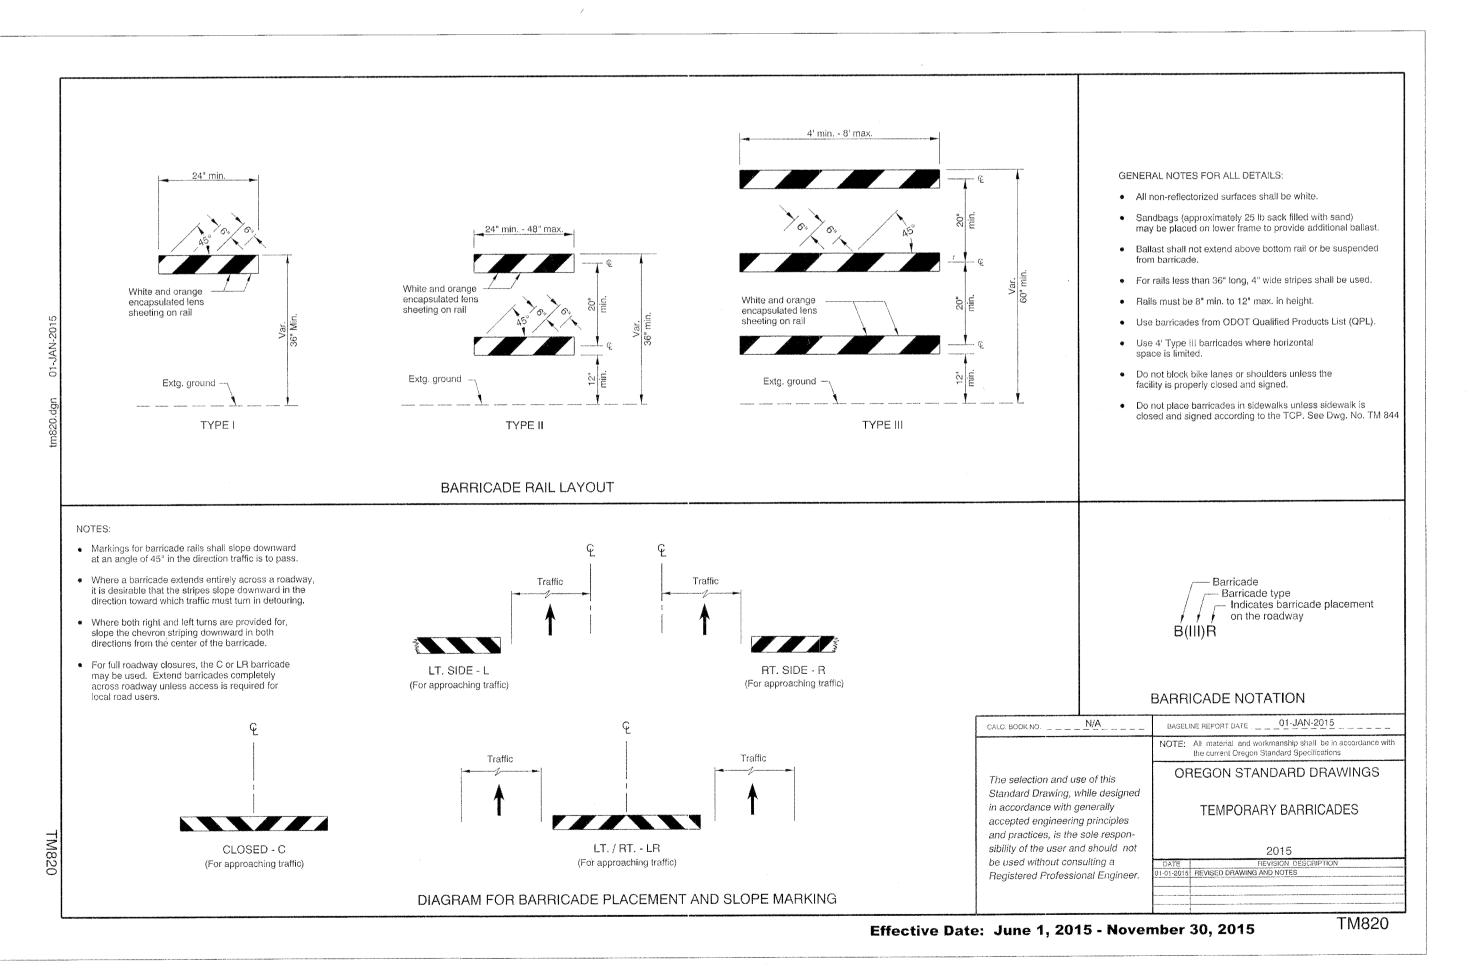


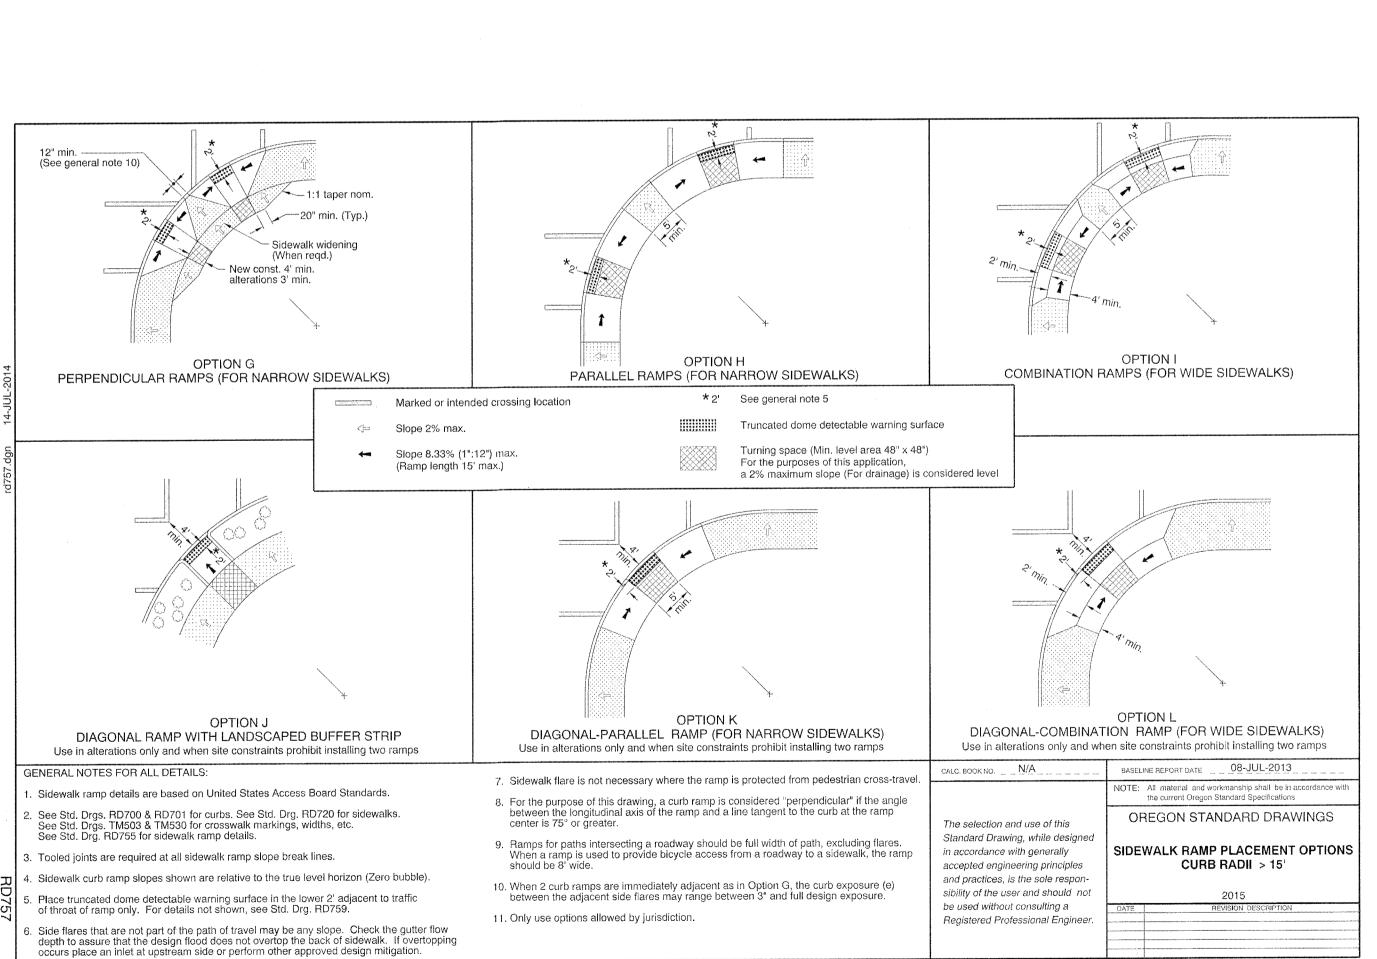


RD757

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ARCHITECT
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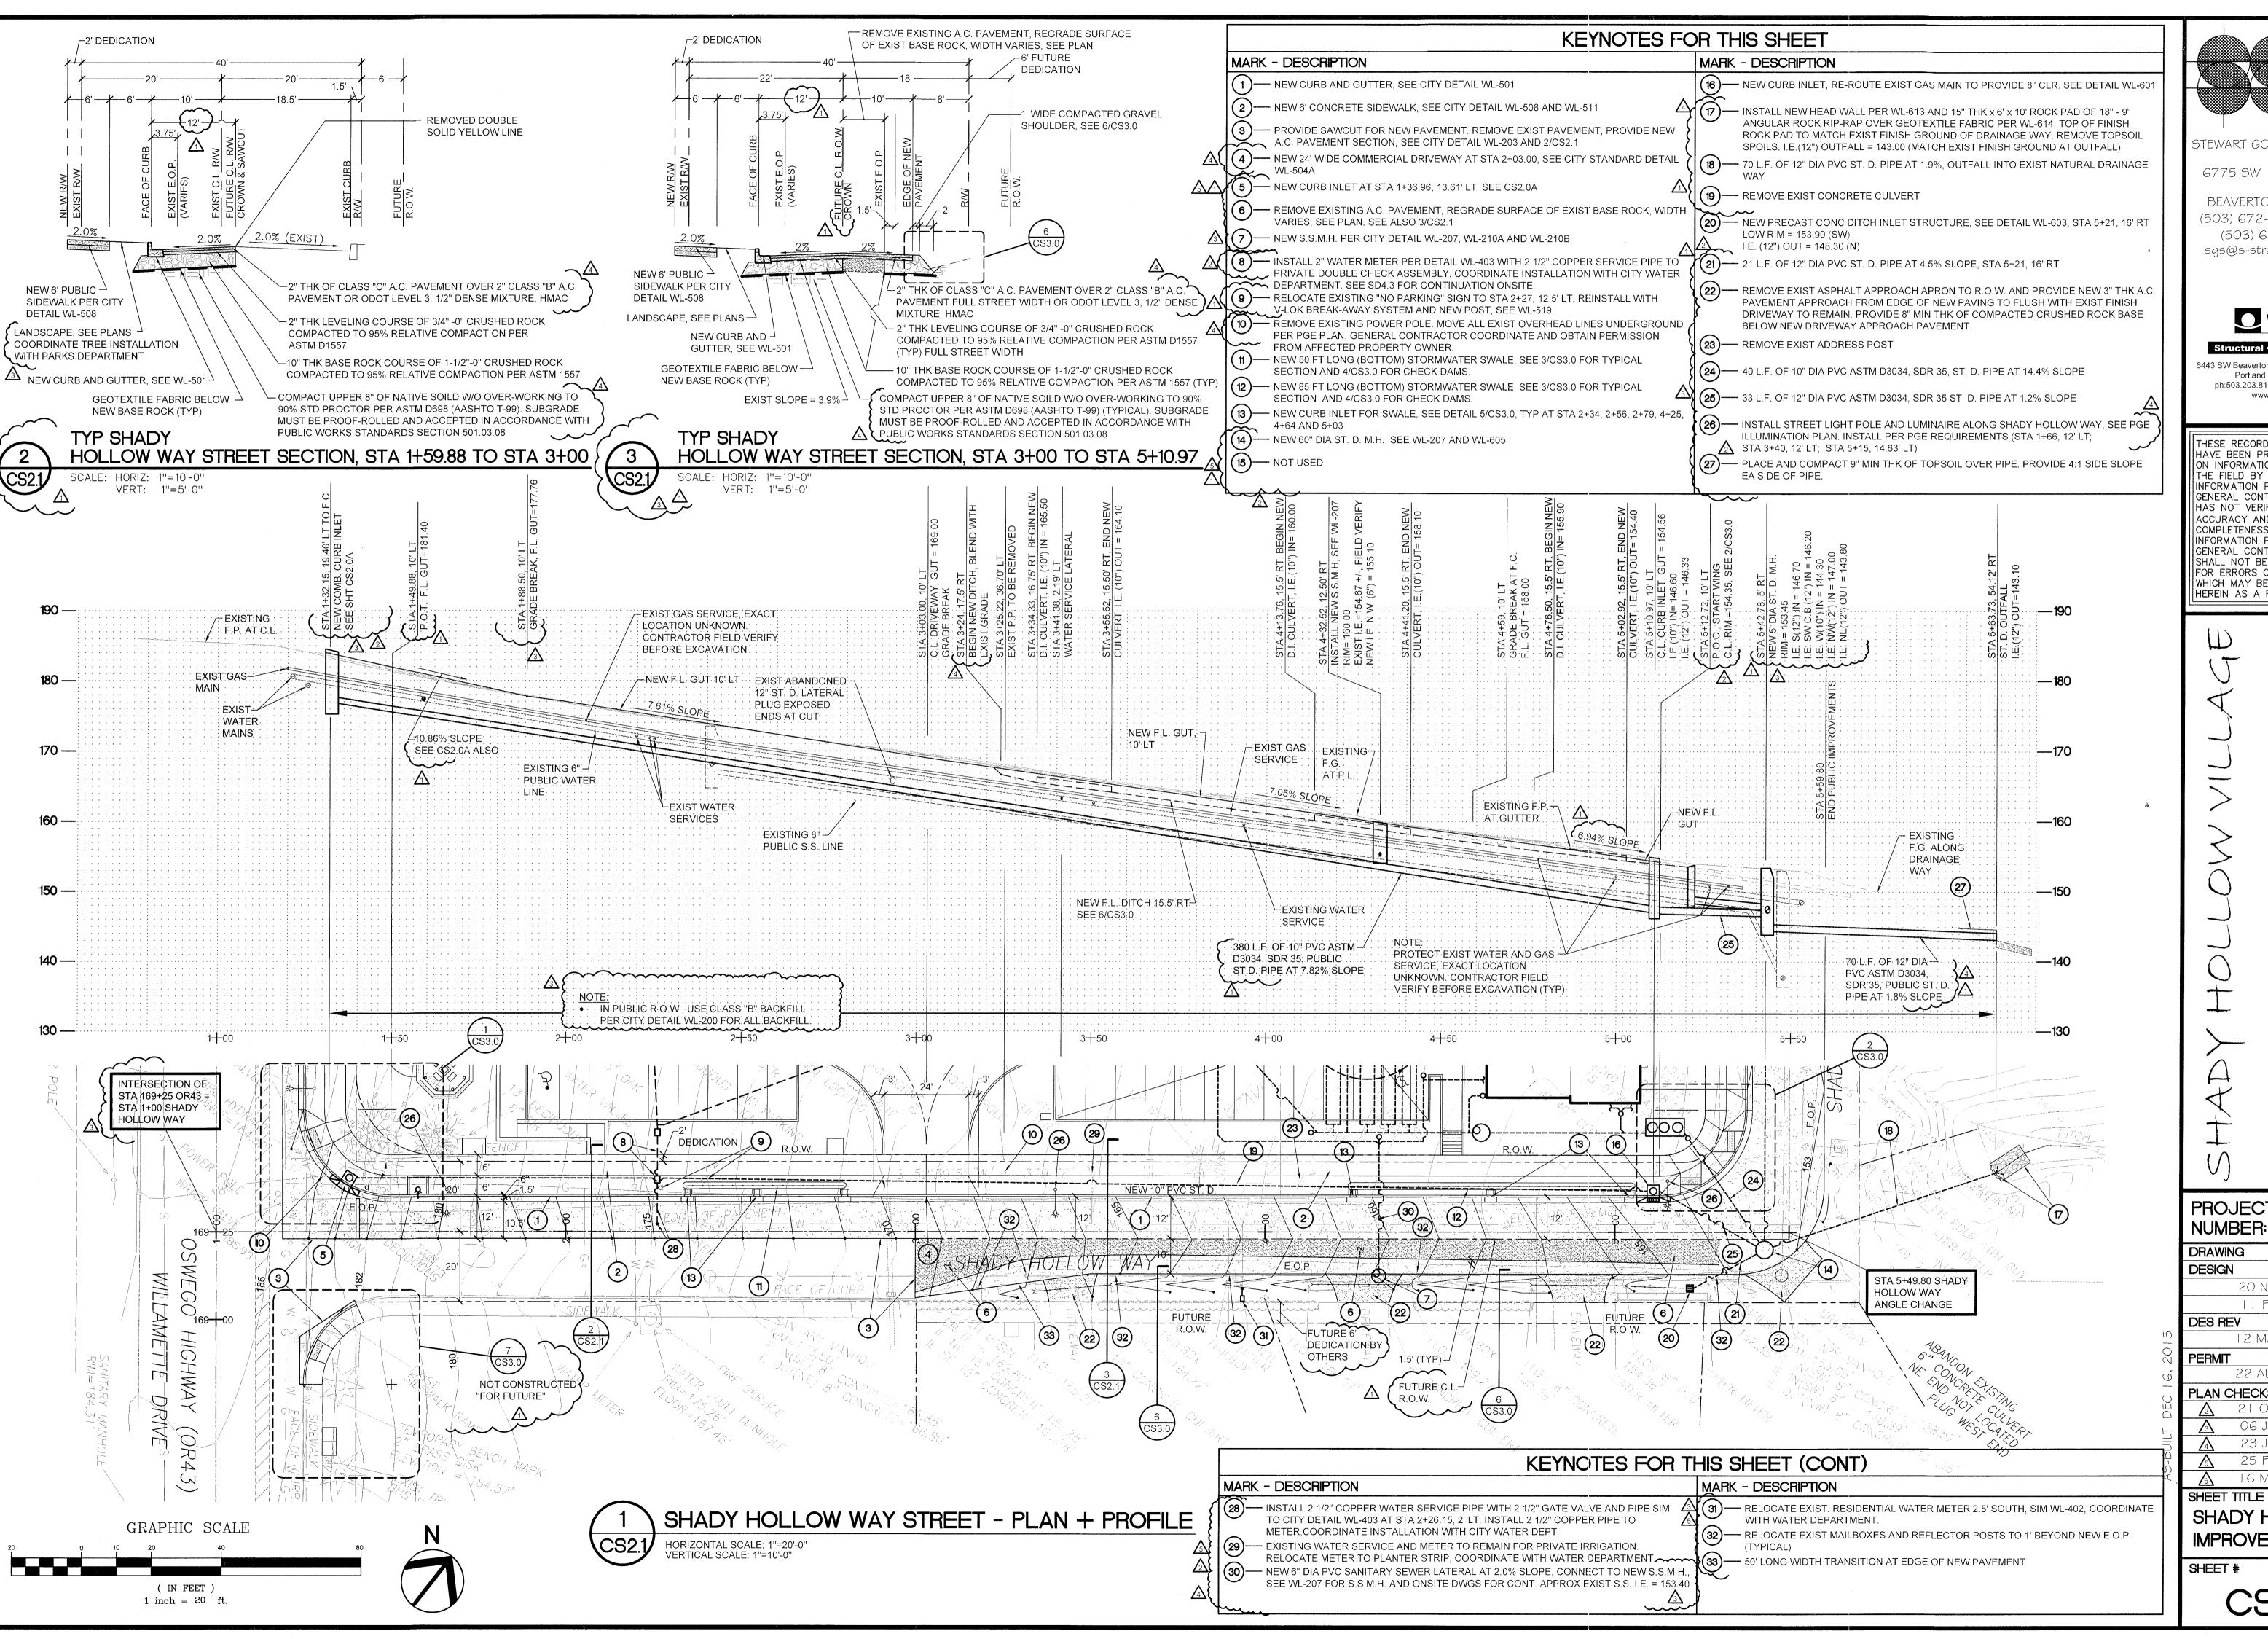
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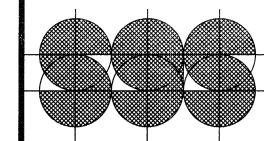
# SHADY HOLLOW AND WILLAMETTE DRIVE

PROJEC1 1335 NUMBER DATE BY DRAWING DESIGN 20 NOV 2013 11 FEB 2014 DES REV 12 MAR 2014 22 AUG 2014 PLAN CHECKS 21 OCT 2014 06 JAN 2015 23 JAN 2015 25 FEB 2015 16 MAR 2015 SHEET TITLE

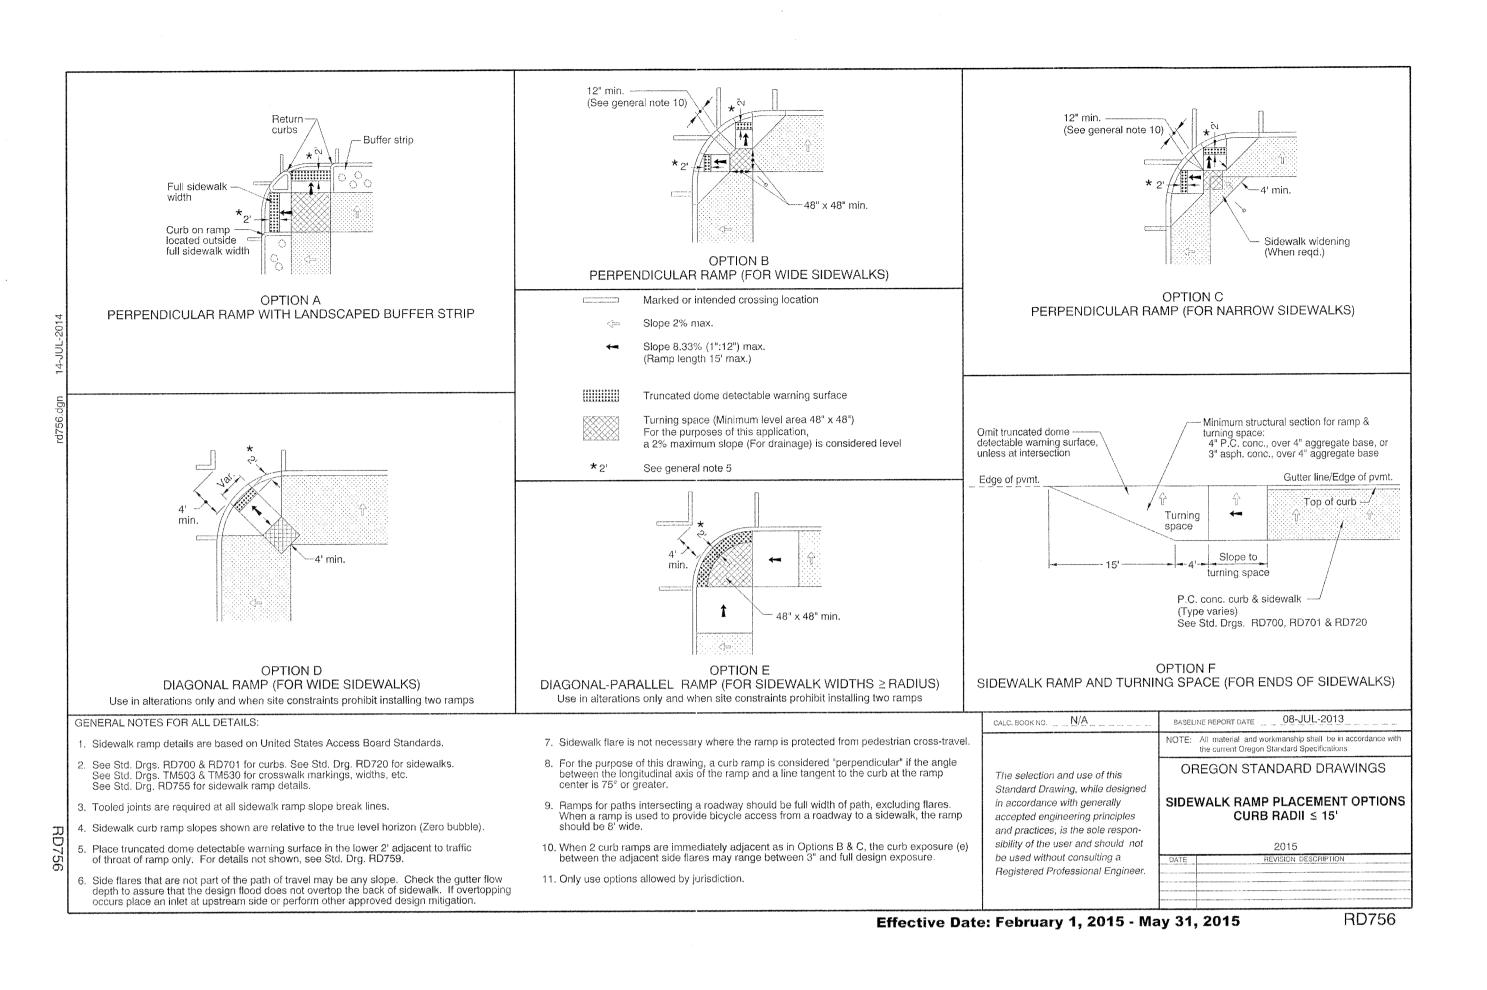ODOT DETAILS

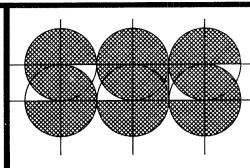SHEET # CS2.0G





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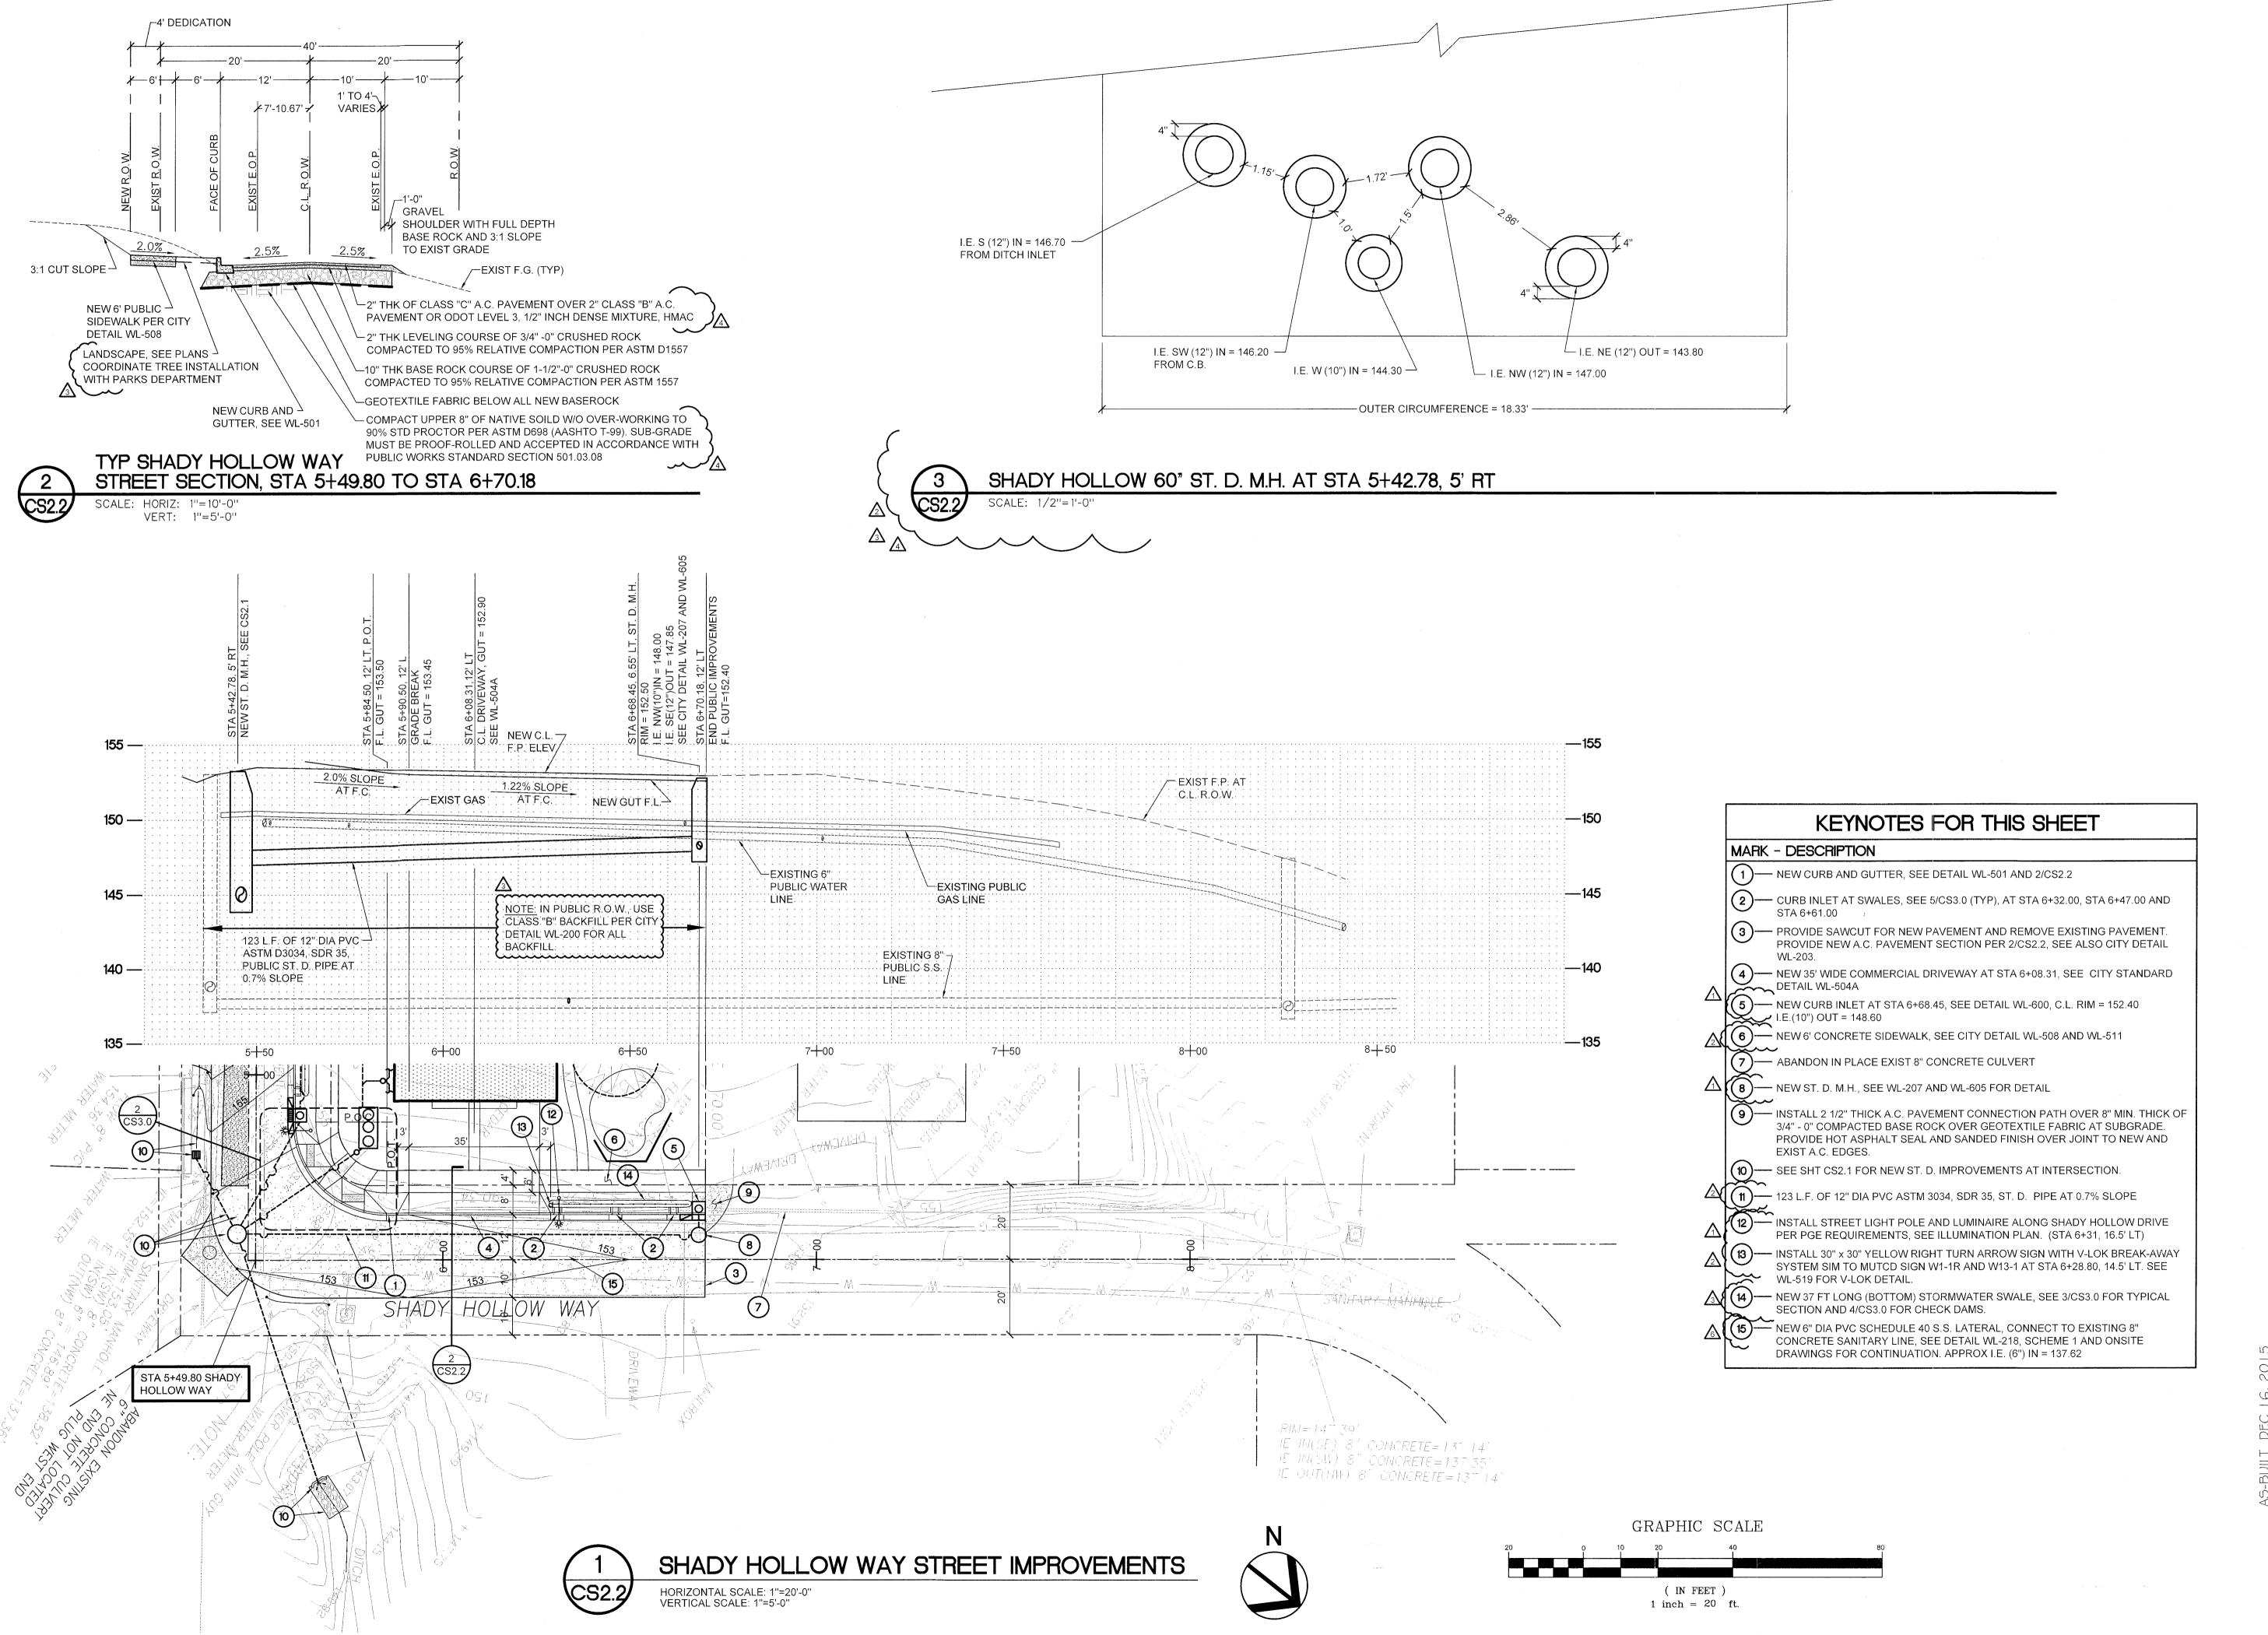
PLAN CHECKS 21 OCT 2014 06 JAN 2015 23 JAN 2015

25 FEB 2015 16 MAR 2015

SHADY HOLLOW **IMPROVEMENTS** 

SHEET #

**CS2.1** 



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SHADY HOLLOW AND WILLAMETTE DRIVE

PROJECT NUMBER: 1335

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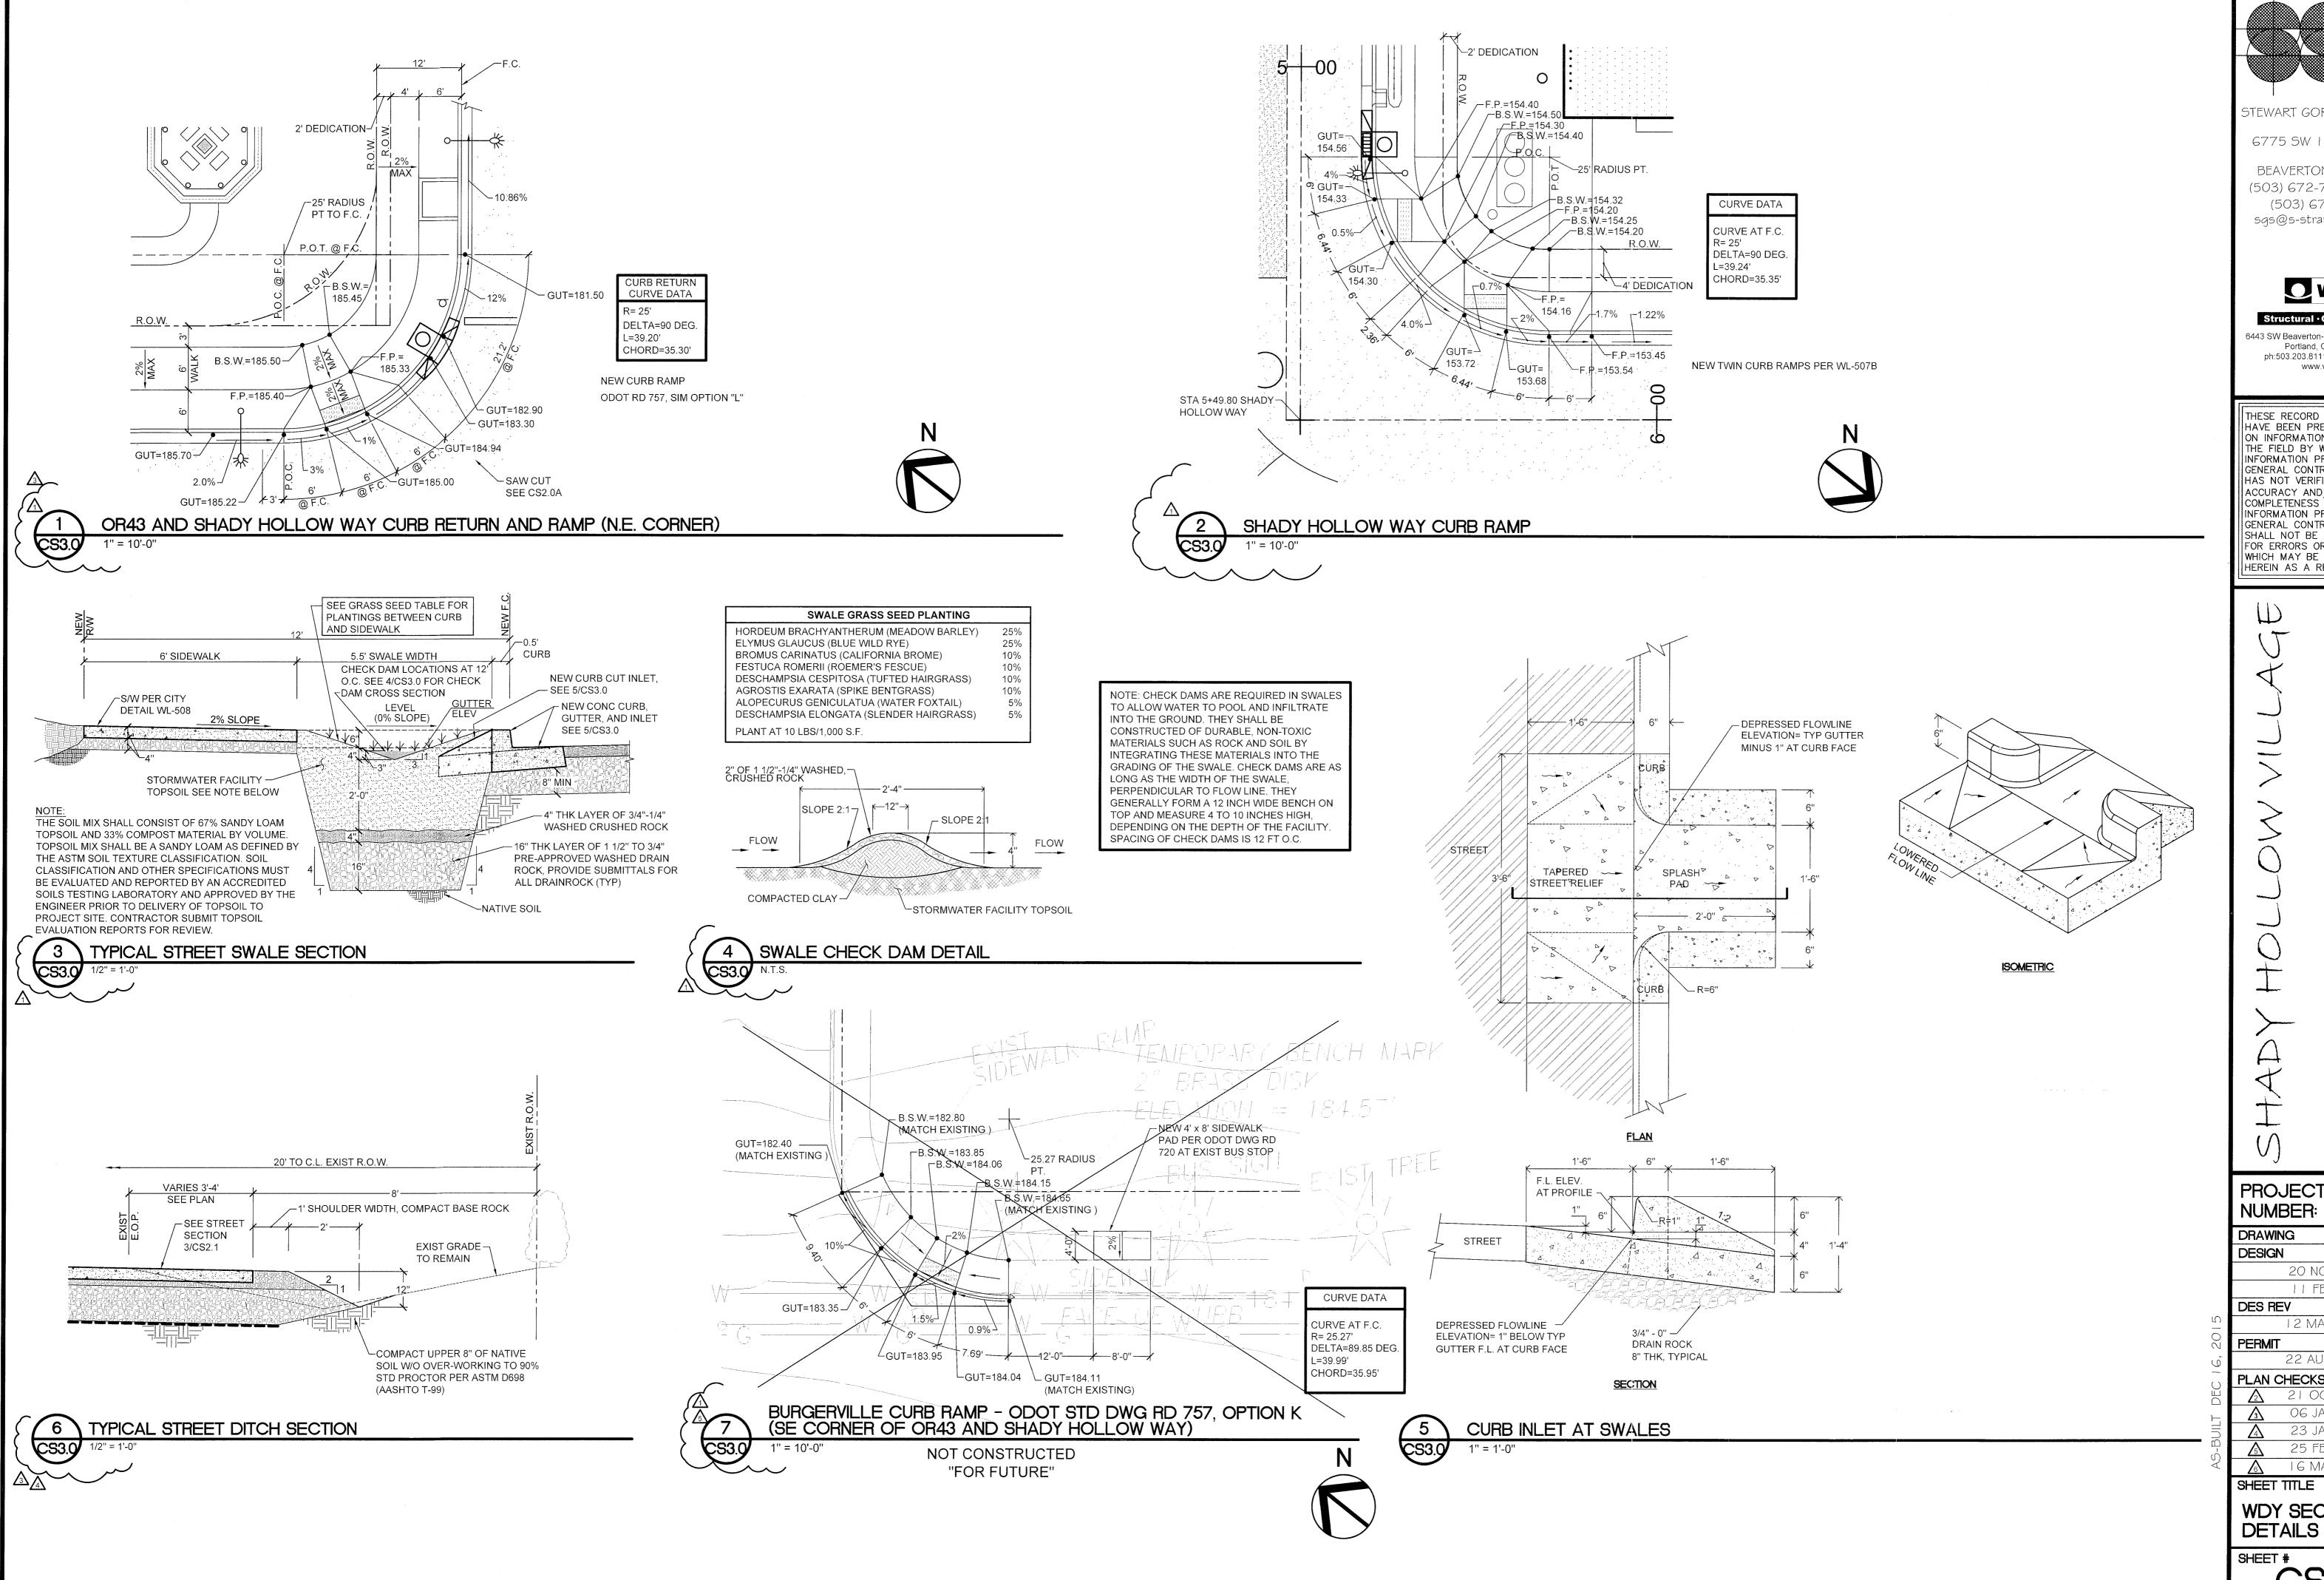
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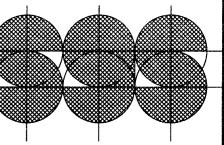
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SHEET TITLE
SHADY HOLLOW
IMPROVEMENTS

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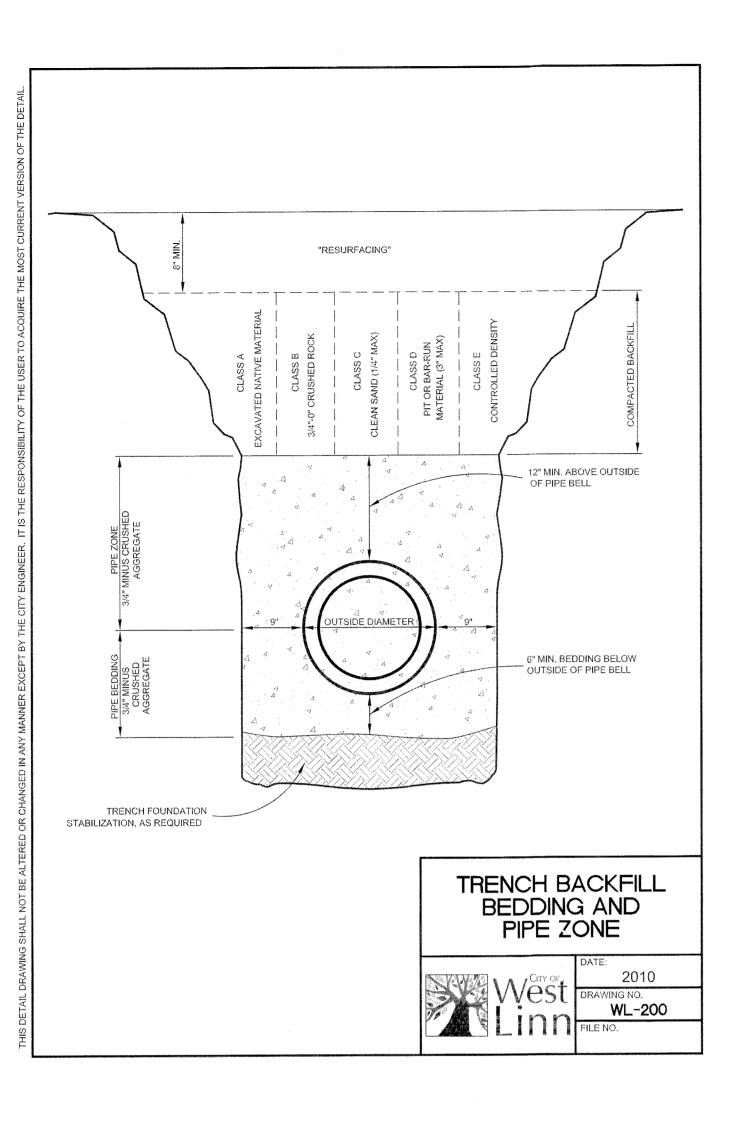
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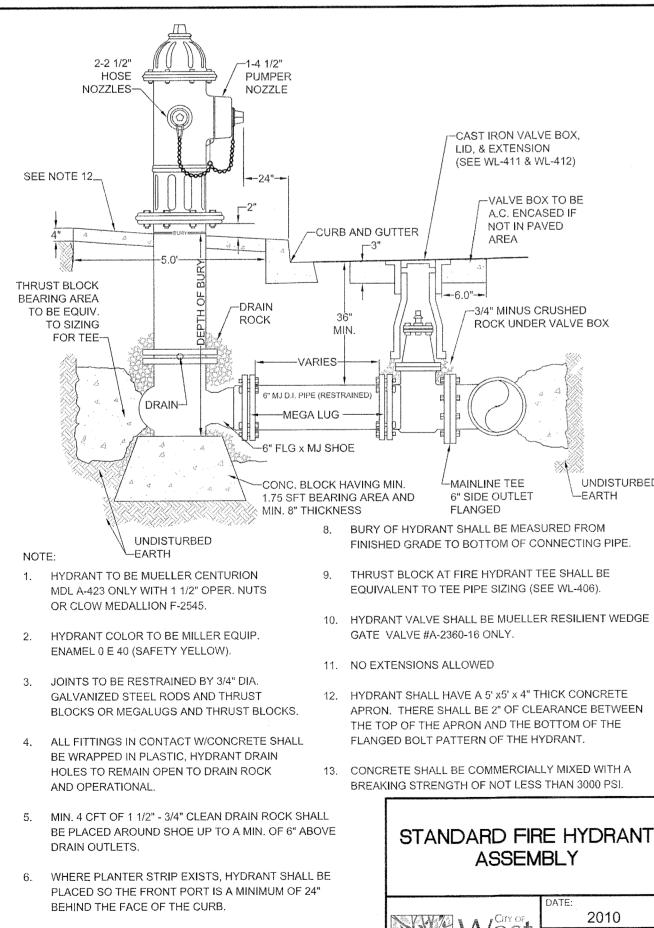
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WDY SECTION **DETAILS** 

SHEET # CS3.0








WHERE INTEGRAL S/W & CURB EXISTS, HYDRANT


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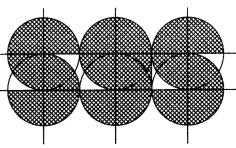
SHALL BE PLACED AT BACK OF THE SIDEWALK, OR



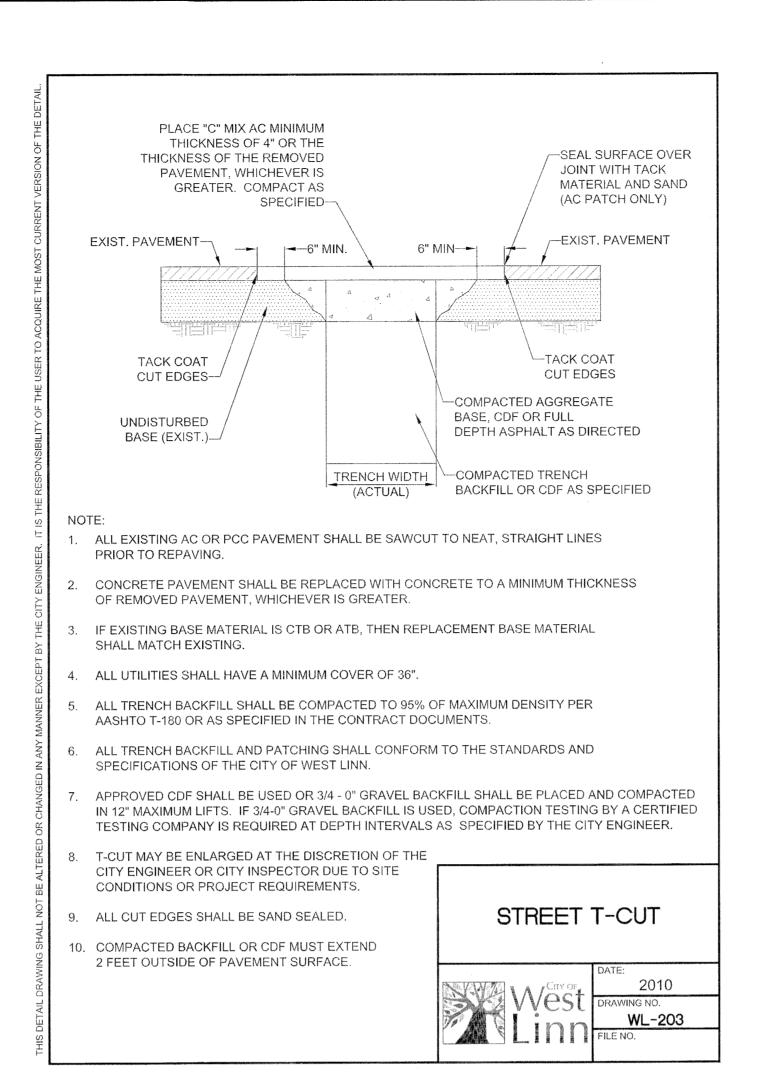

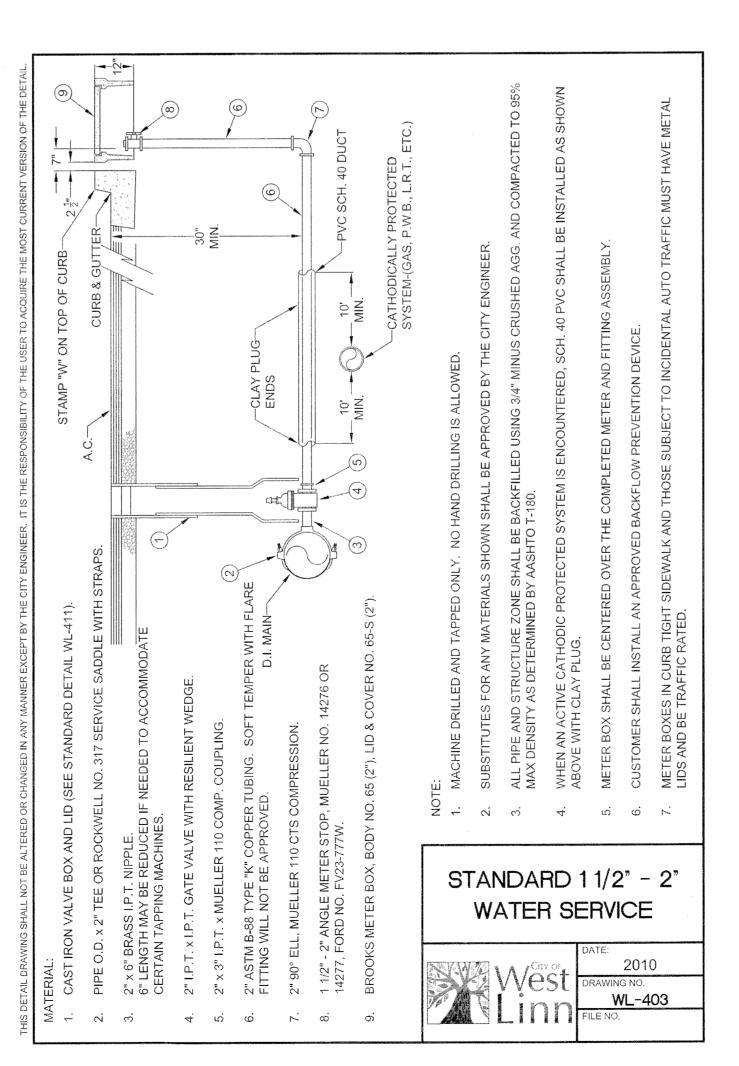

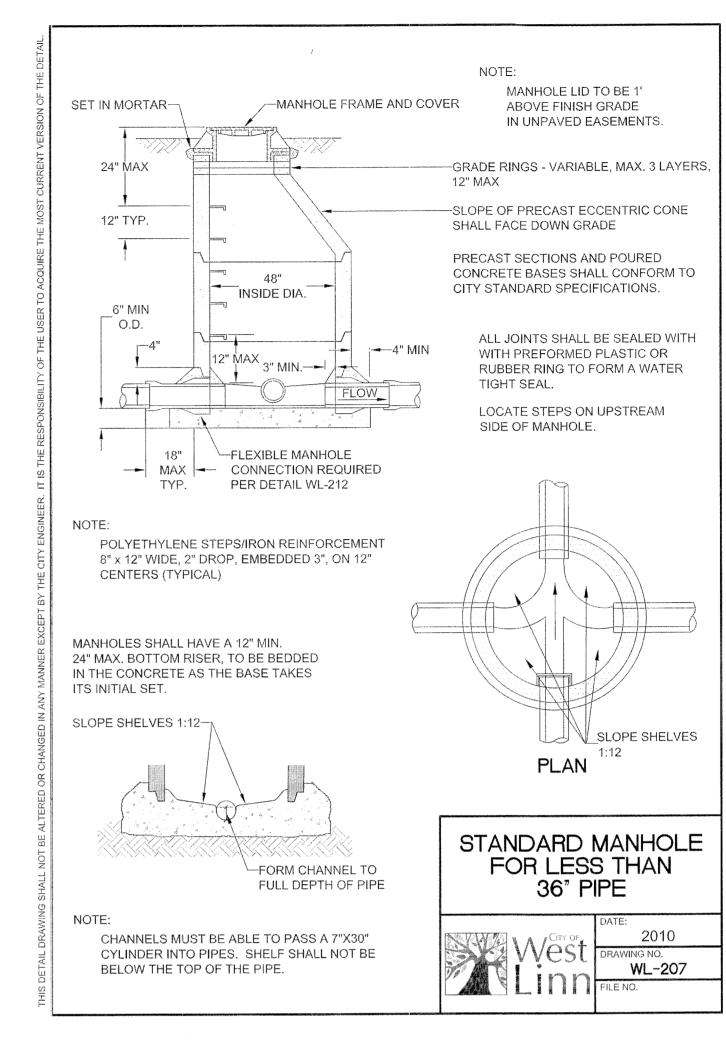

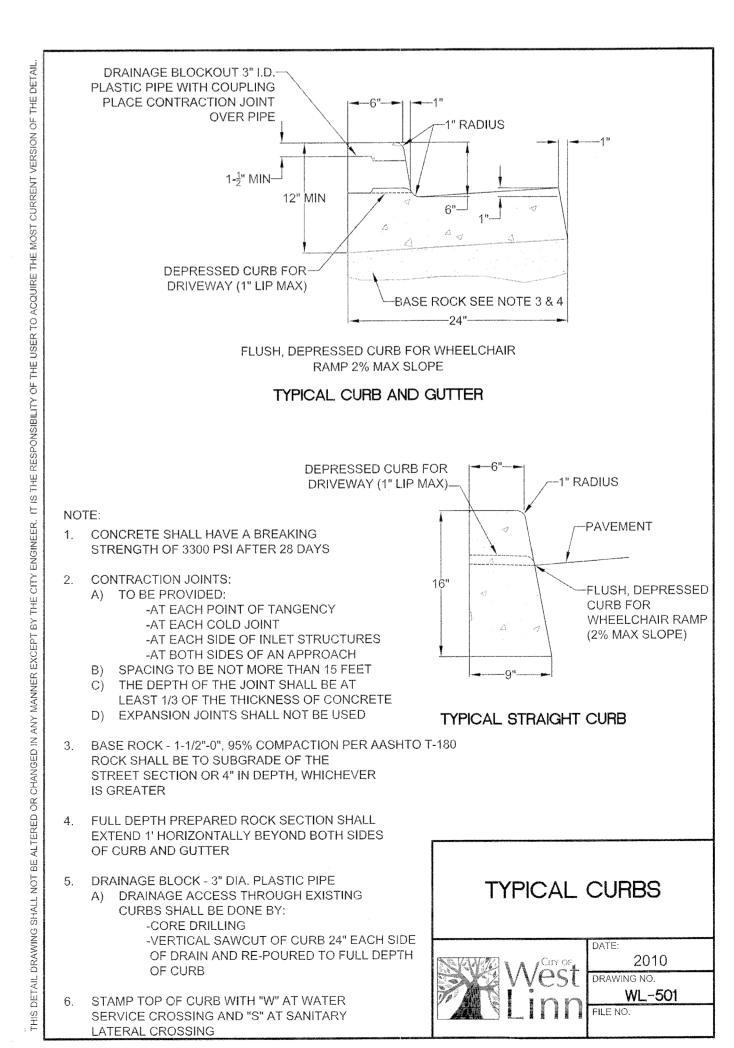

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sqs@s-straus.com (e-mail)

WDY

Structural • Civil Engineers

6443 SW Beaverton-Hillsdale Hwy, suite 21
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WHICH MAY BE INCORPORATED
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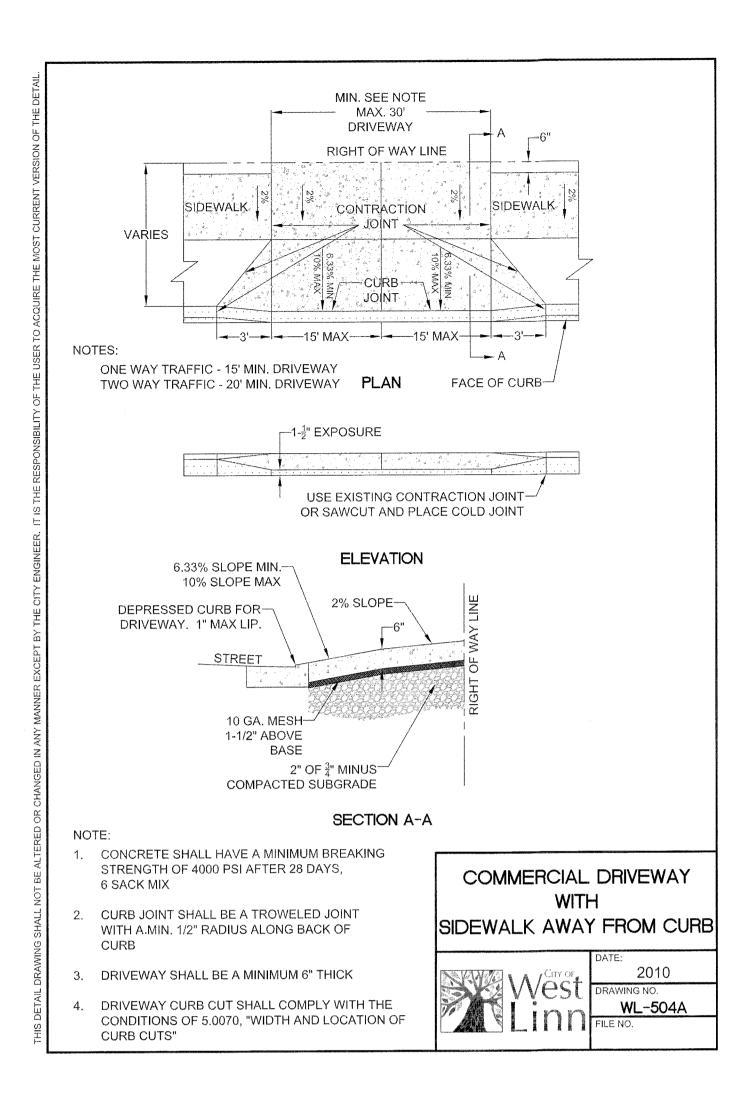
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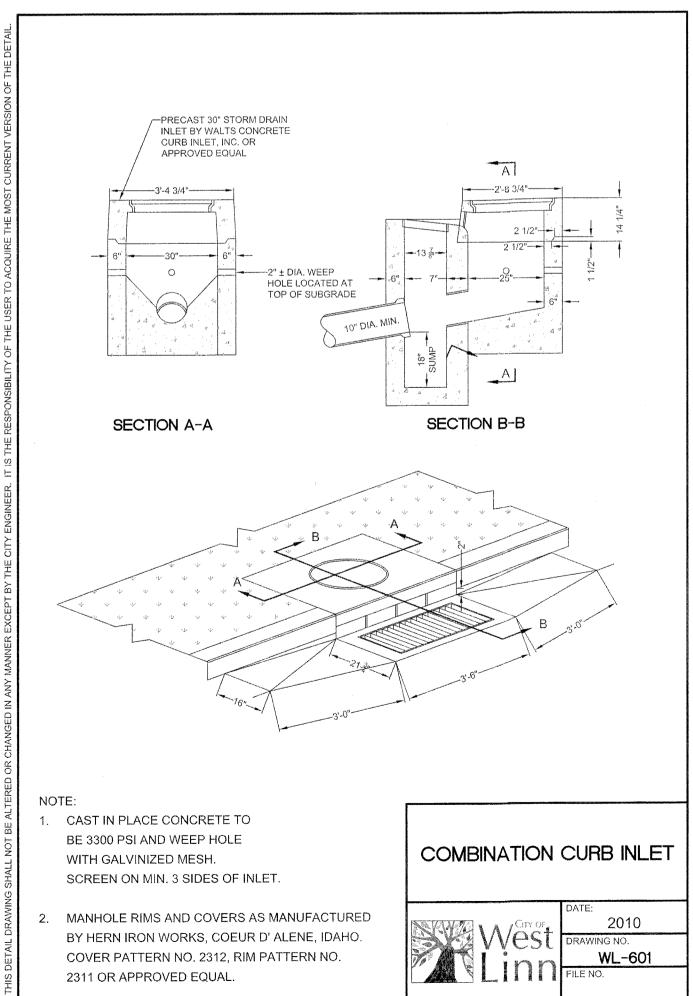
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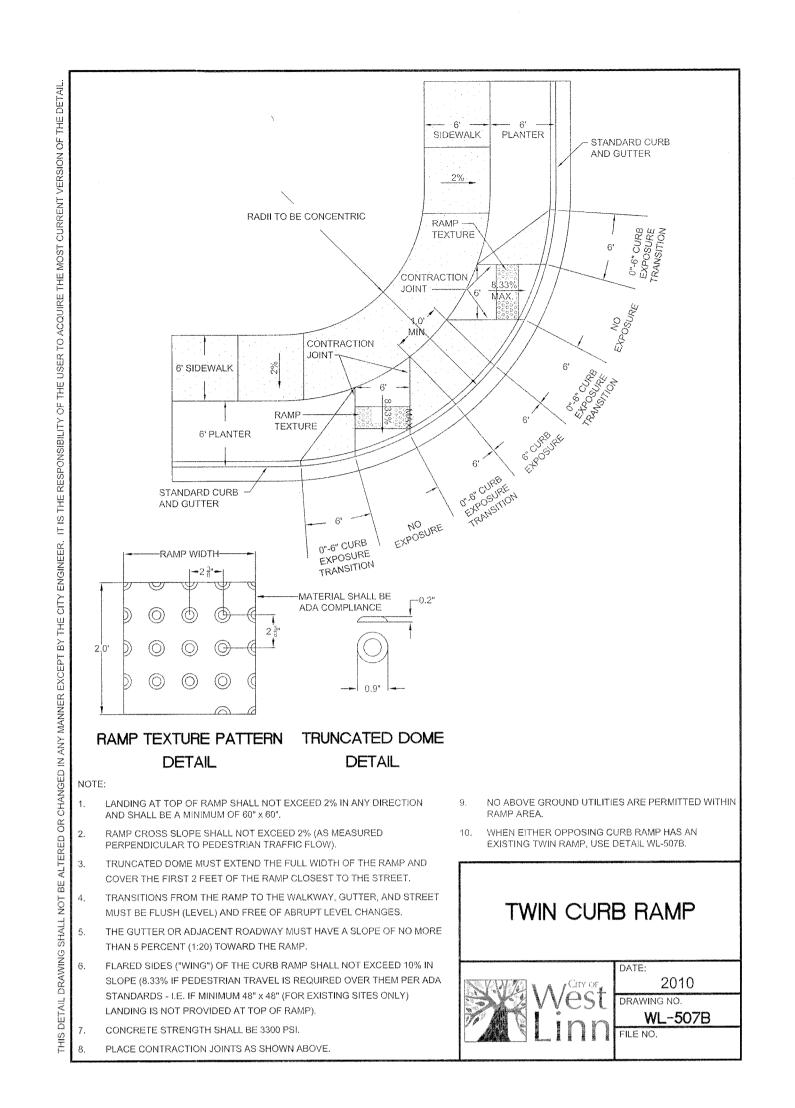
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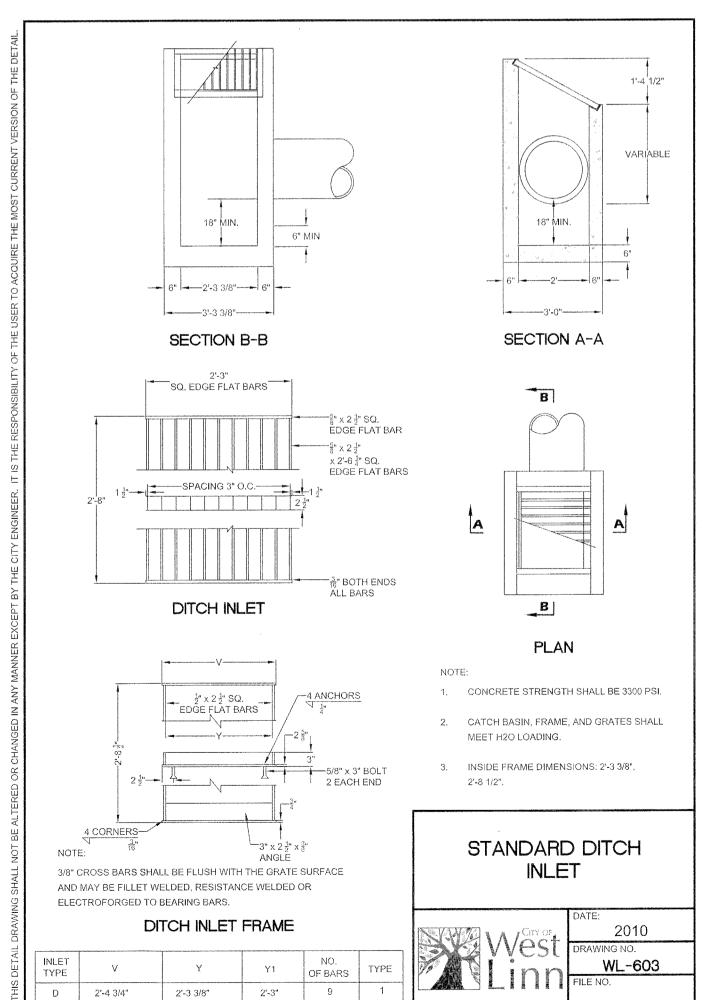
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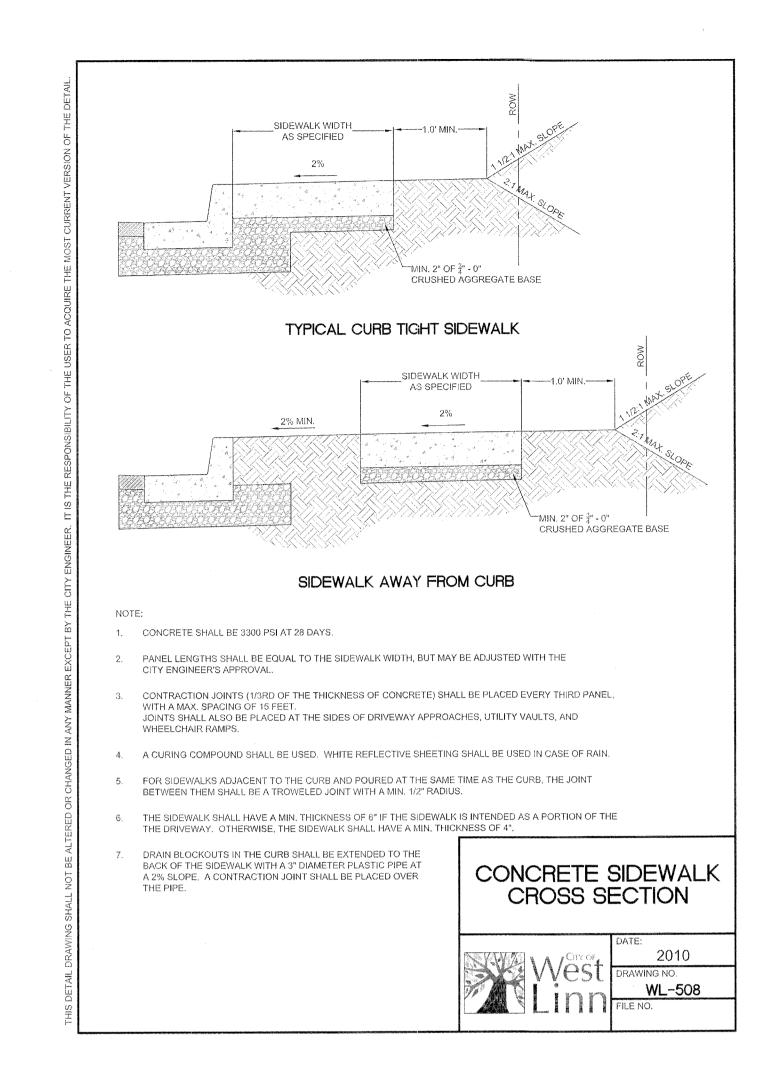
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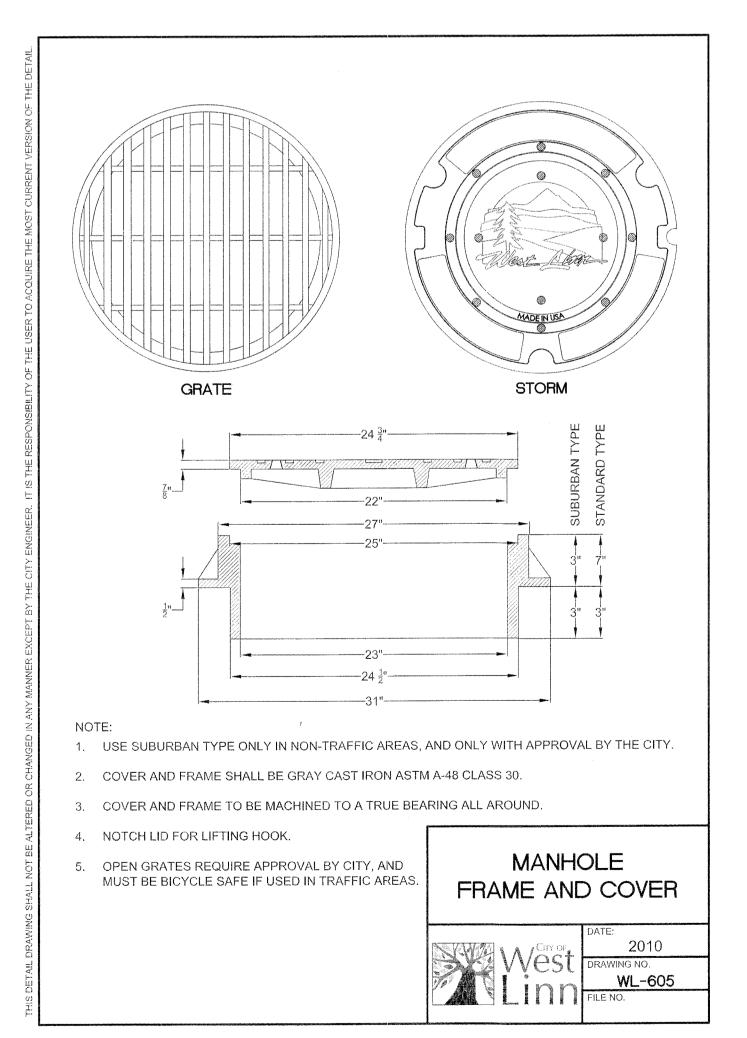













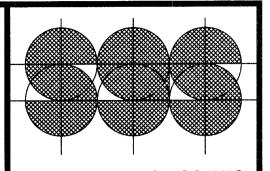

STEWART GORDON STRAUS
ARCHITECT
6775 SW 111TH AVENUE
SUITE 20
BEAVERTON, OR 97008

(503) 672-7517 (OFFICE) (503) 672-7808 (FAX)

sgs@s-straus.com (e-mail)

WDY

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OLLOW AND WILLAMETTE DRIVE

PROJECT NUMBER: 1335

DRAWING DATE BY
DESIGN

DRAWING DATE BY

DESIGN

20 NOV 2013 SGS

11 FEB 2014 SGS

DES REV

12 MAR 2014 SGS

PERMIT

22 AUG 2014 SGS

PLAN CHECKS

△ 21 OCT 2014 CGF

△ 06 JAN 2015 CGF


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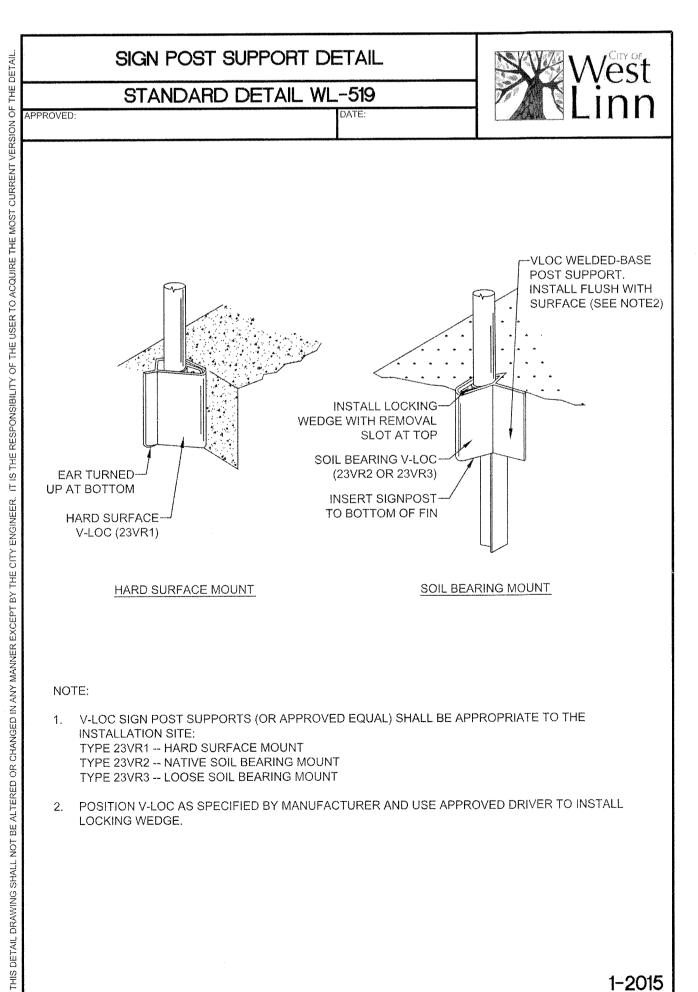
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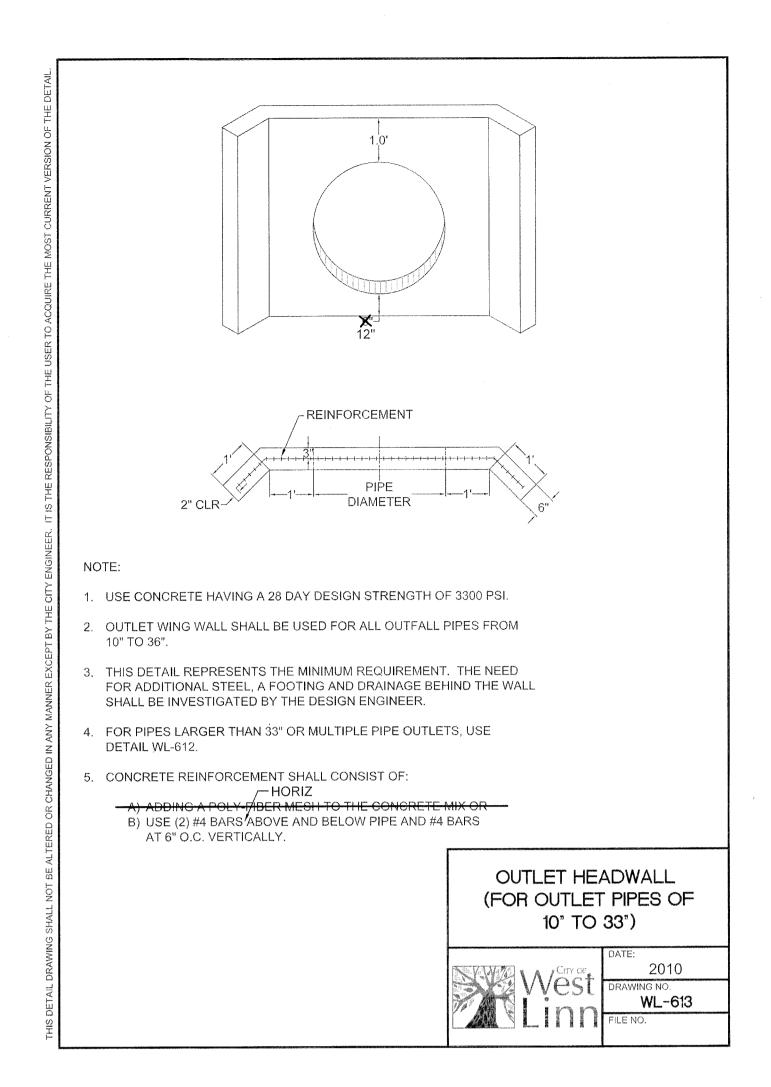
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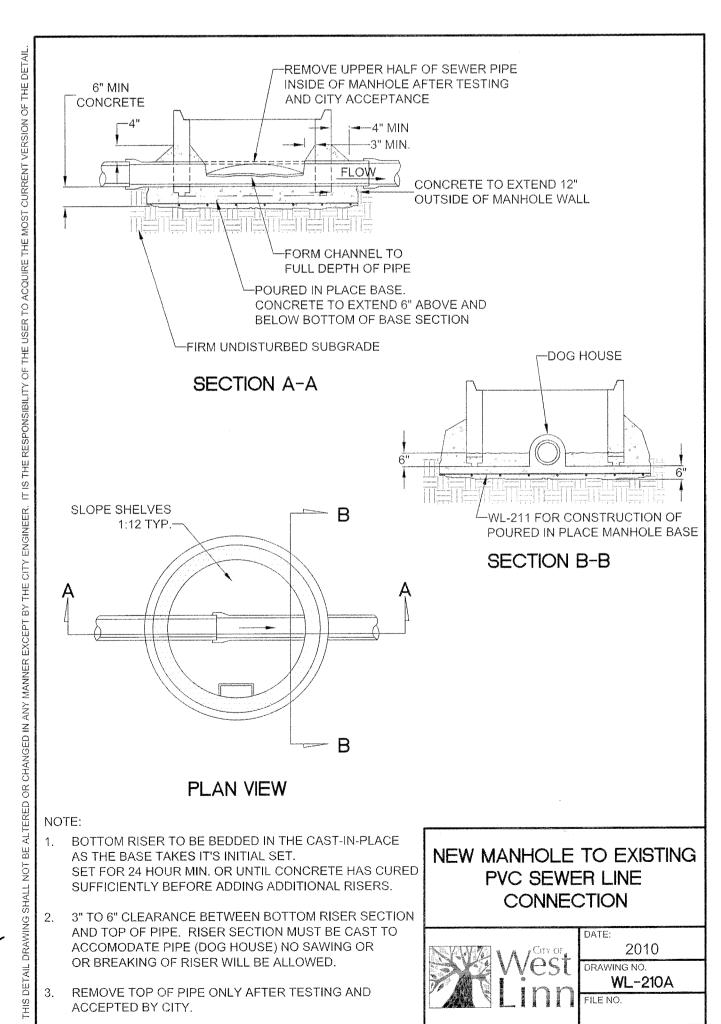
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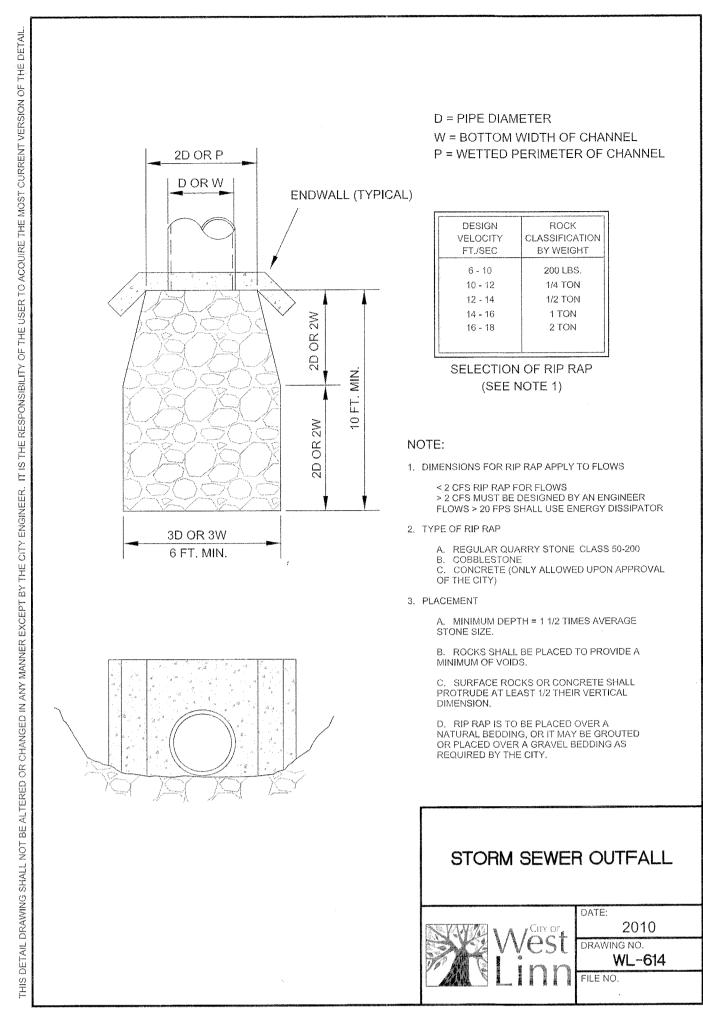
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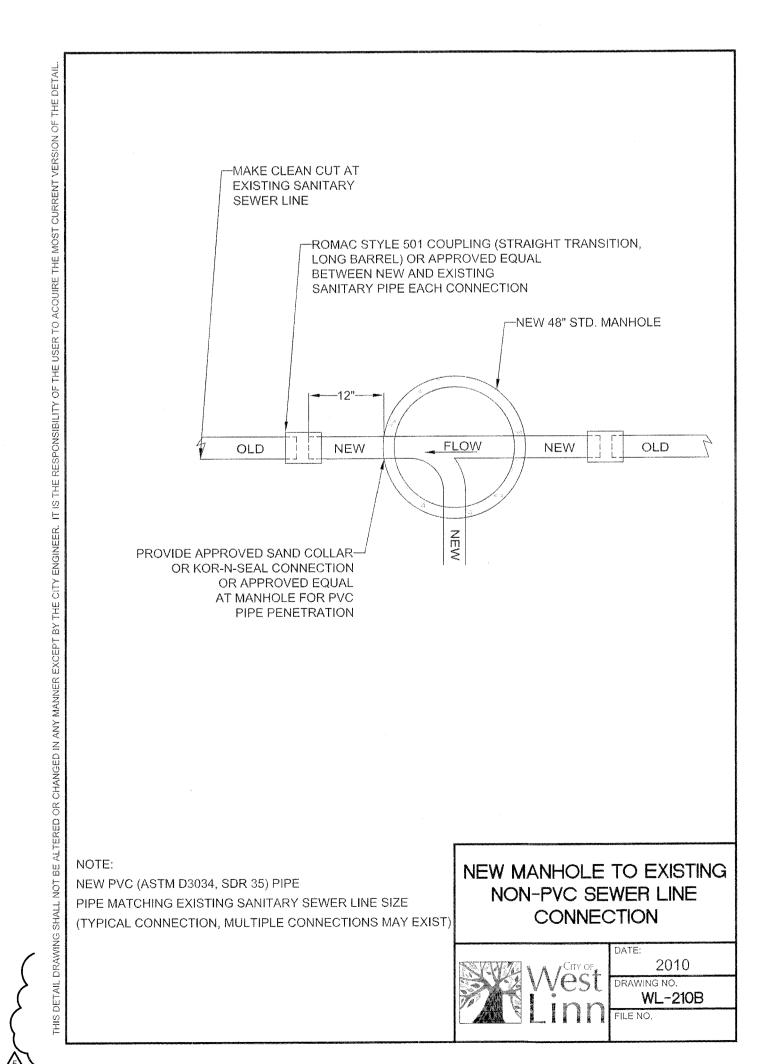











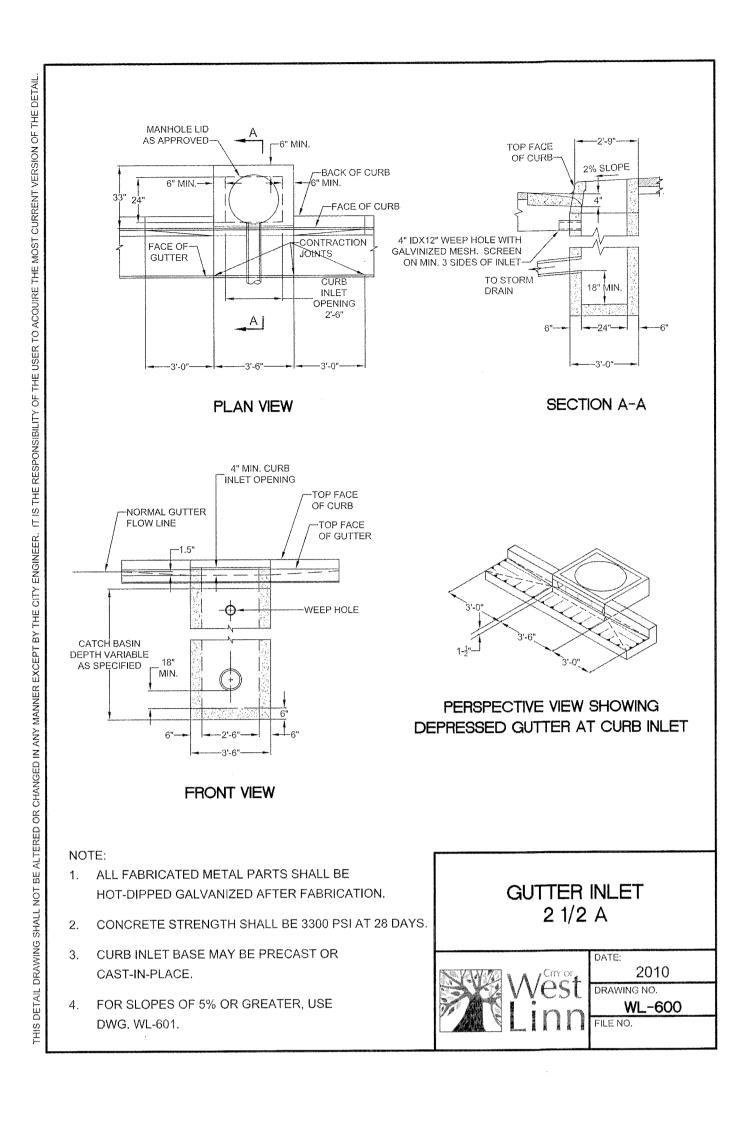

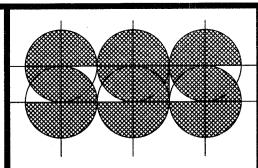

STEWART GORDON STRAUS ARCHITECT 6775 SW | | | TH AVENUE SUITE 20 BEAVERTON, OR 97008

(503) 672-7517 (OFFICE) (503) 672-7808 (FAX) sgs@s-straus.com (e-mail)

Structural · Civil Engineers 6443 SW Beaverton-Hillsdale Hwy, suite 2

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HEREIN AS A RESULT.


**PROJECT** 


NUMBER: DATE BY DRAWING DESIGN 20 NOV 2013 SGS 11 FEB 2014 SG **DES REV** 12 MAR 2014 SC PERMIT 22 AUG 2014 PLAN CHECKS

21 OCT 2014 | 06 JAN 2015 23 JAN 2015


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CIVIL DETAILS




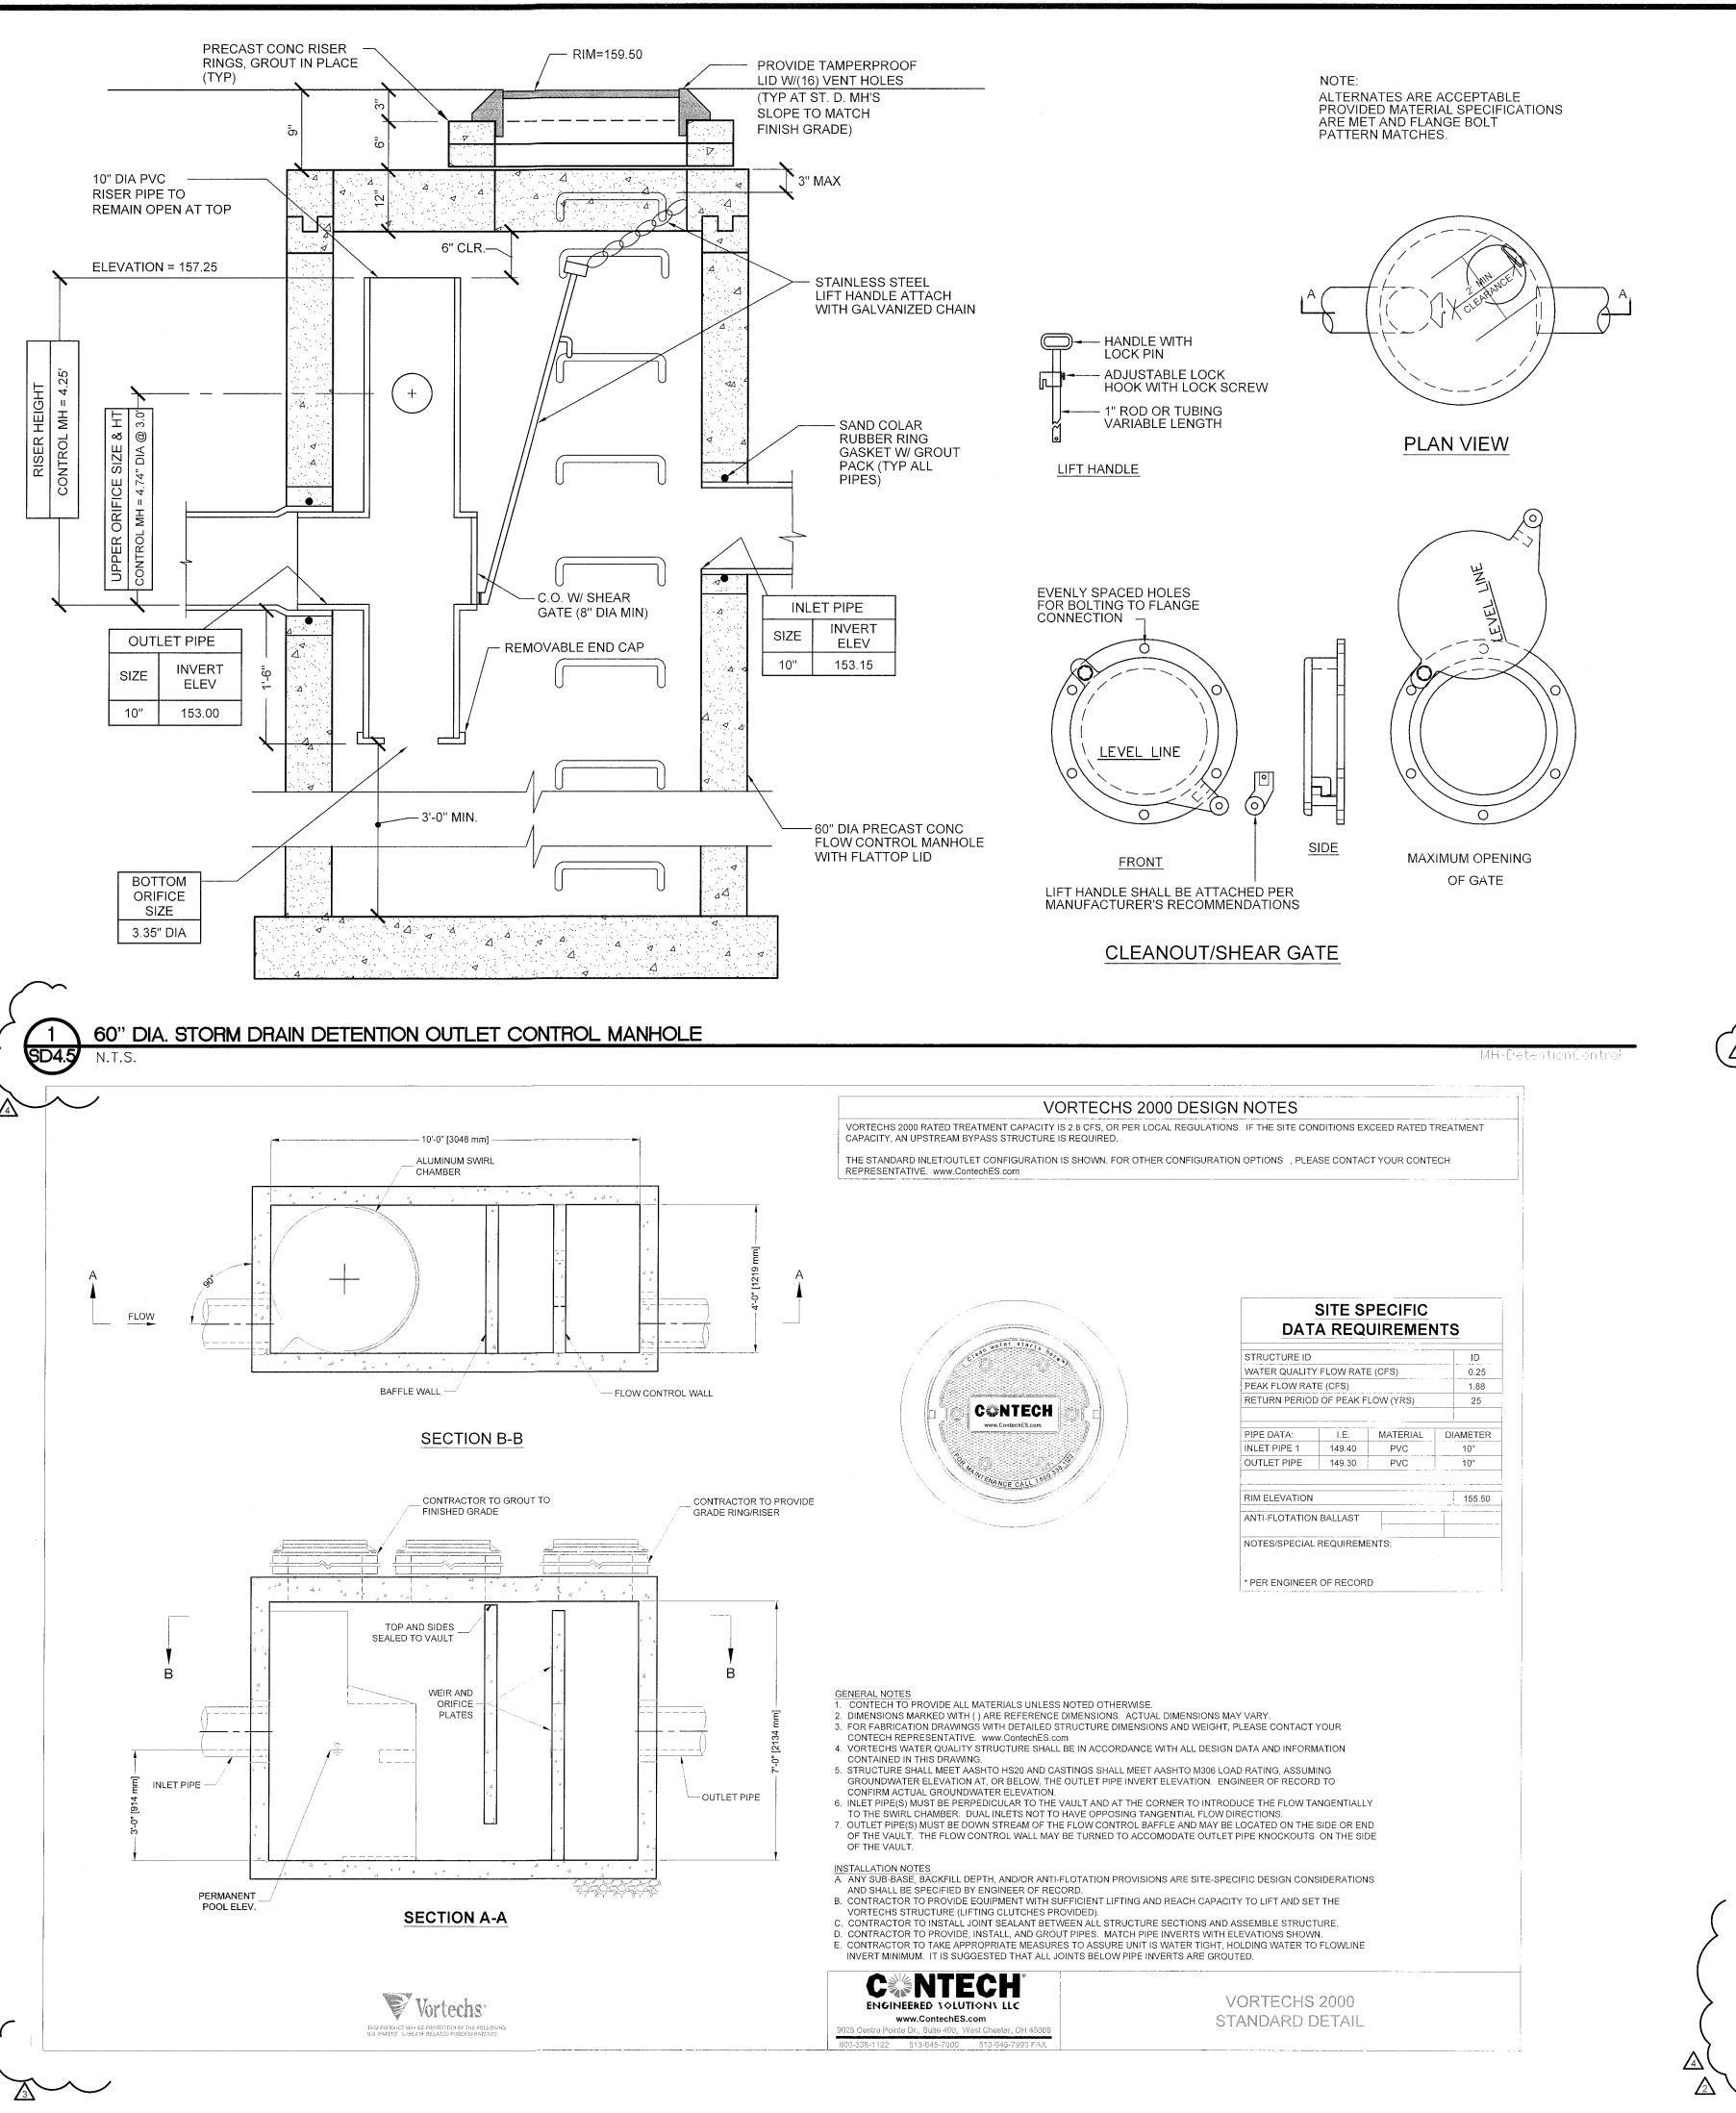

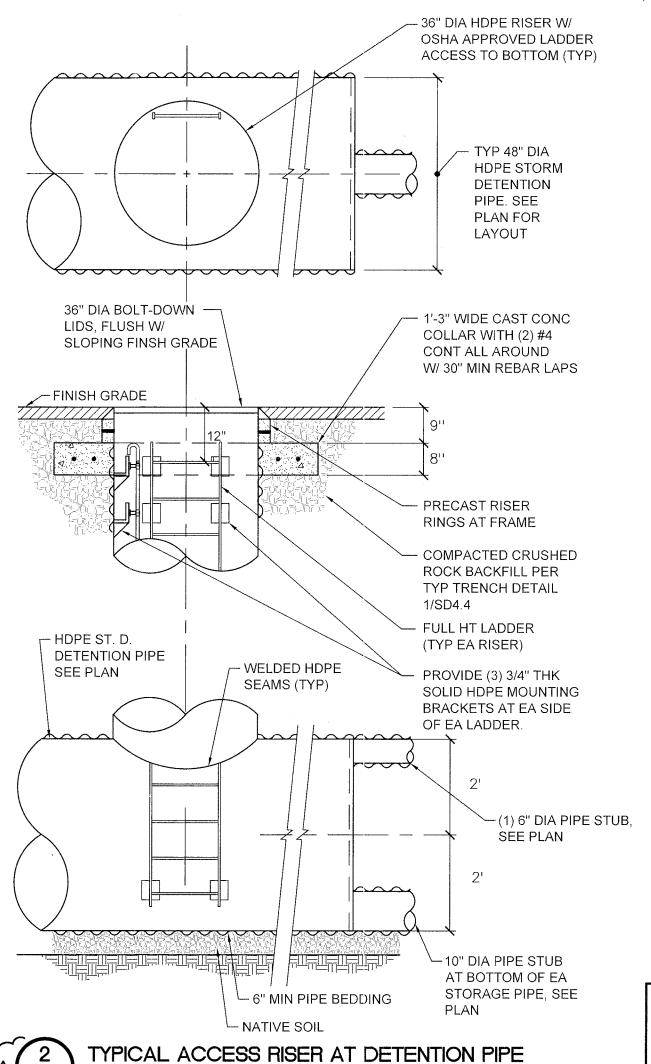NOTE: ONSITE STORM DETENTION AND TREATMENT SYSTEM TO BE INSPECTED AND APPROVED BY ENGINEERING DEPARTMENT

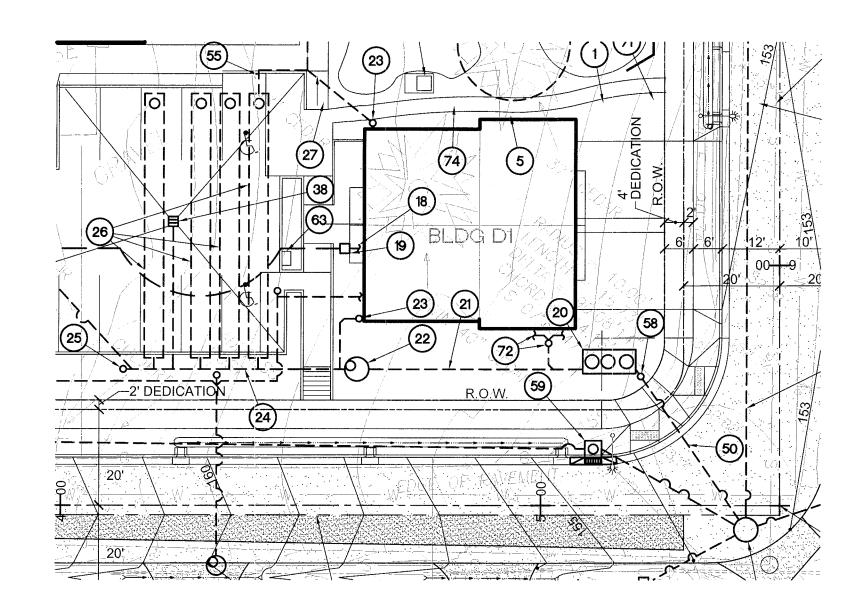

KEYNOTES FOR DETAIL 3/SD4.5					
MARK - DESCRIPTION	MARK - DESCRIPTION				
20 NEW 'CONTECH' VORTECHS STORM TREATMENT VAULT MODEL 2000, SEE DETAIL ON SD4.5 I.E. (10") IN = 150.0, I.E. (10") OUT = 149.9 21 — 46 L.F. OF 10" DIA PVC ST.D. PIPE AT 6.6% SLOPE 22 — 5' DIA ST. D. DETENTION MANHOLE, SEE 1/SD4.5 FOR DETAIL I.E.(10") IN = 153.15, I.E.(10") OUT = 153.00, RIM = 159.50 24 — 46 L.F. OF 10" DIA PVC ST. D. PIPE AT 0.25% SLOPE 25 — ST. D. C.O. ASSEMBLY, SEE 6/SD4.4, I.E. (10") = 153.30	26 — (4) ROWS OF 55 L.F. OF NEW 48" DIA HDPE ST. D. DETENTION PIPE, SEE 2/SD4.5 FOR TYP ACCESS DETAIL, BOTTOM ELEVATION = 153.30 — SEE SHT CS2.1 FOR 10" DIA ST. D. SERVICE 55 — 122 L.F. OF 6" DIA PVC ST. D. PIPE AT 1.0% SLOPE 58 — C.O. ASSEMBLY AT 100 O.C. MAX SPACING, SEE 5 OR 6 ON SD4.4				

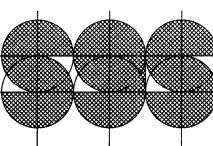

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STEWART GORDON STRAUS
ARCHITECT
6775 SW | | | TH AVENUE
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SHADY HOLLOW AND WILLAMETTE DRIVE


PROJECT NUMBER: 1335

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<u>∧</u> 23 JA	N 2015	CGP
<u> </u>	N 2015	CGP
AS-BUILT		
🛕 20 AF	°R 2015	CGP

SHEET TITLE
ONSITE CIVIL
DETAILS

SHEET #

SD4.5

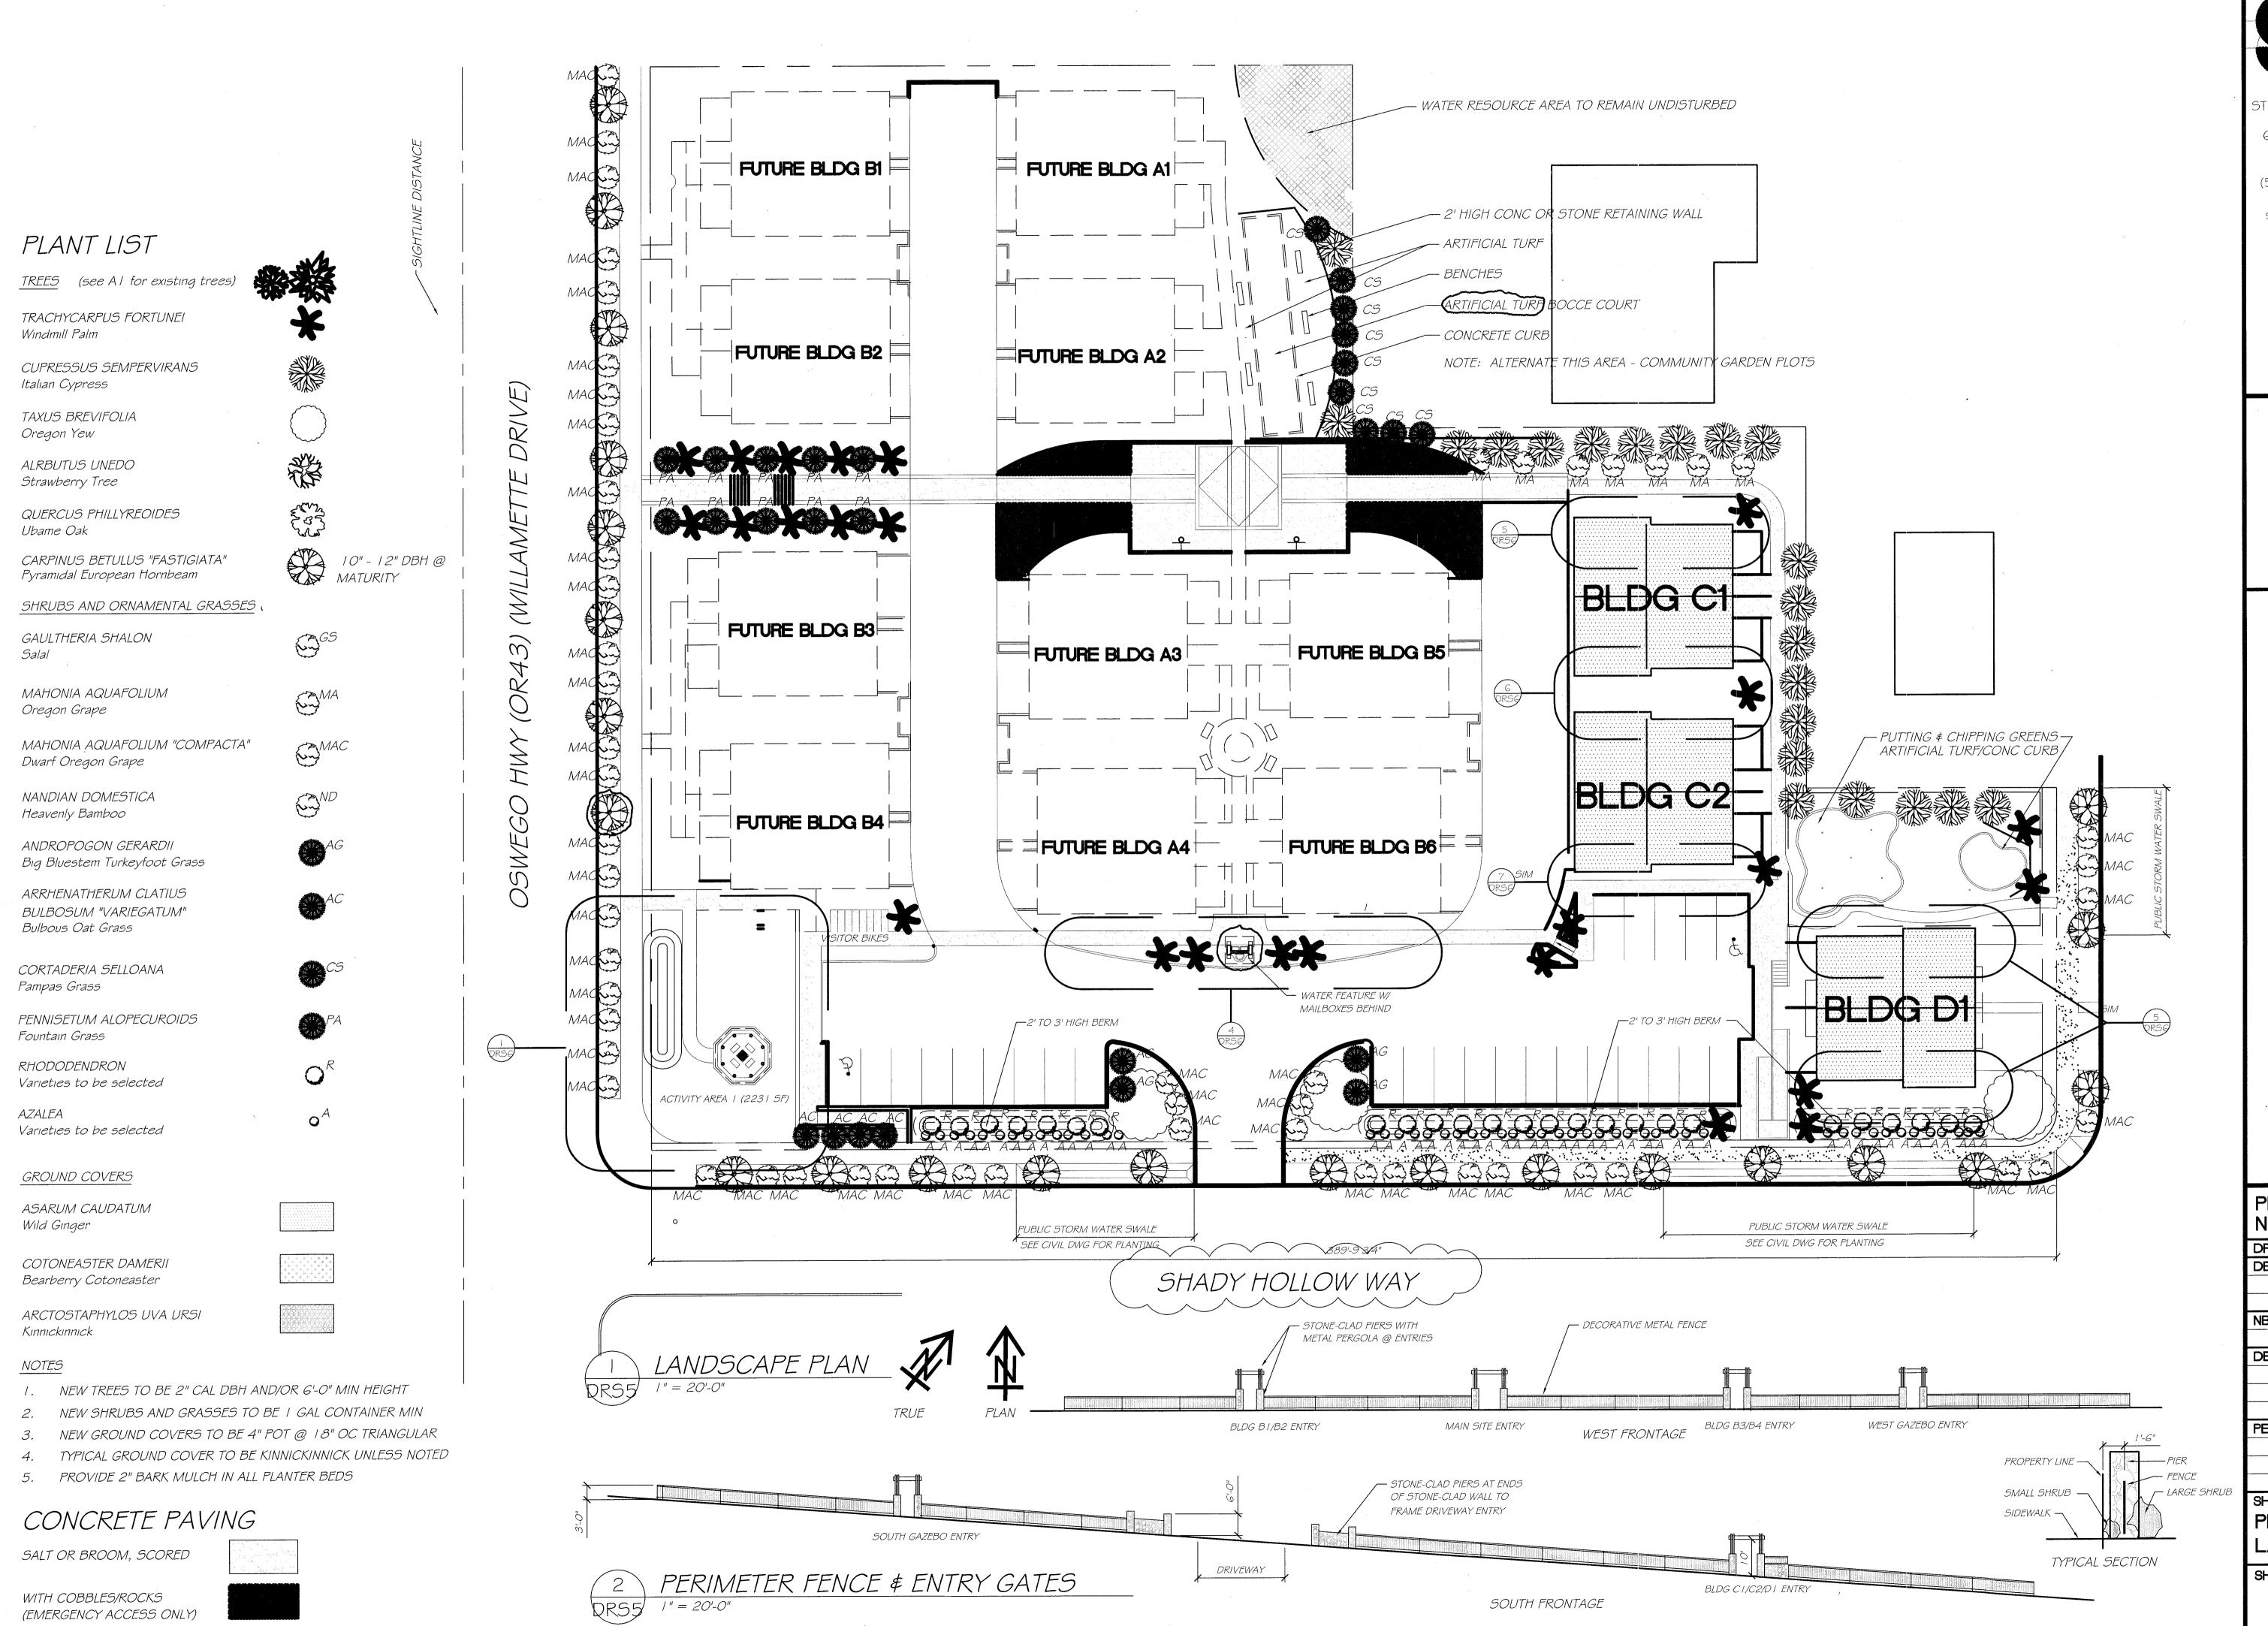

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### WEST

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PROJECT NUMBER:	PROJECT NUMBER: 130	
DRAWING	DATE	BY
DESIGN		
20 N	OV 2013	SGS
NBRHD MTG		
115	EB 2014	SGS
DES REV		
12 M	AR 2014	SGS
21 AI	PR 2014	SGS
14 M	AY 2014	SGS
PERMIT		
22 AL	JG 2014	SGS
24 FE	EB 2015	SGS
16 DI	EC 2015	SGS
PROPOSI		
LANDSC	ALE	

SHEET #

SD5